

ABBREVIATIONS

A/C	AIR CONDITIONING
ACT	ACQUISITORY CEILING TILE
ADJ	ADJUSTABLE
AFP	ABOVE FINISHED FLOOR
AMP	AMPERE
ARCH	ARCHITECT
BOH	BACK OF HOUSE
CAB	CABINET
CFMF	COLD-FORMED METAL FRAMING
CL	CENTER LINE
CLG	CEILING
CM	STARBUCKS CONSTRUCTION MANAGER
CTR	CENTER
CX	COMMISSIONING
CXA	COMMISSIONING AGENT
DEG	DEGREE
DET	DETAIL
DIA	DIAMETER
DM	STARBUCKS DESIGN MANAGER
DN	DOWN
EA	EACH
EL	ELEVATION
EQ	EQUAL
EXIST	EXISTING
EXT	EXTERIOR
FF&E	FURNITURE, FIXTURE, AND EQUIPMENT
FLR	FLOOR
FOH	FRONT OF HOUSE
FOIC	FURNISHED BY OWNER, INSTALLED BY CONTRACTOR
FOIO	FURNISHED BY OWNER, INSTALLED BY OWNER
FT	FOOT/FEET
G	GROUND
GC	GENERAL CONTRACTOR
GWB	GYPNUM WALLBOARD
HC	HOLLOW CORE
HDW	HARDWARE
HM	HOLLOW METAL
HOP	HANDOFF PLANE
HORIZ	HORIZONTAL
HR	HOUR
HT	HEIGHT
HVAC	HEATING, VENTILATING AND AIR CONDITIONING
I.D.	INSIDE DIAMETER
LEED	LEADERSHIP IN ENERGY AND ENVIRONMENTAL DESIGN
LL	LANDLORD
LV	LOW VOLTAGE
MAX	MAXIMUM
MEP	"MECHANICAL, ELECTRICAL AND PLUMBING" MANUFACTURER
MFR	MANUFACTURER
MIN	MINIMUM
MOP	MOBILE ORDER PICK UP
NIC	NOT IN CONTRACT
NL	NIGHT LIGHT
NTS	NOT TO SCALE
OC	ON CENTER
O.D.	OUTSIDE DIAMETER
PIR	PASSIVE INFRARED SENSOR
PLC	PLACE
R	RADIUS
REF	REFERENCE
REQD	REQUIRED
REV	REVISION
RND	ROUND
SB	STARBUCKS
SC	SOLID CORE
SF	SQUARE FEET
SHT	SHEET
SIM	SIMILAR
SS	SOLID SURFACING MATERIAL
SST	STAINLESS STEEL
SPEC	SPECIFICATION
SQ	SQUARE
TEMP	TEMPORARY
TYP	TYPICAL
UC	UNDER COUNTER
UNO	UNLESS NOTED OTHERWISE
VERT	VERTICAL
VIF	VERIFY IN FIELD


RESPONSIBILITY LEGEND

GC	GENERAL CONTRACTOR
LL	LANDLORD
SB	STARBUCKS
CV	CASEWORK VENDOR


ARCHITECTURAL SYMBOL LEGEND

NORTH ARROW	GRAPHIC SCALE	DATUM POINT	EXTERIOR ELEVATION CALL-OUT	INTERIOR ELEVATION CALL-OUT
SECTION CALL-OUT	DETAIL CALL-OUT	SHEET NOTE CALLOUT	ABOVE FINISH FLOOR HEIGHT TAG	FINISH FACE TO FINISH FACE DIMENSION
REVISION TAG	PAINT TAG	DESIGN ID TAG	DOOR TAG	WINDOW TAG
INTERIOR WALL TAG	INTERIOR WALL TAG	INTERIOR WALL TAG	INTERIOR WALL TAG	INTERIOR WALL TAG

AERIAL MAP

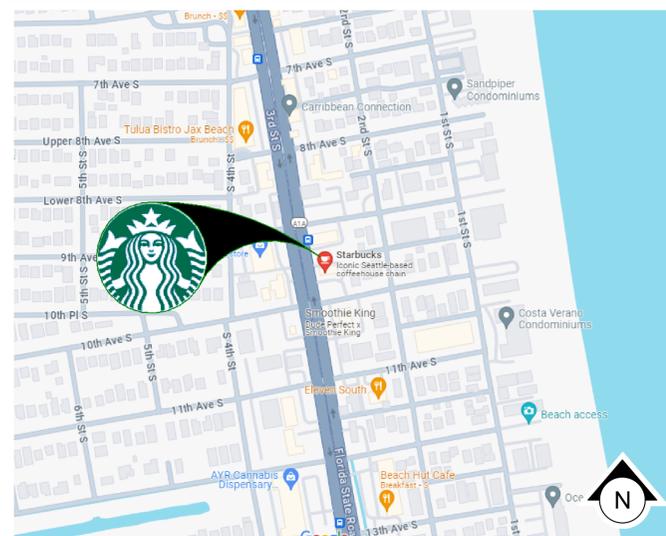

VICINITY PLAN

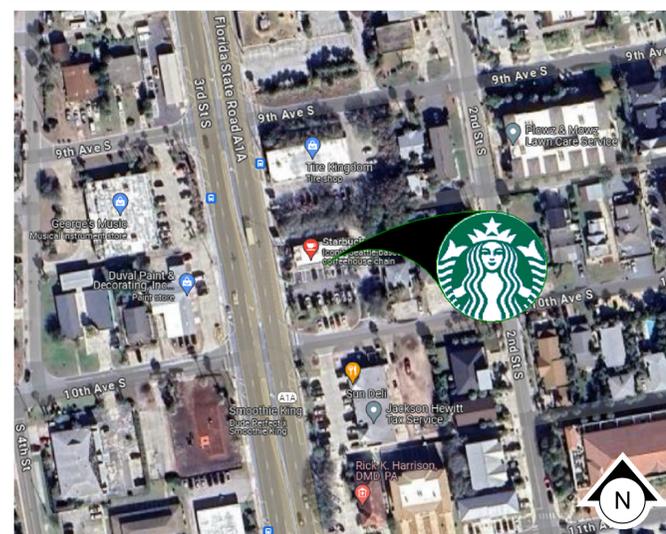

PROJECT CONTACTS

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KGIBBS@STARBUCKS.COM

LANDLORD: BUZZY GRUNTHAL
GRUNTHAL AND SCHUETH
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MEP CONSULTANT OF RECORD: RGD CONSULTING ENGINEERS
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SUITE 2000, JUPITER, FL 33477
(561) 743-0165 EXT. 116 PHONE
(561) 743-0193 FAX
CONTACT: JACLYN BROWN
JACLYN.BROWN@RGDENGINEERS.COM

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DALLAS, TX 75231, USA
(214) 432-8232 PHONE
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A-PHELPS@BNIENGINEERS.COM

GENERAL NOTES

- THE DRAWINGS AND PROJECT MANUAL TOGETHER CONSTITUTE THE CONTRACT DOCUMENTS FOR CONSTRUCTION. ALL GENERAL REQUIREMENTS ARE TO BE MET AND ALL MATERIALS, FINISHES AND SYSTEMS ARE TO BE INSTALLED AND PERFORM PER SPECIFICATIONS UNLESS OTHERWISE NOTED.
- GENERAL CONTRACTOR SHALL VISIT THE SITE, REVIEW THE BUILDING SHELL DRAWINGS AS SUBMITTED BY THE LANDLORD OR STARBUCKS AND BECOME THOROUGHLY FAMILIAR WITH THE SITE CONDITIONS PRIOR TO CONSTRUCTION.
- GENERAL CONTRACTOR SHALL CONSULT WITH STARBUCKS CONSTRUCTION MANAGER TO RESOLVE ANY CHANGES, OMISSIONS OR PLAN DISCREPANCIES PRIOR TO CONSTRUCTION.
- ALL WORK SHALL BE PERFORMED IN STRICT COMPLIANCE WITH LOCAL, COUNTY, STATE AND FEDERAL CODES AND ORDINANCES.
- GENERAL CONTRACTOR SHALL VERIFY THE LOCATION OF ALL UTILITIES.
- GENERAL CONTRACTOR TO VERIFY ALL DIMENSIONS, INCLUDING CLEARANCES REQUIRED BY OTHER TRADES AND NOTIFY STARBUCKS CONSTRUCTION MANAGER OF ANY DISCREPANCIES PRIOR TO PROCEEDING WITH THE WORK. ALL DIMENSIONS ARE TO THE FACE OF THE FINISHED SURFACE UNLESS NOTED OTHERWISE. ALL DIMENSIONS TO BE TAKEN FROM DESIGNATED DATUM POINT. DO NOT SCALE DRAWINGS.
- GENERAL CONTRACTOR SHALL PATCH AND REPAIR ALL EXISTING WALLS, FLOORS, CEILINGS, OR OTHER SURFACES IDENTIFIED TO REMAIN THAT MAY BECOME DAMAGED DURING THE COURSE OF THE WORK.
- THE GENERAL CONTRACTOR IS RESPONSIBLE FOR OBTAINING PERMITS FOR FIRE PROTECTION, PLUMBING, MECHANICAL, AND ELECTRICAL SYSTEMS PRIOR TO INSTALLATION OF SUCH SYSTEMS.
- GENERAL CONTRACTOR SHALL RETAIN ONE SET OF PERMIT PLANS ON-SITE TO DOCUMENT ALL CHANGES MADE DURING CONSTRUCTION. THE RECORD DRAWINGS SHALL BE ISSUED TO THE OWNER AT PROJECT CLOSE-OUT AS DESCRIBED IN THE GENERAL REQUIREMENTS OF THE PROJECT MANUAL.
- GENERAL CONTRACTOR IS RESPONSIBLE FOR COORDINATING DELIVERY OF MATERIALS FROM STARBUCKS CONTRACTED THIRD PARTY LOGISTICS DISTRIBUTION SERVICES AND VENDOR DIRECT SHIPMENTS. SEE THE PROJECT MANUAL FOR ADDITIONAL INFORMATION.
- RESPONSIBILITY FOR SUPPLY AND DELIVERY OF MATERIALS AND EQUIPMENT IS IDENTIFIED IN THE DRAWING SCHEDULE SHEETS UNDER THE COLUMN LABELED "RESPONSIBILITY".
- FOR THE PURPOSE OF THE DOCUMENTS, TO "INSTALL", SHALL MEAN TO PROVIDE ALL FASTENERS, MISCELLANEOUS HARDWARE, BLOCKING, ELECTRICAL CONNECTIONS, PLUMBING CONNECTIONS AND OTHER ITEMS REQUIRED FOR A COMPLETE AND OPERATIONAL INSTALLATION, UNLESS OTHERWISE NOTED.
- ALL ITEM SUBSTITUTIONS MUST BE APPROVED BY THE STARBUCKS CONSTRUCTION MANAGER.
- STARBUCKS WILL PROVIDE THE PROJECT MANUAL AND SPECIFICATIONS FOR THIS PROJECT.

APPLICABLE CODES

FLORIDA BUILDING CODES		
FBC	BUILDING, 8TH EDITION	2023
FBCEB	EXISTING BUILDING, 8TH EDITION	2023
FBCEC	ENERGY CONSERVATION, 8TH EDITION	2023
FBCEP	PLUMBING, 8TH EDITION	2023
FBCEM	MECHANICAL, 8TH EDITION	2023
NATIONAL FIRE PROTECTION ASSOCIATION		
NPFA 1	FIRE CODE, FLORIDA FIRE PREVENTION CODE, 8TH EDITION	2023
NPFA 101	LIFE SAFETY CODE, FLORIDA FIRE PREVENTION CODE, 8TH EDITION	2023
NPFA-70 (NEC)	NATIONAL ELECTRICAL CODE	2020
ACCESSIBILITY GUIDELINES		
ADA	ADA STANDARDS FOR ACCESSIBLE DESIGN BY THE U.S. DEPARTMENT OF JUSTICE	2010
FBCA	ACCESSIBILITY, 8TH EDITION	2023
ICC/ANSI 117.1	ACCESSIBLE AND USABLE BUILDINGS AND FACILITIES	2017
ADDITIONAL GUIDELINES		
ASHRAE 90.1	ANSI/ASHRAE/IES STANDARD 90.1	2016

ZONING INFORMATION

ZONING:

PARCEL NUMBER: 176130-0000

LEASABLE AREA: 2518 SQ.FT.

PROPOSED USE: RESTAURANT (COFFEE SHOP) / RETAIL SALES AND SERVICES

ZONING TYPE: C-1 (COMMERCIAL LIMITED)

JURISDICTION:

JACKSONVILLE BEACH
11 NORTH THIRD STREET,
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WWW.JACKSONVILLEBEACH.ORG/BUILDING
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904.247.6235 PHONE

DEFERRED SUBMITTALS: <LOW VOLTAGE>
<SIGNAGE>

INDEX OF SHEETS

LEGEND: X - SHEET ISSUED
R - SHEET ISSUED FOR REFERENCE AND COORDINATION ONLY
SEE TITLEBLOCK FOR REVISION ISSUE DATE(S)

SHEET	SHEET TITLE	CONST. REVIEW SET	PERMIT SET	REVISION 1	REVISION 2	REVISION 3	REVISION 4
GENERAL							
G001	GENERAL INFORMATION	X					
G002	LIFE SAFETY PLAN	X					
G003	FOOD SERVICE PLAN AND ACCESSIBILITY PLAN	X					
G004	ACCESSIBILITY GUIDELINES	X					
G004.1	ACCESSIBILITY GUIDELINES	X					
G005	PERSPECTIVE VIEWS	X					
DEMOLITION							
D101	DEMOLITION FLOOR PLAN	X					
D102	DEMO REFLECTED CEILING PLAN	X					
ARCHITECTURAL							
A101	BUILDING FLOOR PLAN	X					
A102	BUILDING FLOOR PENETRATION PLAN	X					
A401	EXTERIOR ELEVATIONS	X					
A501	WALL FRAMING DETAILS	X					
A502	BUILDING DETAILS	X					
A601	WINDOW AND DOOR SCHEDULES & DETAILS	X					
INTERIORS							
I101	FF & E PLAN	X					
I101.1	ENLARGED FF & E	X					
I102	CASEWORK PLAN	X					
I102.1	ADAPTABLE CASEWORK BASE PLAN	X					
I102.2	ADAPTABLE CASEWORK FRAMEWORK PLAN	X					
I102.3	ADAPTABLE CASEWORK CABINET PLAN	X					
I102.4	ADAPTABLE CASEWORK COUNTERTOP PLAN	X					
I103	REFLECTED CEILING PLAN	X					
I103.1	DIMENS. REFLECTED CEILING PLAN	X					
I103.2	REFLECTED CEILING PLAN REFERENCE	X					
I104	FLOOR FINISH PLAN	X					
I105	WALL FINISH PLAN	X					
I201	INTERIOR FINISH ELEVATIONS	X					
I202	INTERIOR FINISH ELEVATIONS	X					
I203	INTERIOR FINISH ELEVATIONS	X					
I204	INTERIOR FINISH ELEVATIONS	X					
I205	INTERIOR FINISH ELEVATIONS	X					
I206	INTERIOR FINISH ELEVATIONS	X					
I207	INTERIOR FINISH ELEVATIONS	X					
I401	RESTROOM PLAN & ELEVATIONS	X					
I501	ADAPTABLE CASEWORK DETAILS	X					
I501.1	ADAPTABLE CASEWORK DETAILS	X					
I502	CASEWORK DETAILS	X					
I503	CASEWORK DETAILS	X					
I504	IMPULSE FIXTURE DETAILS	X					
I505	RCP DETAILS	X					
I507	FLOOR FINISH DETAILS	X					
I508	FLOOR FINISH DETAILS	X					
I509	WALL FINISH DETAILS	X					
I510	WALL FINISH DETAILS	X					
I511	ARTWORK	X					
I511.1	ARTWORK	X					
I512	MENU DETAILS	X					
I601	CASEWORK AND FF&E SCHEDULES	X					
I602	INTERIOR FINISHES SCHEDULES	X					
STRUCTURAL							
S101	FOUNDATION PLAN	X					
S102	ROOF PLAN	X					
S501	SITE DETAILS	X					
S502	FOUNDATION DETAILS	X					
S503	WALL DETAILS	X					
ELECTRICAL							
E001	ELECTRICAL NOTES	X					
E002	ENERGY CALCULATIONS	X					
E003	ELECTRICAL SITE PLAN	X					
E101	POWER PLAN	X					
E102	LIGHTING PLAN	X					
E103	ENLARGED ELECTRICAL PLACEMENT PLAN	X					
E104	DATA DEVICE PLAN	X					
E501	ELECTRICAL DETAILS	X					
E502	ELECTRICAL DETAILS	X					
E601	ELECTRICAL PANEL SCHEDULES	X					
MECHANICAL							
M001	MECHANICAL NOTES	X					
M101	MECHANICAL DESIGN PLAN	X					
M102	MECHANICAL ROOF PLAN	X					
M501	MECHANICAL DETAILS	X					
M601	MECHANICAL SCHEDULES	X					
PLUMBING							
P001	PLUMBING NOTES	X					
P101	PLUMBING SUPPLY PLAN	X					
P102	PLUMBING WASTE & VENT PLAN	X					
P103	ENLARGED PLUMBING PLACEMENT PLAN	X					
P501	PLUMBING DETAILS	X					
P601	PLUMBING SCHEDULES	X					

DEMOLITION

D101	DEMOLITION FLOOR PLAN	X					
D102	DEMO REFLECTED CEILING PLAN	X					

ARCHITECTURAL

A101	BUILDING FLOOR PLAN	X					
A102	BUILDING FLOOR PENETRATION PLAN	X					
A401	EXTERIOR ELEVATIONS	X					
A501	WALL FRAMING DETAILS	X					
A502	BUILDING DETAILS	X					
A601	WINDOW AND DOOR SCHEDULES & DETAILS	X					

INTERIORS

I101	FF & E PLAN	X					
I101.1	ENLARGED FF & E	X					
I102	CASEWORK PLAN	X					
I102.1	ADAPTABLE CASEWORK BASE PLAN	X					
I102.2	ADAPTABLE CASEWORK FRAMEWORK PLAN	X					
I102.3	ADAPTABLE CASEWORK CABINET PLAN	X					
I102.4	ADAPTABLE CASEWORK COUNTERTOP PLAN	X					
I103	REFLECTED CEILING PLAN	X					
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I103.2	REFLECTED CEILING PLAN REFERENCE	X					
I104	FLOOR FINISH PLAN	X					
I105	WALL FINISH PLAN	X					
I201	INTERIOR FINISH ELEVATIONS	X					
I202	INTERIOR FINISH ELEVATIONS	X					
I203	INTERIOR FINISH ELEVATIONS	X					
I204	INTERIOR FINISH ELEVATIONS	X					
I205	INTERIOR FINISH ELEVATIONS	X					
I206	INTERIOR FINISH ELEVATIONS	X					
I207	INTERIOR FINISH ELEVATIONS	X					
I401	RESTROOM PLAN & ELEVATIONS	X					
I501	ADAPTABLE CASEWORK DETAILS	X					
I501.1	ADAPTABLE CASEWORK DETAILS	X					
I502	CASEWORK DETAILS	X					
I503	CASEWORK DETAILS	X					
I504	IMPULSE FIXTURE DETAILS	X					
I505	RCP DETAILS	X					
I507	FLOOR FINISH DETAILS	X					
I508	FLOOR FINISH DETAILS	X					
I509	WALL FINISH DETAILS	X					
I510	WALL FINISH DETAILS	X					
I511	ARTWORK	X					
I511.1	ARTWORK	X					
I512	MENU DETAILS	X					
I601	CASEWORK AND FF&E SCHEDULES	X					
I602	INTERIOR FINISHES SCHEDULES	X					

STRUCTURAL


S101	FOUNDATION PLAN	X					
S102	ROOF PLAN	X					
S501	SITE DETAILS	X					
S502	FOUNDATION DETAILS	X					
S503	WALL DETAILS	X					

ELECTRICAL


E001	ELECTRICAL NOTES	X					
E002	ENERGY CALCULATIONS	X					
E003	ELECTRICAL SITE PLAN	X					
E101	POWER PLAN	X					
E102	LIGHTING PLAN	X					
E103	ENLARGED ELECTRICAL PLACEMENT PLAN	X					
E104	DATA DEVICE PLAN	X					
E501	ELECTRICAL DETAILS	X					

GENERAL NOTES


- A. SECTION REFERENCES INDICATED ON THIS SHEET ARE FOR 2023 FLORIDA BUILDING CODE, ACCESSIBILITY, 8TH EDITION.
- B. THE RUNNING SLOPE OF WALKING SURFACES SHALL NOT BE STEEPER THAN 1:20. THE CROSS SLOPE OF A WALKING SURFACE SHALL NOT BE STEEPER THAN 1:48 (REF: 403.3).

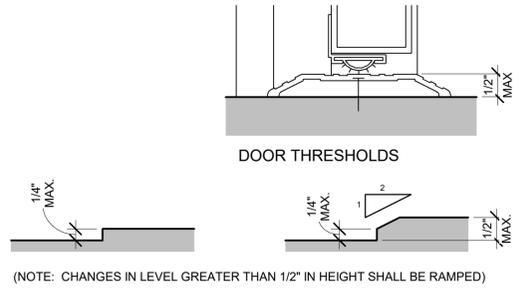


01 CHANGES IN LEVEL
Scale: 6" = 1'-0"

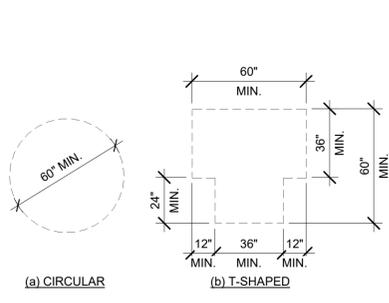


02 TURNING SPACE
Scale: 1/4" = 1'-0"

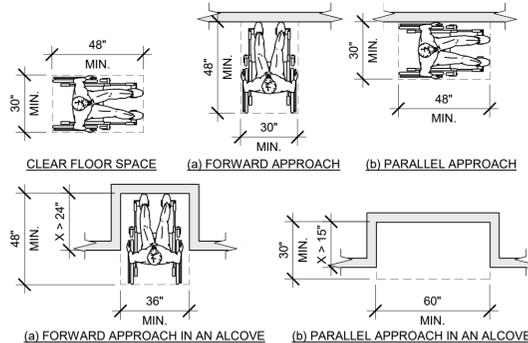


03 CLEAR FLOOR SPACE
Scale: 1/4" = 1'-0"

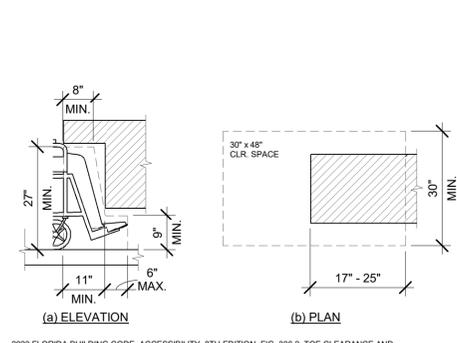


04 KNEE AND TOE CLEARANCE
Scale: 1/2" = 1'-0"

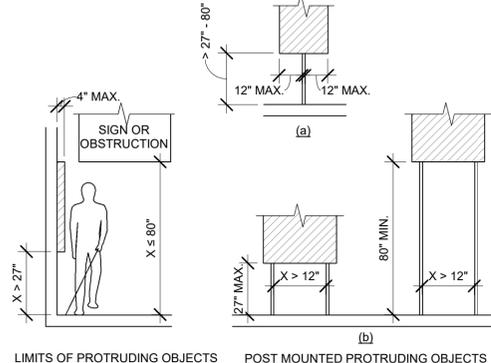


05 PROTRUDING OBJECTS
Scale: 1/4" = 1'-0"

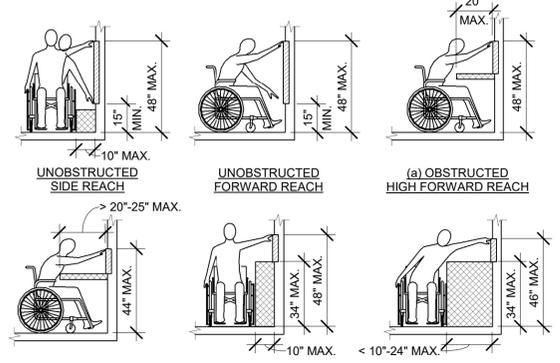


06 REACH RANGES
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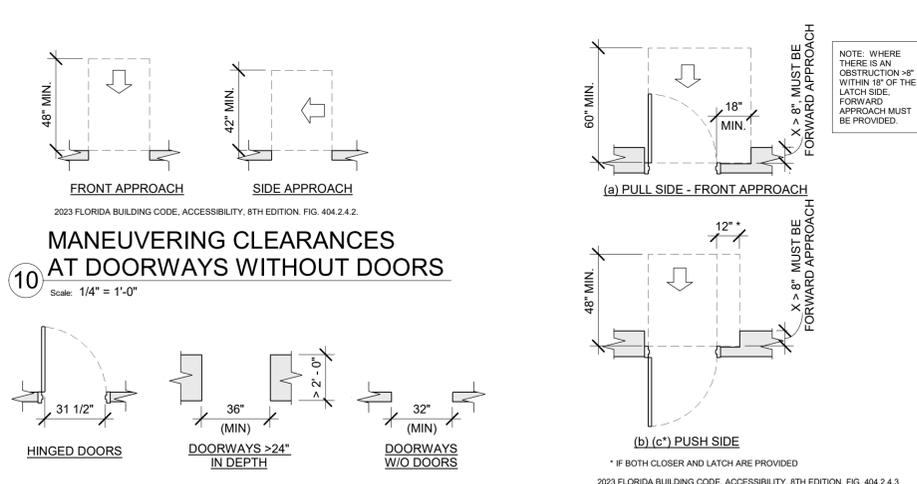
07 CLEAR WIDTH
Scale: 1/4" = 1'-0"

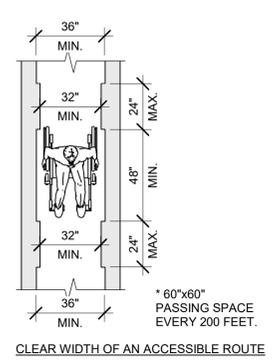


08 CLEAR WIDTH AT 180 DEGREE TURN
Scale: 1/4" = 1'-0"

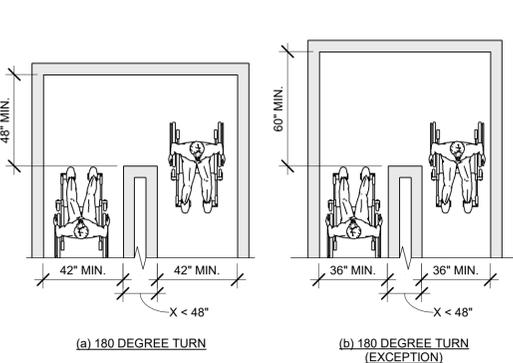


09 MANEUVERING CLEARANCES AT SWINGING DOORS
Scale: 1/4" = 1'-0"

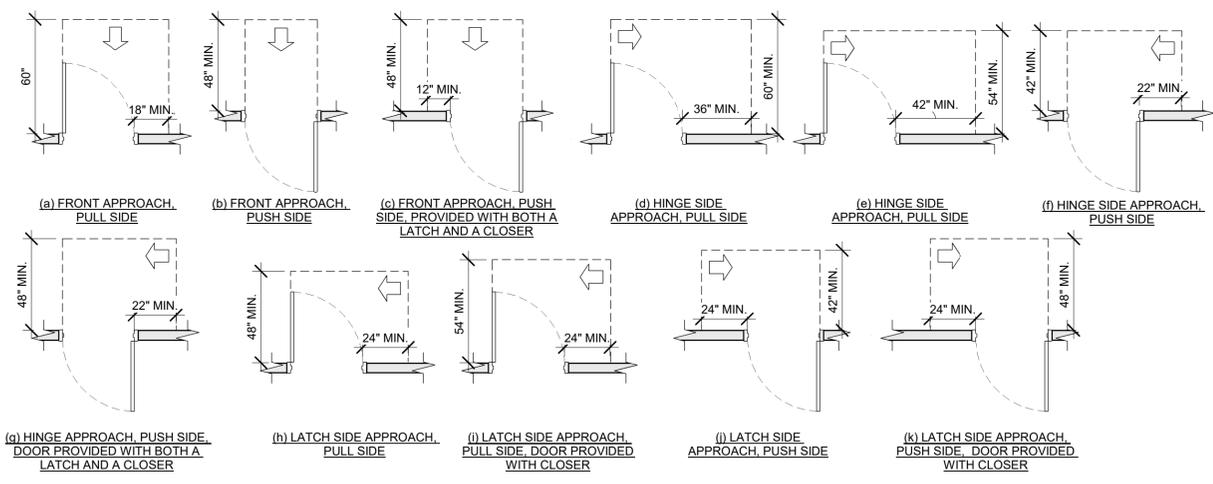


10 MANEUVERING CLEARANCES AT DOORWAYS WITHOUT DOORS
Scale: 1/4" = 1'-0"

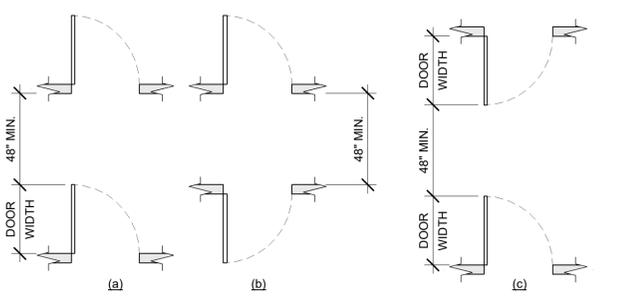

14 DOORS IN SERIES
Scale: 1/4" = 1'-0"

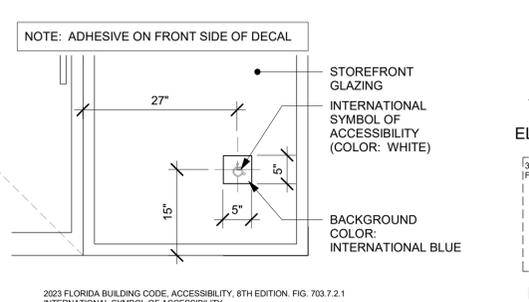


15 ACCESSIBLE STOREFRONT ENTRANCE GRAPHIC
Scale: 3/4" = 1'-0"

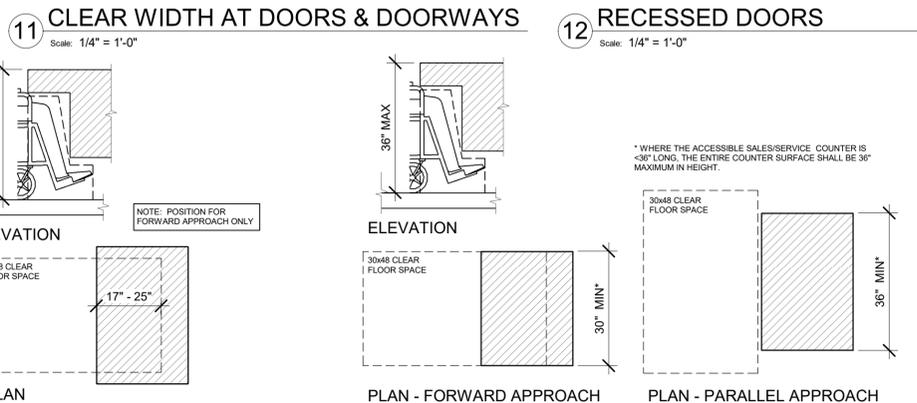


16 DINING AND WORK SURFACES
Scale: 1/2" = 1'-0"

17 SALES AND SERVICE COUNTERS
Scale: 1/2" = 1'-0"

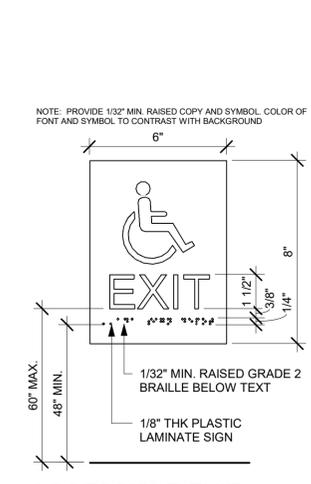

13 ACCESSIBLE EXIT SIGN / SYMBOL
Scale: 3" = 1'-0"

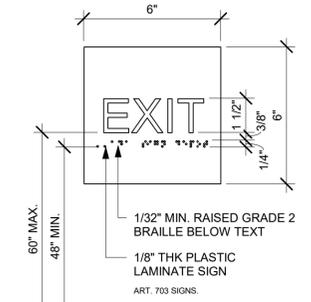

18 EXIT SIGN - STANDARD
Scale: 3" = 1'-0"



STARBUCKS
2401 UTAH AVENUE SOUTH
SEATTLE, WASHINGTON 98134
(206) 318-1575

THESE DRAWINGS AND THE PROJECT MANUAL ARE CONFIDENTIAL AND SHALL REMAIN THE SOLE PROPERTY OF STARBUCKS CORPORATION, WHICH IS THE OWNER OF THE COPYRIGHT IN THIS WORK. THEY SHALL NOT BE REPRODUCED (IN WHOLE OR IN PART), SHARED WITH THIRD PARTIES OR USED IN ANY MANNER ON OTHER PROJECTS OR EXTENSIONS TO THIS PROJECT WITHOUT THE PRIOR WRITTEN CONSENT OF STARBUCKS CORPORATION. THESE DRAWINGS AND SPECIFICATIONS ARE INTENDED TO EXPRESS DESIGN INTENT FOR A PROTOTYPICAL STARBUCKS STORE (WHICH IS SUBJECT TO CHANGE AT ANYTIME) AND DO NOT REFLECT ACTUAL SITE CONDITIONS. NEITHER PARTY SHALL HAVE ANY OBLIGATION NOR LIABILITY TO THE OTHER (EXCEPT STATED ABOVE) UNTIL A WRITTEN AGREEMENT IS FULLY EXECUTED BY BOTH PARTIES.

STARBUCKS TEMPLATE VERSION: i2024.01.01

PABLO GARCIA, AIA, REG. FL NO. AR99297

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Fax: (305) 350-7071

PROJECT NAME: **A1A & 10TH**
PROJECT ADDRESS: **975 3RD STREET SOUTH JACKSONVILLE BEACH, FL 32250**


STORE #: 8565
PROJECT #: 18756-108
ISSUE DATE: 03-27-2024
DESIGN MANAGER: ROMINA VIGNOLO
PRODUCTION DESIGNER: GENSLER
CHECKED BY: GENSLER

Revision Schedule			
Rev	Date	By	Description

SHEET TITLE: **ACCESSIBILITY GUIDELINES**
SCALE: AS SHOWN

SHEET NUMBER: **G004**


PERMIT SET - FOR CONSTRUCTION USE

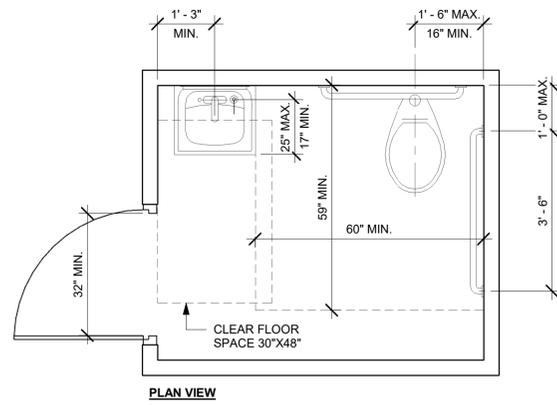

2023 FLORIDA BUILDING CODE, ACCESSIBILITY, 8TH EDITION.
604 WATER CLOSETS AND TOILET COMPARTMENTS

01 ACCESSIBLE UNISEX TOILET ROOM


Scale: 1/2" = 1'-0"

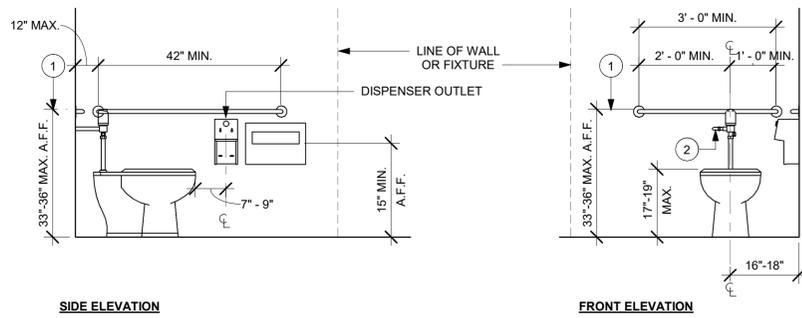

SIDE ELEVATION

FRONT ELEVATION


NOTE:
1. GRAB BARS SHALL BE INSTALLED IN A HORIZONTAL POSITION, 33 INCHES (840 MM) MINIMUM AND 36 INCHES (915 MM) MAXIMUM ABOVE THE FINISH FLOOR MEASURED TO THE TOP OF THE GRIPPING SURFACE. (FBCA 609.4)
2. FLUSH CONTROLS SHALL BE HAND OPERATED OR AUTOMATIC. HAND OPERATED FLUSH CONTROLS SHALL COMPLY WITH 309. FLUSH CONTROLS SHALL BE LOCATED ON THE OPEN SIDE OF THE WATER CLOSET EXCEPT IN AMBULATORY ACCESSIBLE COMPARTMENTS COMPLYING WITH 604.8.2. (FBCA 604.6)

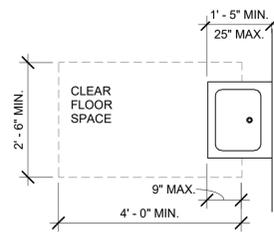

PLAN VIEW


03 SINK OR VANITY

Scale: 1/2" = 1'-0"

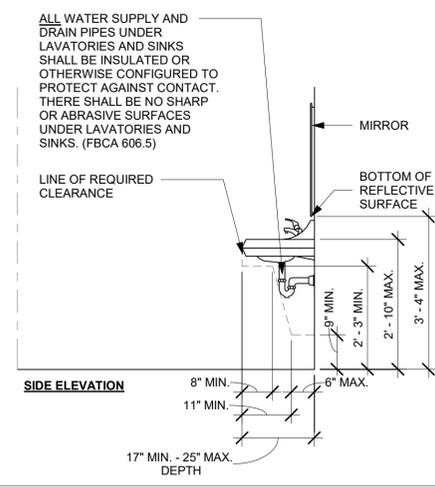

SIDE ELEVATION

ALL WATER SUPPLY AND DRAIN PIPES UNDER LAVATORIES AND SINKS SHALL BE INSULATED OR OTHERWISE CONFIGURED TO PROTECT AGAINST CONTACT. THERE SHALL BE NO SHARP OR ABRASIVE SURFACES UNDER LAVATORIES AND SINKS. (FBCA 606.5)

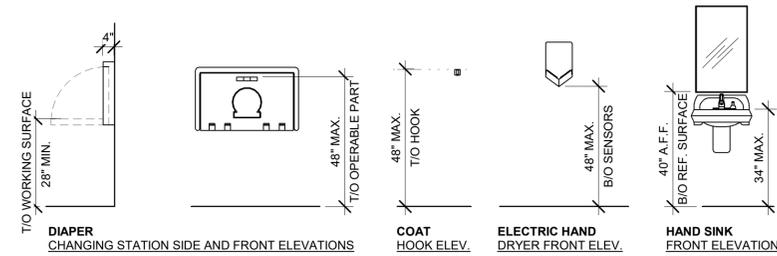

04 MOUNTING HEIGHTS FOR RESTROOM ACCESSORIES

Scale: 3/8" = 1'-0"

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STARBUCKS TEMPLATE VERSION: i2024.01.01

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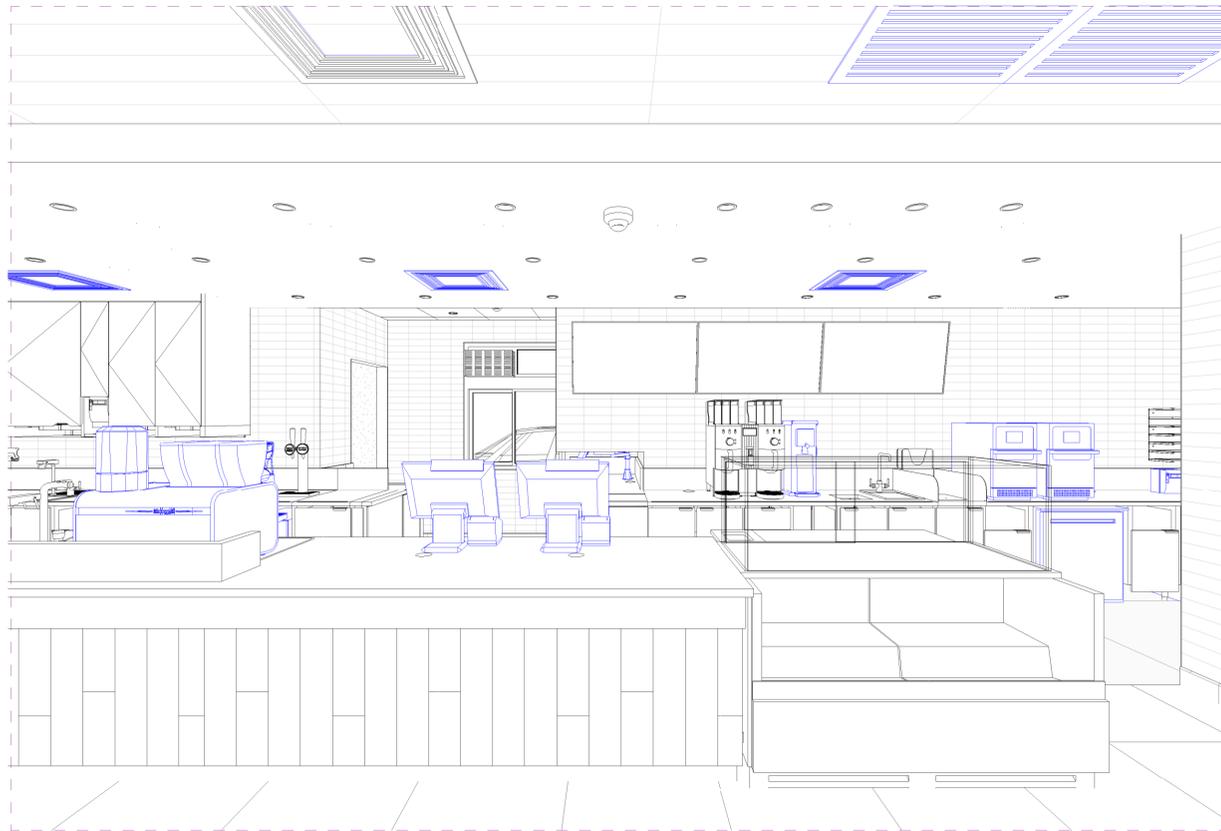
PROJECT ADDRESS:
**975 3RD STREET SOUTH
JACKSONVILLE BEACH, FL
32250**

STORE #: 8565
PROJECT #: 18756-108
ISSUE DATE: 03-27-2024
DESIGN MANAGER: ROMINA VIGNOLO
PRODUCTION DESIGNER: GENSLER
CHECKED BY: GENSLER

Revision Schedule			
Rev	Date	By	Description

SHEET TITLE:
**ACCESSIBILITY
GUIDELINES**
SCALE: AS SHOWN

SHEET NUMBER:
G004.1



3D View 1

Scale:



3D View 2

Scale:



3D View 3

Scale:



3D View 4

Scale:



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Revision Schedule			
Rev	Date	By	Description

SHEET TITLE:
PERSPECTIVE VIEWS

SCALE: AS SHOWN

SHEET NUMBER:
G005

PERMIT SET - FOR CONSTRUCTION USE

ITEMS TO PRESERVE AND RELOCATE

RELOCATED (EXISTING) SPECIALTY EQUIPMENT SCHEDULE - "E"			
DESIGN ID	COUNT	DESCRIPTION	COMMENTS
COOLING			
10267	2	FRIDGE UNDERCOUNTER 1 DOOR - 27IN 685MM	
12618	2	FRIDGE UNDERCOUNTER 1 DOOR WITH SHELF - 27IN 685MM	
EQUIPMENT			
10808	1	GRINDER DITTING KR1203	
12508	2	BLENDER QUIET MODEL ON COUNTER	
19742	2	ESPRESSO MACHINE MASTRENA II	
20032	2	OVEN EIKON E2S - BLACK	
21679	1	NITROGEN GENERATOR ELEMENT COMPACT	
STORAGE			
10416	2	WORKROOM SHELVING - 36IN 915MM	
17264	1	ROLLING PASTRY TRAY THAW RACK - 20X26IN 510X660MM	

RELOCATED (EXISTING) DATA DEVICES		
COUNT	DESCRIPTION	COMMENTS
AUDIO VISUAL		
1	DT COMMUNICATION SYSTEM	
1	DT TIMER SYSTEM	
1	DT DIGITAL PRODUCTION MONITOR	PART OF RETAIL IT EQUIPMENT PACKAGE
1	DT POS MONITOR ARM TRIPLE SURFACE MOUNTED	PART OF RETAIL IT EQUIPMENT PACKAGE
DATA		
4	IOT MODULE	
POINT OF SALE		
2	POS - REGISTER WITH COMPACT CASH DRAWER	
3	POS PRINTER	
6	POS BANK	
3	CUP LABELER	
1	POS - DT TENDERING REGISTER	PART OF RETAIL IT EQUIPMENT PACKAGE
1	POS - DT EXPEDITOR	PART OF RETAIL IT EQUIPMENT PACKAGE
SECURITY		
1	SAFE RH - 20X18X26IN 510X455X660MM	
1	SAFE BASE	

LEGEND

- EXISTING ITEM/EQUIPMENT TO BE REMOVED
- EXISTING AREA TO BE REMOVED
- EXISTING WALL TO BE REMOVED
- EXISTING ITEM/EQUIPMENT TO BE REUSED
- EXISTING ITEM/EQUIPMENT TO REMAIN
- ADJACENT TENANT

NOTE: LEGEND IS DEPENDENT ON COLORS USED FOR COMPLETE SCOPE INFORMATION.

ITEMS TO DEMOLISH

- FRONT BAR**
ALL CASEWORK
(1) SINK UTENSIL RINSE
(1) FAUCET DOUBLE LAVATORY
(1) FAUCET HOT WATER DISPENSER
(1) FAUCET WATER TOWER 12 IN
(1) ICE BIN DROP IN
(1) FOOD CASE ZEPHYR
(1) PASTRY TRAY CART 41 IN
(1) BUSING CART
(1) DOUBLE DOOR UC FRIDGE
- BACK BAR**
ALL CASEWORK
(1) SINK UTENSIL RINSE
(1) FAUCET DOUBLE LAVATORY
(1) FAUCET HOT WATER DISPENSER
(1) FAUCET WATER TOWER 12 IN
(1) FAUCET DIPPERWELL
(1) BREWER - DOUBLE
(3) BREWER - SINGLE
(1) SINK RINSE DROP IN
(1) FAUCET DOUBLE LABORATORY WITH BENT RINSE SPOUT
(2) COUNTER HAND SINK 15 IN
(1) COOLING KEG DISPENSER SYSTEM
(1) DRAIN GRATE HALF SQUARE - 12 IN
(1) DOUBLE DOOR UC FRIDGE
(1) NITRO TRAP
- DT POS**
ALL CASEWORK
(1) SINK RINSE DROP IN
(1) FAUCET SINGLE LAVATORY WITH SWING
(1) ICE BIN DROP IN
- EXTERIOR**
(5) CHAIR LOUNGE HANS MOTTED GREY WEAVE
(3) TABLE OCCASIONAL SIDE CAMERON
(12) CHAIR CAFE PYRAMID
(4) UMBRELLA WITHOUT BALANCE 6FT GREEN CANVAS
(4) UMBRELLA BASE
(6) TABLE CAFE METAL PEDESTAL
- WORKROOM**
ALL DATA EQUIPMENT AT MANAGER'S DESK
(1) MANAGER'S DESK
(2) CHAIR CAFE JULIE
(1) FILE CABINET 2 DRAWER
(1) ROLLING PASTRY TRAY
(1) STORAGE LOCKER
(1) TABLE COFFEE BASE
(1) TABLE TOP SQUARE
(1) MOP SINK EQUIPMENT
(1) WATER FILTRATION SYSTEM EQUIPMENT

- CAFE SEATING/RETAIL**
ALL EXISTING FRAMED ARTWORK
(39) CHAIR CAFE JULIE
(2) CHAIR STOOL BAR HEIGHT FINN
(4) CHAIR LOUNGE MANGO
(3) TABLE OCCASIONAL SIDE WING
(1) TABLE COMMUNITY CAFE HEIGHT
(2) CHAIR LOUNGE MODERN SLAT
(2) TABLE T BASE END
(1) TABLE T BASE CENTER
(1) TABLE TOP COMMUNITY
(13) TABLE TOP SQUARE 24 IN
(1) CAFE MERCH BAY
(1) CONDIMENT CART
(1) CAFE MERCH BAY

KEYED NOTES

- 01 DEMOLISH MENU BOARDS ABOVE.
- 02 DEMOLISH UPPER CUBBIES.
- 03 DEMOLISH BACKBAR CERAMIC WALL TILE. PATCH AND PREPARE SURFACE FOR INSTALLATION OF NEW CERAMIC WALL TILE.
- 04 FLOOR SINKS TO BE DEMOLISHED. CAP-OFF/RE-ROUTE PLUMBING LINES AND FILLED DEMOLISHED, AND/OR REPAIR AS REQUIRED. REFER TO SHEET A102 FOR NEW FLOOR SINKS LOCATION.
- 05 REMOVE EXISTING HARDWARE AND PREP. FOR NEW HARDWARE.
- 06 WALK-OFF MAT TO BE DEMOLISHED. PREP SURFACE FOR INSTALLATION OF NEW WALK-OFF MAT.
- 07 SAW TRENCHES INTO THE CONCRETE SLAB TO ACCOMMODATE THE NEW FRONT STORE EQUIPMENT, ACCORDING TO THE PROJECT REQUIREMENTS.
- 08 CUT TRENCH INTO THE CONCRETE SLAB TO CREATE SPACE FOR WIRE CONDUITS NEEDED FOR THE DOOR HARDWARE, AS PER SCHEDULE.
- 09 REMOVE EXISTING SCONCES ABOVE MIRRORS. PRESERVE

GENERAL NOTES

- A. IF DURING DEMOLITION CONDITIONS ARE REVEALED THAT MAY JEOPARDIZE INTEGRITY OF STRUCTURE OR PRECLUDE FOLLOWING DESIGN INTENT, GENERAL CONTRACTOR TO NOTIFY STARBUCKS CONSTRUCTION MANAGER IMMEDIATELY.
- B. GC IS RESPONSIBLE FOR SITE INVESTIGATION PRIOR TO DEMOLITION TO REVEAL FULL SCOPE OF WORK. NOTIFY STARBUCKS CONSTRUCTION MANAGER IF EXISTING CONDITIONS DEVIATE FROM CONSTRUCTION DOCUMENTS.
- C. REMOVE EXISTING INTERIOR WALL FINISH AS SHOWN. PATCH, REPAIR AND PREP. SUBSTRATE TO RECEIVE NEW FINISH. REMOVE WALL COVERINGS ON EXISTING WALLS TO REMAIN THAT FACE AREAS OF DEMOLITION. REMOVE SHALL INCLUDE ANY RESIDUAL MATERIAL AFTER DEMOLITION, (I.E. PIECES OF WALL COVERING OR BACKING). REMOVAL OF ALL COVERINGS IS TO BE DONE W/O DAMAGING THE EXISTING WALL SURFACE TO REMAIN. ALSO REMOVE WALL DEVICES AND ITEMS MOUNTED TO WALLS.
- D. REMOVE EXISTING FLOORING AS SHOWN. PATCH, REPAIR AND PREP. SUBSTRATE TO RECEIVE NEW FINISH. REMOVAL OF EXISTING FLOORING INCLUDES, BUT IS NOT LIMITED TO REMOVAL OF EXISTING CERAMIC TILE, CARPET OR VINYL TILE FLOORING AND ASSOCIATED WALL BASE. SUBFLOOR TO BE STRIPPED OF ALL COVERING/FINISH AND CLEANED TO REMOVE EXISTING ADHESIVE, GROUT, MORTAR, DIRT AND COATINGS. FINAL SURFACE TO BE STREAK-FREE WITH NO MACHINE MARKS AND/OR SMOOTH, STABLE AND LEVEL. PROVIDE LEVELING WHERE NECESSARY TO ACCOMMODATE NEW FINISHES.
- E. DEMOLITION PLANS REPRESENT APPROXIMATE LOCATION OF EXISTING WALLS TO BE DEMOLISHED. FIELD VERIFY TYPE OF CONSTRUCTION AND HEIGHT OF WALLS. PLANS DO NOT NECESSARILY INDICATE ALL DEMO WALLS, COUNTERS, HANDRAILS, WALL PROTECTION, CLOSETS, SINKS ETC. PRIOR TO DEMOLITION, FIELD VERIFY THAT WALLS TO BE REMOVED DO NOT PROVIDE SUPPORT FOR EXISTING BUILDING ELEMENTS AND EXISTING CONSTRUCTION TO REMAIN. NOTIFY STARBUCKS CONSTRUCTION MANAGER IF DEMOLITION WALLS SUPPORT EXISTING BUILDING ELEMENTS.
- F. DEMOLISH AND REMOVE DOORS, VINYL BASE, CONDUIT, WIRING, DUPLEXES, DATA OUTLETS, CABLES, SHELVING, METAL STUD AND GYPSUM BOARD WALLS, CLOSETS, CABINETS, FILES, COUNTERS, WOOD MOLDING, SHELVES AND ENCLOSURES WHERE APPLICABLE.
- G. VERIFY WITH STARBUCKS CONSTRUCTION MANAGER ACCESS TO THE DEMOLITION AREA, INGRESS AND EGRESS ROUTES FOR MATERIAL AND EQUIPMENT.
- H. PROTECT EXISTING FLOORS, WALLS AND CORNERS TO REMAIN ALONG WORK ACCESS ROUTES.
- I. CONTAIN DUST AND DEBRIS WITHIN THE DEMOLITION AREA.

GENERAL NOTES

- J. GC SHALL PERFORM WORK IN A MANNER THAT DOES NOT DAMAGE THE EXISTING STRUCTURE. DEMOLITION SHALL NOT COMPROMISE THE STRUCTURAL INTEGRITY OF ANY WALLS, FLOORS, CEILINGS, SUPPORTS, STRUCTURE, ETC. TO REMAIN.
- K. ALL DEMOLITION MATERIALS AND DEBRIS SHALL BE DISPOSED OF ACCORDING TO FEDERAL, STATE AND LOCAL REGULATIONS.
- L. AT LOCATIONS WHERE EXISTING WALLS ARE TO BE REMOVED NEAR EXISTING WALLS TO REMAIN, PERFORM DEMOLITION WITHOUT DISTURBING EXISTING ELEMENTS TO REMAIN. WALLS TO REMAIN SHALL BE INTACT AND HAVE A NEAT SURFACE.
- M. REFER TO "ITEMS TO BE SALVAGED" LIST FOR ITEMS THAT SHALL BE SALVAGED FOR RELOCATION. VERIFY WITH OWNER FOR ON SITE STORAGE LOCATION OF SALVAGED ITEMS.
- N. DAMAGED FIREPROOFING SHALL BE REPAIRED/ REPLACED TO MATCH EXISTING.
- O. GC SHALL DEMOLISH ANY EXISTING ABANDONED VOICE/DATA CABLING AND DEAD OR NON-USE ELECTRICAL BACK TO PANEL. ALL RECEPTACLES NOT REUSED ARE TO BE REMOVED, PATCHED AND PAINTED.
- P. REMOVAL OF LOW VOLTAGE EQUIPMENT, PERTAINING TO DATA/COMMUNICATIONS AND TELEPHONE SHALL BE VERIFIED BY THE STARBUCKS CONSTRUCTION MANAGER PRIOR TO REMOVAL. SALVAGED EQUIPMENT SHALL BE STORED IN A CLIMATE CONTROLLED ENVIRONMENT FOR FUTURE INSTALLATION. CAP ALL UTILITIES AND/OR REMOVE TO PANEL UNO.
- Q. LABEL ALL ITEMS AND PROPERLY STORE FOR RE-INSTALL.
- R. REMOVE EXISTING PLUMBING FIXTURES AND HVAC EQUIPMENT AS NECESSARY. CAP LINES AND TERMINATE DUCTS AS NECESSARY FOR THOSE NOT BEING RE-USED. CAP-OFF/RE-ROUTE PLUMBING LINES AND FILLED DEMOLISHED, REMOVED AND/OR REPAIR AS REQUIRED.
- S. REMOVE CERAMIC TILE AND BASE THROUGHOUT CAFE AND RESTROOMS. PATCH AND PREPARE FOR NEW FINISHES. REMOVE RESTROOMS TOILET ACCESSORIES.
- T. REMOVE FLOOR TILE AND TILE BASE AT ENGINE AND BOH, AND PREPARE FLOOR SURFACE FOR INSTALLATION OF NEW POLYVINYL FLOOR FINISH.
- U. REMOVE CHAIR RAIL AND WAINSCOT THROUGHOUT CAFE. PATCH AND PREPARE WALL FOR NEW FINISH.
- V. DEMOLISH ALL INTERIOR AND EXTERIOR FURNITURE, ARTWORK, MILLWORK, SHELVES, WIRE RACKS, CASEWORK CABINETS, COUNTERTOPS, DIEWALL, FINISH PANELS, ICE BINS, HANGING DEVICES, AND FASTENERS AS SHOWN THROUGHOUT CAFE. REMOVE ASSOCIATED ELECTRICAL AND DATA LINES. CAP EXISTING PLUMBING. UNO.
- W. RELOCATE EXISTING ICE MACHINE INTO ANOTHER STORE. COORDINATE WITH CONSTRUCTION MANAGER/FACILITIES MANAGER. UNO.

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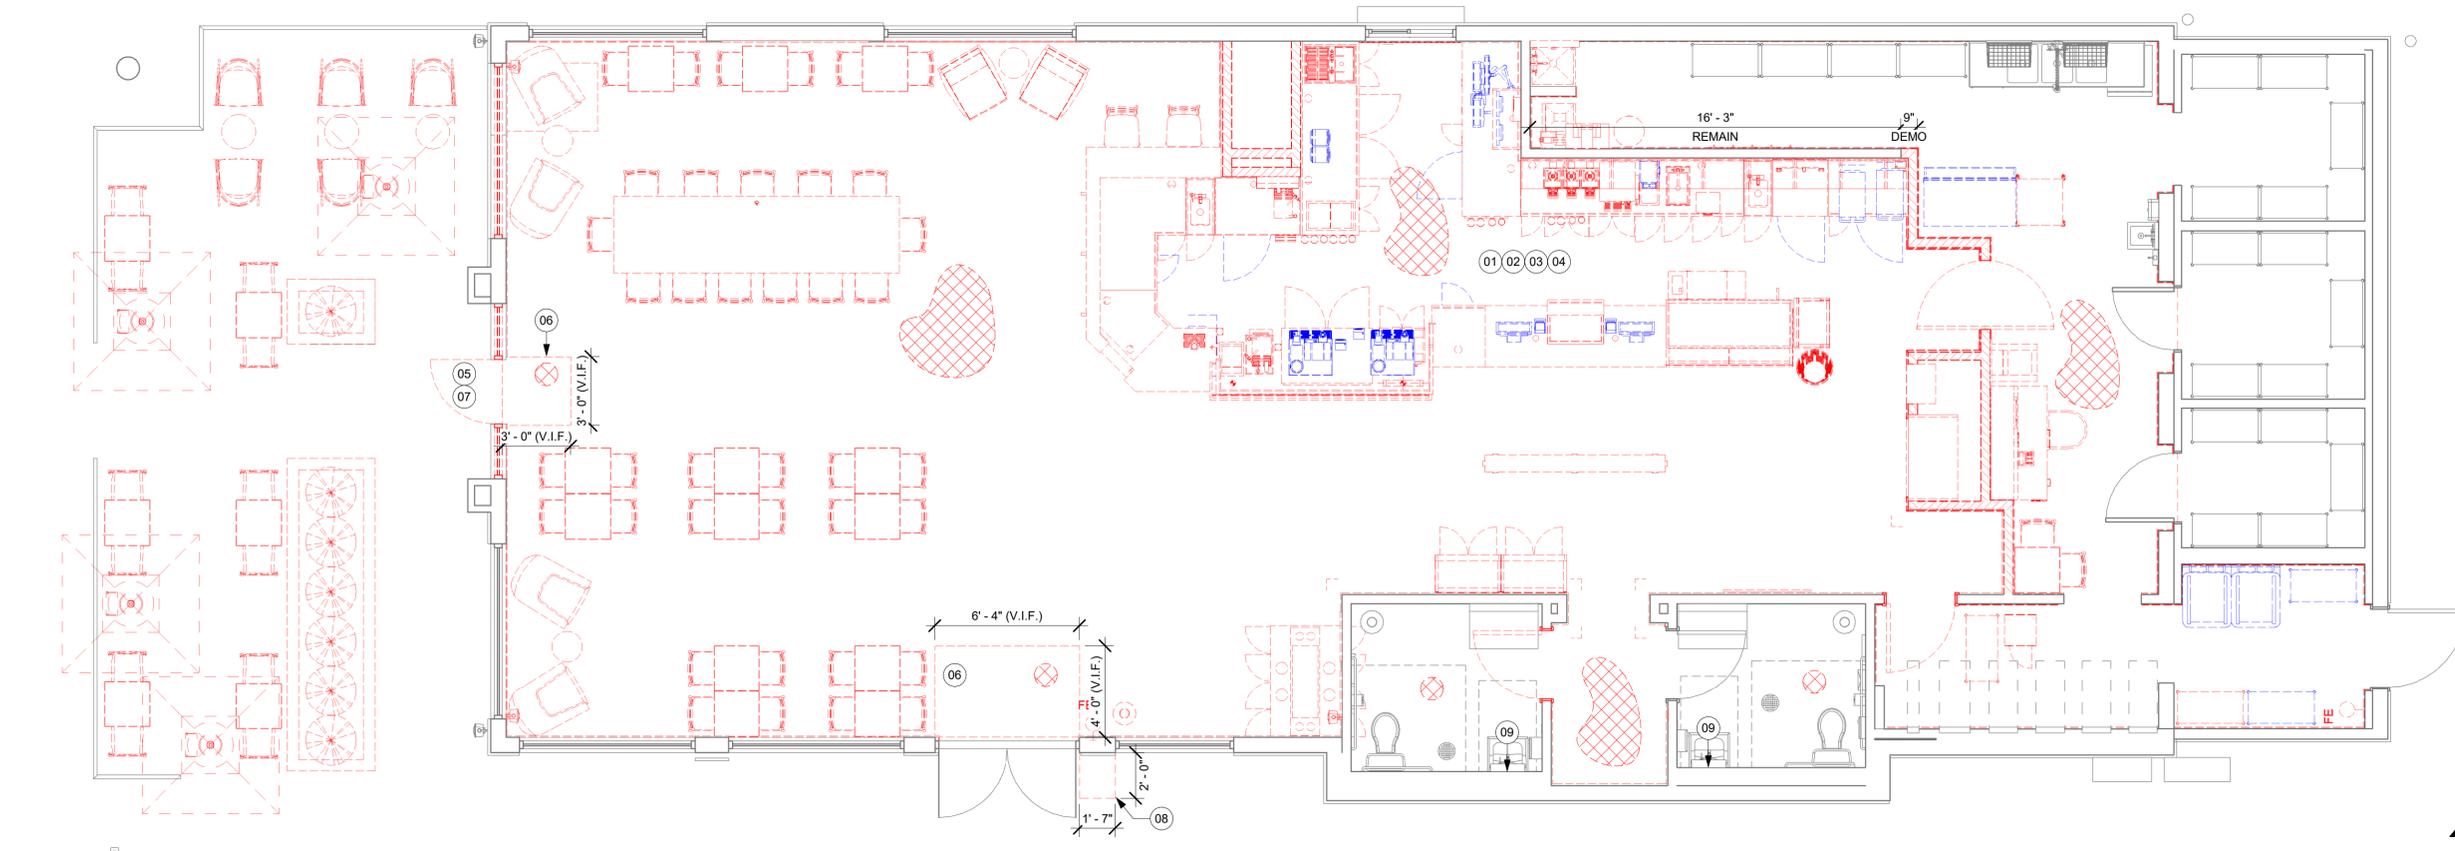
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STORE #: 8565
PROJECT #: 18756-108
ISSUE DATE: 03-27-2024
DESIGN MANAGER: ROMINA VIGNOLO
PRODUCTION DESIGNER: GENSLER
CHECKED BY: GENSLER

Revision Schedule			
Rev	Date	By	Description

SHEET TITLE:
**DEMOLITION FLOOR
PLAN**
SCALE: AS SHOWN

SHEET NUMBER:
D101



01 DEMOLITION PLAN
Scale: 1/4" = 1'-0"



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Revision Schedule			
Rev	Date	By	Description

SHEET TITLE:
**DEMO REFLECTED
CEILING PLAN**
SCALE: AS SHOWN

SHEET NUMBER:
D102

KEYED NOTES

- 02 DEMOLISH GYP CEILING, FRAMING AND ASSOCIATED FASTENERS TO BOTTOM OF STRUCTURE ABOVE.
- 03 DEMOLISH ACT CEILING, FRAMING AND ASSOCIATED FASTENERS TO BOTTOM OF STRUCTURE ABOVE.
- 04 DEMOLISH WALL SPEAKERS, LV CABLING AND ASSOCIATED FASTENERS.
- 05 DEMOLISH EMERGENCY EXIT SIGNAGE.
- 06 HVAC SYSTEMS TO REMAIN. GC TO PRESERVE AND PROTECT DURING DEMOLITION AND CONSTRUCTION.
- 07 SALVAGE WIFI EQUIPMENT FOR RELOCATION.
- 08 DEMOLISH RESTROOM SCONCES. CAP OFF/RE-ROUTE POWER FEED.
- 09 DEMOLISH WINDOW BLINDS.

GENERAL NOTES

- A. IF DURING DEMOLITION CONDITIONS ARE REVEALED THAT MAY JEOPARDIZE INTEGRITY OF STRUCTURE OR PRECLUDE FOLLOWING DESIGN INTENT, GENERAL CONTRACTOR TO NOTIFY STARBUCKS CONSTRUCTION MANAGER IMMEDIATELY.
- B. REMOVE EXTRANEOUS EQUIPMENT AS NECESSARY.
- C. EXISTING SPRINKLERS TO REMAIN OPERATIONAL DURING CONSTRUCTION. REMOVE SPRINKLER HEADS / PIPING AND SALVAGE FOR REUSE. SPRINKLER MODIFICATIONS UNDER SEPARATE PERMIT / DEFERRED SUBMITTAL.
- D. DEMOLISH AND REMOVE SUSPENDED ACOUSTIC LAY-IN, SPLINE OR GYPSUM / PLASTER CEILING INCLUSIVE OF HANGERS AND CARRYING CHANNELS, WIRES, CABLES, CONDUIT, ADHERED CEILING TILES, FLEX CONDUIT, ELECTRICAL BOXES, SMOKE DETECTORS, LIGHT FIXTURES AND WIRING. DUCT WORK, PIPING AND SUPPORT HANGERS. CUT HANGERS FLUSH. SPACES RECEIVING WALL DEMOLITION WILL ALSO HAVE CEILING DEMOLITION UNLESS OTHERWISE NOTED.
- E. REMOVAL OF LOW VOLTAGE EQUIPMENT, PERTAINING TO DATA/ COMMUNICATIONS AND TELEPHONE SHALL BE VERIFIED BY STARBUCKS CONSTRUCTION MANAGER PRIOR TO REMOVAL. SALVAGED EQUIPMENT SHALL BE STORED IN A CLIMATE CONTROLLED ENVIRONMENT FOR FUTURE INSTALLATION.
- F. REMOVE ROLLER SHADES THROUGHOUT CAFE. UNO.
- G. REMOVE ALL LIGHTING THROUGHOUT CAFE AS INDICATED. UNO.

LEGEND

- EXISTING ITEM/EQUIPMENT TO BE REMOVED
- EXISTING AREA TO BE REMOVED
- EXISTING WALL TO BE REMOVED
- EXISTING ITEM/EQUIPMENT TO BE REUSED
- EXISTING ITEM/EQUIPMENT TO REMAIN

NOTE: LEGEND IS DEPENDENT ON COLORS USED FOR COMPLETE SCOPE INFORMATION.

- TRACK LIGHTING
- RECESSED CAN LIGHT
- GENERAL PENDANT LIGHTING FIXTURE
- TROFFER
- EXIT SECURITY LIGHT
- EXIT SIGN/ EMERGENCY LIGHTING COMBO
- SMOKE DETECTOR
- 360° SECURITY CAMERA
- SUPPLY AIR
- RETURN AIR
- WALL MOUNTED SPEAKER
- WALL SCONCE AT RESTROOM
- WIFI ACCESS POINT (WAP)
- AIR CURTAIN
- (E) 2'X2' ACT SUSPENDED CEILING SYSTEM
- (E) 2'X4' ACT SUSPENDED CEILING SYSTEM



01 DEMOLITION REFLECTED CEILING PLAN
Scale: 1/4" = 1'-0"

PERMIT SET - FOR CONSTRUCTION USE

INTERIOR WALL SCHEDULE			
TAG	DESCRIPTION	INSULATION	NOTES
1-T-N	1 1/2" 20 GA STUD FURRING WALL	NONE	TERMINATE 6" ABOVE CEILING. SEE PLAN FOR WALL SHEATHING.
2-T-N	3 5/8" 20 GA STUDS @ 16" O.C. FURRING WALL	NONE	TERMINATE 6" ABOVE CEILING. SEE PLAN FOR WALL SHEATHING.
3-T-N	3 5/8" 20 GA STUDS @ 16" O.C.	NONE	FULL METAL STUDS FROM HEADER UP TO DECK. PROVIDE 45 DEGREE BRACING AT 48" O.C FROM 1/3 MID SPAN TO DECK ABOVE.
4-T-N	6" 20 GA STUDS @ 16" O.C.	NONE	TERMINATE 6" ABOVE CEILING. PROVIDE 45 DEGREE METAL STUD BRACING AT 48" O.C. FROM STUD WALL TO STRUCTURE ABOVE. SEE PLAN FOR WALL SHEATHING.
6-T-N	3 5/8" 20 GA STUDS @ 16" O.C.	NONE	TERMINATE 6" ABOVE CEILING. FULL METAL STUDS FROM HEADER UP TO DECK. PROVIDE 45 DEGREE METAL STUD BRACING AT 48" O.C. FROM 1/3 MID SPAN TO DECK ABOVE. SEE PLAN FOR WALL SHEATHING.

WALL BLOCKING KEY

SYMBOL	ITEM	WEIGHT	HEIGHT A.F.F.	APPROX. WIDTH
A	WORKROOM HAND SINK	128 LBS (58 KG)	36" TO 40" (915MM TO 1015MM)	30" (760MM) BEHIND SINK
B	SHELVES ABOVE COMPARTMENT SINK	200 LBS (91 KG)	48" TO 76" (1220MM TO 1930MM)	96" (2440MM) CENTERED ABOVE COMPARTMENT SINK
C	UPPER WIRE SHELVES	BLOCKING SPECIFICATION TO BE PROVIDED BY VENDOR		
D	SHELVES AT MANAGER'S DESK	300 LBS (136 KG)	32" TO 96" (810MM TO 2440MM)	48" (1220MM) 3/4 (19MM) ACX PLYWOOD, CENTERED ON SHELVES
E	EQUIPMENT RACK AT MANAGER'S DESK	300 LBS (136 KG)	44" TO 96" (1120MM TO 2440MM)	28" (710MM) 3/4 (19MM) ACX PLYWOOD, CENTERED ON RACK
F	RESTROOM GRAB BARS	200 LBS (91 KG)	30" TO 36" (760MM TO 915MM)	60" (1525MM) AROUND WATER CLOSET
G	RESTROOM HAND SINK	200 LBS (91 KG)	COMMERCIAL INSTALLATION REQUIRES CONCEALED ARM CARRIER. REFER TO MFR'S SPECIFICATION.	
H	MILLWORK BOXES	BLOCKING SPECIFICATION FOR FRENCH CLEATING SYSTEM. REFER TO DETAILS.		
I	DIAPER CHANGING STATION	250 LBS (113 KG)	40 1/2" TO 46 1/2" (1030MM TO 1180MM)	32" (810MM) BEHIND STATION
J	UPPER CBE SHELVING	BLOCKING SPECIFICATION FOR CBE METAL SHELVES. REFER TO VENDOR'S SPECIFICATION AND DETAILS.		
K	WATER FILTRATION SYSTEM	TBD BY VENDOR	COORDINATE LOCATION AND EXTENT WITH PENTAIR	
L	RESTROOM HAND DRYER	200 LBS (91 KG)	36" TO 48" (915MM TO 1219MM)	24" STARTING 18" FROM WALL CORNER / SEE PLAN
M	ADAPTABLE CASEWORK	BLOCKING SPECIFICATION FOR ADAPTABLE CASEWORK. REFER TO VENDOR'S SPECIFICATION AND DETAILS.		
N	ALL ARTWORK, FIXTURES, ACCESSORIES AND CASEWORK FABRICATIONS NOT OTHERWISE NOTED	TBD BY VENDOR (VARIES)	GC TO PROVIDE WALL BLOCKING AS REQUIRED FOR ALL ITEMS FOR A COMPLETE AND SECURE INSTALLATION. EXTEND BLOCKING 8" (205MM) BEYOND ON EACH SIDE OF EACH ITEM.	

WALL SHEATHING KEY

SYMBOL	DESCRIPTION
▲	INDICATES SHEATHING TRANSITION
A	5/8" GYP. WALL BOARD (FULL WALL HEIGHT)
B	5/8" GYP. WALL BOARD (TERMINATE AT 6" (150MM) ABOVE CEILING)
C	5/8" CEMENTITIOUS BACKER BOARD (TERMINATE AT 6" (150MM) ABOVE CEILING)
D	5/8" CEMENTITIOUS BACKER BOARD (TERMINATE AT FINISH TRANSITION AS SHOWN ON INTERIOR ELEVATION W/ 5/8" GYP. WALL BOARD ABOVE (FULL WALL HEIGHT)).
E	5/8" PLYWOOD (TERMINATE AT 6" (150MM) ABOVE CEILING)

KEYED NOTES

- EXISTING STOREFRONT DOOR. GC TO ENSURE PROPER WORKING ORDER AND REPAIR AS NECESSARY. REPLACE HARDWARE AS SHOWN IN MAIN ENTRANCE.
- EXISTING STOREFRONT WINDOW SYSTEM. GC TO PROTECT DURING CONSTRUCTION. CLEAN TO "LIKE NEW" CONDITION AND REPAIR AS NECESSARY.
- SHELF FOR WATER HEATER ABOVE.
- ELECTRICAL PANEL LOCATIONS. MAINTAIN MINIMUM CLEARANCE AS REQUIRED BY CODE.
- OUTLINE OF HEADER ABOVE.
- OUTLINE OF BAR PER CASEWORK MANUFACTURER. FOR THE BACK BAR, PROVIDE 3/4" BLOCKING TO 34" AFF FOR ALL WALL BRACKETS TO SUPPORT CASEWORK LEGS.
- BANQUETTES WITH POWER. REFER TO DETAIL.
- NEW CONCRETE FILL TO LEVEL FLOOR SLAB AS REQUIRED FOR INSTALLATION. TO BE ALIGNED WITH EXISTING FLOOR FINISH. IF APPLICABLE. REFER TO STRUCTURAL FOR CONNECTION OF NEW SLAB TO EXISTING.
- OUTLINE OF SOFFIT ABOVE.
- EXISTING LL FURR OUT (6"). LL TO COORDINATE INTERIOR FACE OF WALL WITH SHEATHING AS INDICATED.
- PATCH AND REPAIR WALL AFTER ELECTRICAL / PLUMBING WALL MODIFICATIONS.
- RECESSED WALK OFF MATT. CAST-IN RECESSES AS REQUIRED. REFER TO FLOOR FINISH PLAN.
- INSTALL NEW STORE FRONT WINDOW PORTION. SEE EXTERIOR ELEVATION FOR ADDITIONAL INFORMATION.


GENERAL NOTES

- GENERAL CONTRACTOR TO VERIFY ALL DIMENSIONS AND NOTIFY STARBUCKS CONSTRUCTION MANAGER OF ANY DISCREPANCIES PRIOR TO CONSTRUCTION. ALL DIMENSIONS TO BE TAKEN FROM DESIGNATED DATUM POINT.
- GENERAL CONTRACTOR TO PROVIDE FIRE TREATED 2X WOOD BLOCKING OR EQUIVALENT FOR COMPLETE AND SECURE SUPPORT OF ANY WALL MOUNTED EQUIPMENT, CABINETRY, FURNISHINGS, ARTWORK AND/OR SIGNAGE.
- IF EXISTING EXTERIOR ENTRANCE THRESHOLD EXCEEDS MINIMUM BARRIER FREE PROVISION OF THE CODE, REMOVE AND REPLACE WITH ACCESSIBLE THRESHOLD. RAISED THRESHOLDS AND FLOOR LEVEL CHANGES AT ACCESSIBLE DOORWAYS TO BE BEVELED WITH A SLOPE NO GREATER THAN 1:12.
- ALL DIMENSIONS ARE TO FINISHED FACE UNLESS SHOWN OR NOTED OTHERWISE.
- INSTALL MOISTURE RESISTANT GREEN BOARD ON BACKBAR WALL PER PROJECT MANUAL.
- ALL DOORS SHALL BE 32" (815MM) MINIMUM CLEAR OPENING WHEN OPENED TO 90 DEGREE POSITION UNLESS OTHERWISE NOTED.
- SEE SHEET A601 FOR EXTERIOR DOOR AND WINDOW SCHEDULES.
- STARBUCKS VENDOR TO PROVIDE DOOR HARDWARE COMPONENTS AND GC TO INSTALL.
- VERIFY ALL EXISTING DOORS, HARDWARE AND FRAMES MEET STARBUCKS AND/OR CODE REQUIREMENTS.
- PROVIDE FIRE EXTINGUISHERS AS NOTED ON THE APPROVED PLANS FROM THE CITY.
- SEE STRUCTURAL FOR KNEE WALL BRACING.
- SEE SHEET A501 FOR BUILDING DETAILS.
- REFER TO SHEET I104 FOR FLOOR FINISHES.

REFER TO A401 FOR WINDOW SCHEDULE, DETAIL AND ELEVATIONS.

GENERAL LEGEND

- NEW FULL HEIGHT WALL
- NEW LIGHT GAUGE WALL
- NEW PARTIAL HEIGHT WALL
- EXISTING WALL
- NEW CONCRETE FILL SLAB
- WALL BLOCKING CALL-OUT
- WALL SHEATHING CALL-OUT
- DOOR TAG
- INTERIOR WALL TAG

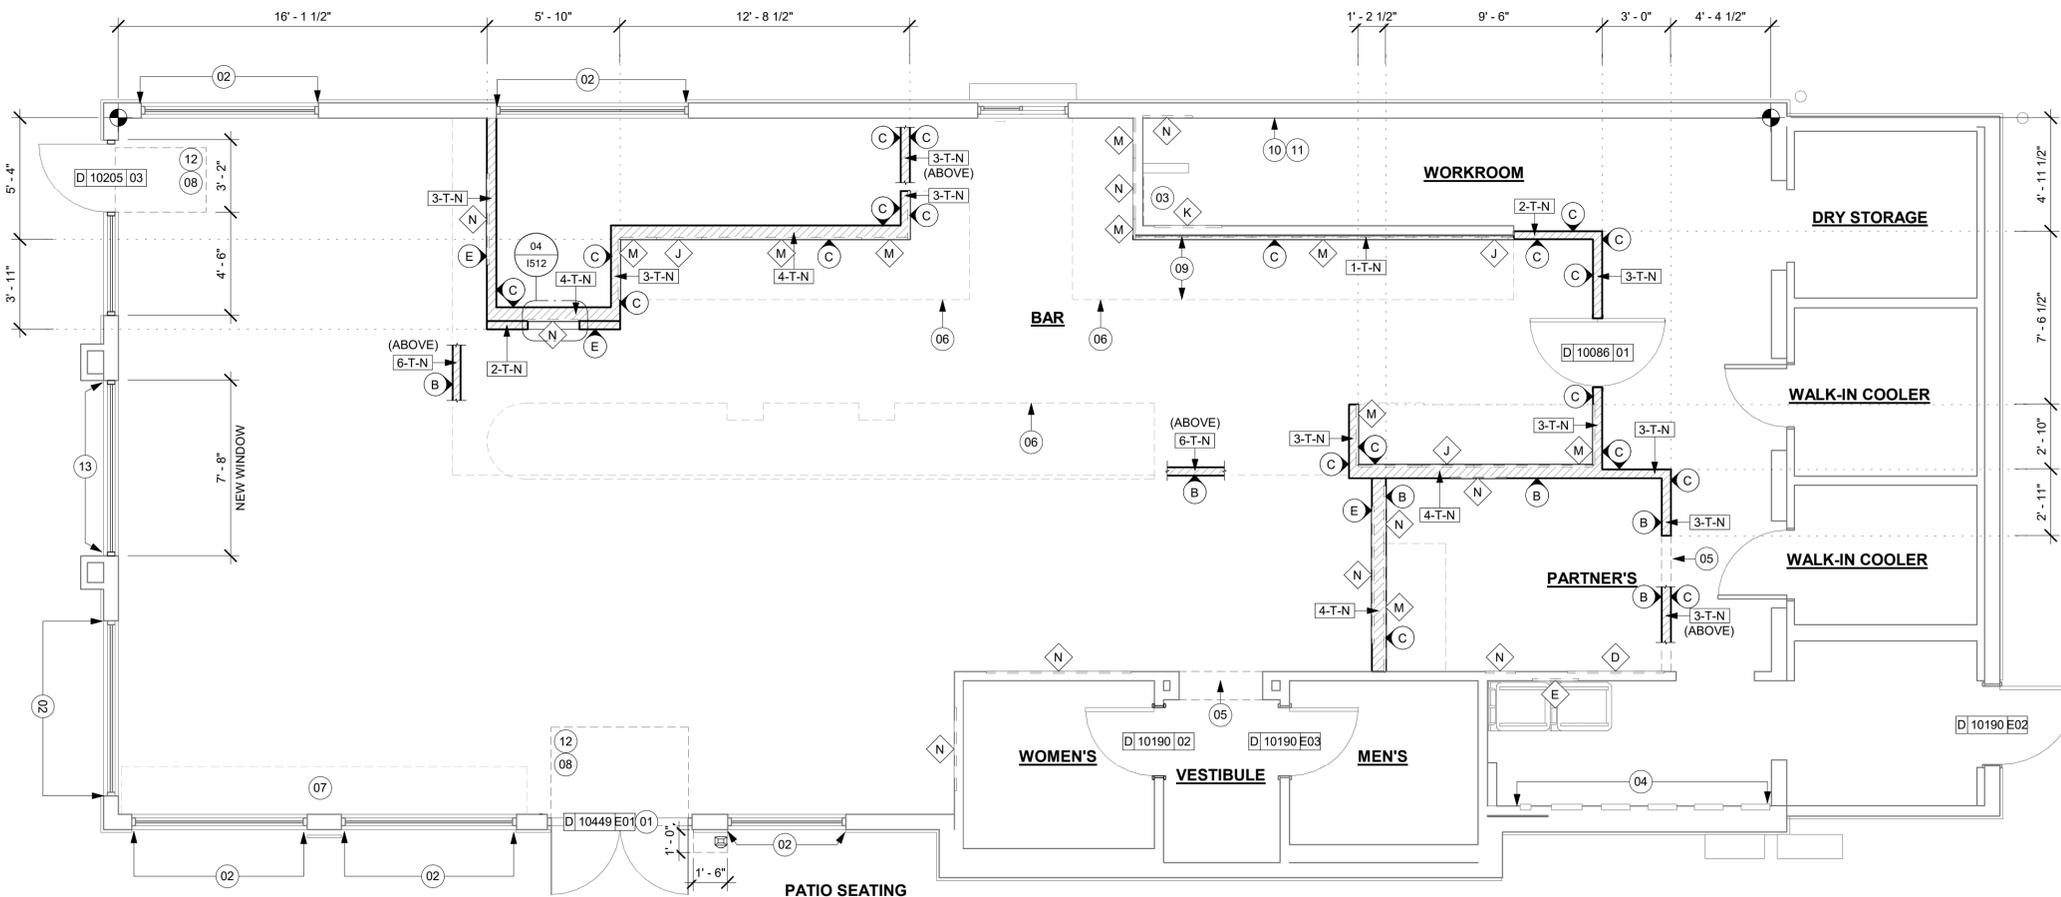

01 BUILDING FLOOR PLAN
Scale: 1/4" = 1'-0"



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PABLO GARCIA, AIA, REG. FL NO. AR99297

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PROJECT NAME:
A1A & 10TH

PROJECT ADDRESS:
**975 3RD STREET SOUTH
JACKSONVILLE BEACH, FL
32250**

STORE #: 8565
PROJECT #: 18756-108
ISSUE DATE: 03-27-2024
DESIGN MANAGER: ROMINA VIGNOLO
PRODUCTION DESIGNER: GENSLER
CHECKED BY: GENSLER

Revision Schedule			
Rev	Date	By	Description

SHEET TITLE:
BUILDING FLOOR PLAN

SCALE: AS SHOWN

SHEET NUMBER:
A101



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PROJECT NAME:
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STORE #: 8565
PROJECT #: 18756-108
ISSUE DATE: 03-27-2024
DESIGN MANAGER: ROMINA VIGNOLO
PRODUCTION DESIGNER: GENSLER
CHECKED BY: GENSLER

Revision Schedule			
Rev	Date	By	Description

SHEET TITLE:
**BUILDING FLOOR
PENETRATION PLAN**
SCALE: AS SHOWN

SHEET NUMBER:
A102


GENERAL NOTES

- A. ALL STUB-UP DIMENSIONS ARE RELATIVE TO FINISHED WALL LOCATIONS (SHOWN AS OUTLINES ON THIS PLAN). REFER TO FLOOR PLAN FOR WALL PLACEMENT.
- B. FLOOR SINK: REFER TO CUT SHEETS FOR COMPONENT SPECIFICATIONS AND CUTOUT REQUIREMENTS.
- C. WASTE LINE PENETRATIONS: REFER TO PLUMBING PLANS FOR INDIVIDUAL LINE LOCATIONS.
- D. STUB-UP PENETRATIONS: REFER TO ELECTRICAL AND PLUMBING PLANS FOR INDIVIDUAL STUB-UP LOCATIONS.
- E. TOILET FLOOR PENETRATION: REFER TO CUT SHEETS FOR STUB-UP LOCATION RELATIVE TO FINISHED WALL.
- F. PENETRATION TO BE LOCATED ON CENTERLINE OF WALL OR AS REQUIRED PER CONDITIONS.
- G. TRENCHING OUTLINE FOR GUIDELINE USE ONLY. GENERAL CONTRACTOR TO COORDINATE WITH SPECIFIC TRADES AND SITE CONDITIONS TO DETERMINE ACTUAL LAYOUT.
- H. REFER TO SHEET I101 FOR FLOOR FINISHES.

KEYED NOTES


- 01 OUTLINE OF ENGINE FOR REFERENCE.
- 02 PROPOSED LOCATION OF CASEWORK DEWALL. GC TO COORDINATE WITH CASEWORK VENDOR FOR LOCATION ON SITE.
- 03 DEPRESSED SLAB FOR RECESSED WALK-OFF MAT.
- 04 BANQUETTES WITH POWER. FLOOR ELECTRICAL OUTLET. SEE ELECTRICAL SHEETS. REFER TO DETAIL.
- 05 LOCATION OF POWER AND DATA OUTLETS BEHIND MENU BOARDS. CENTER OUTLETS BEHIND MENU BOARDS. REFER TO DETAIL 2/I-509 FOR MORE INFORMATION.
- 06 EXISTING DRAIN TO BE REUSED AND UPDATE AS REQUIRED.
- 07 HAND SINK LOCATION.
- 08 COMMUNITY TABLE WITH POWER. REFER TO DETAIL AT A501.

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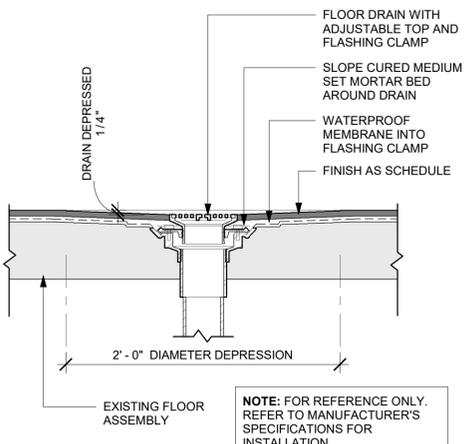
02 ECO-GRIP TO FLOOR SINK TRANSITION

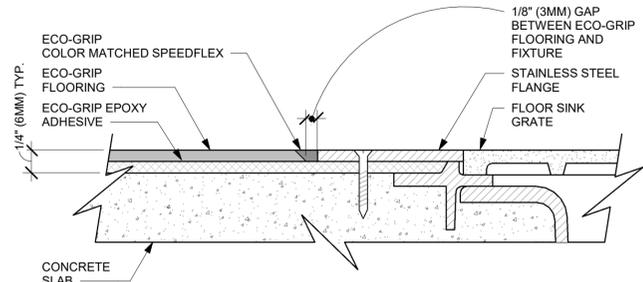Scale: 12" = 1'-0"




03 FLOOR SINK SECTION

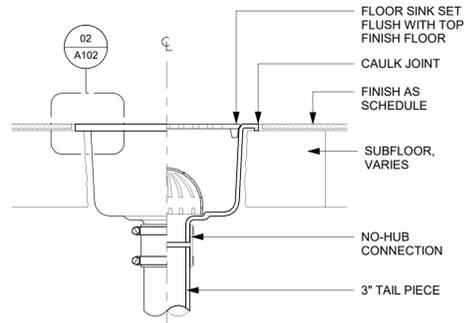Scale: 3" = 1'-0"



04 FLOOR DRAIN SECTION

Scale: 1 1/2" = 1'-0"

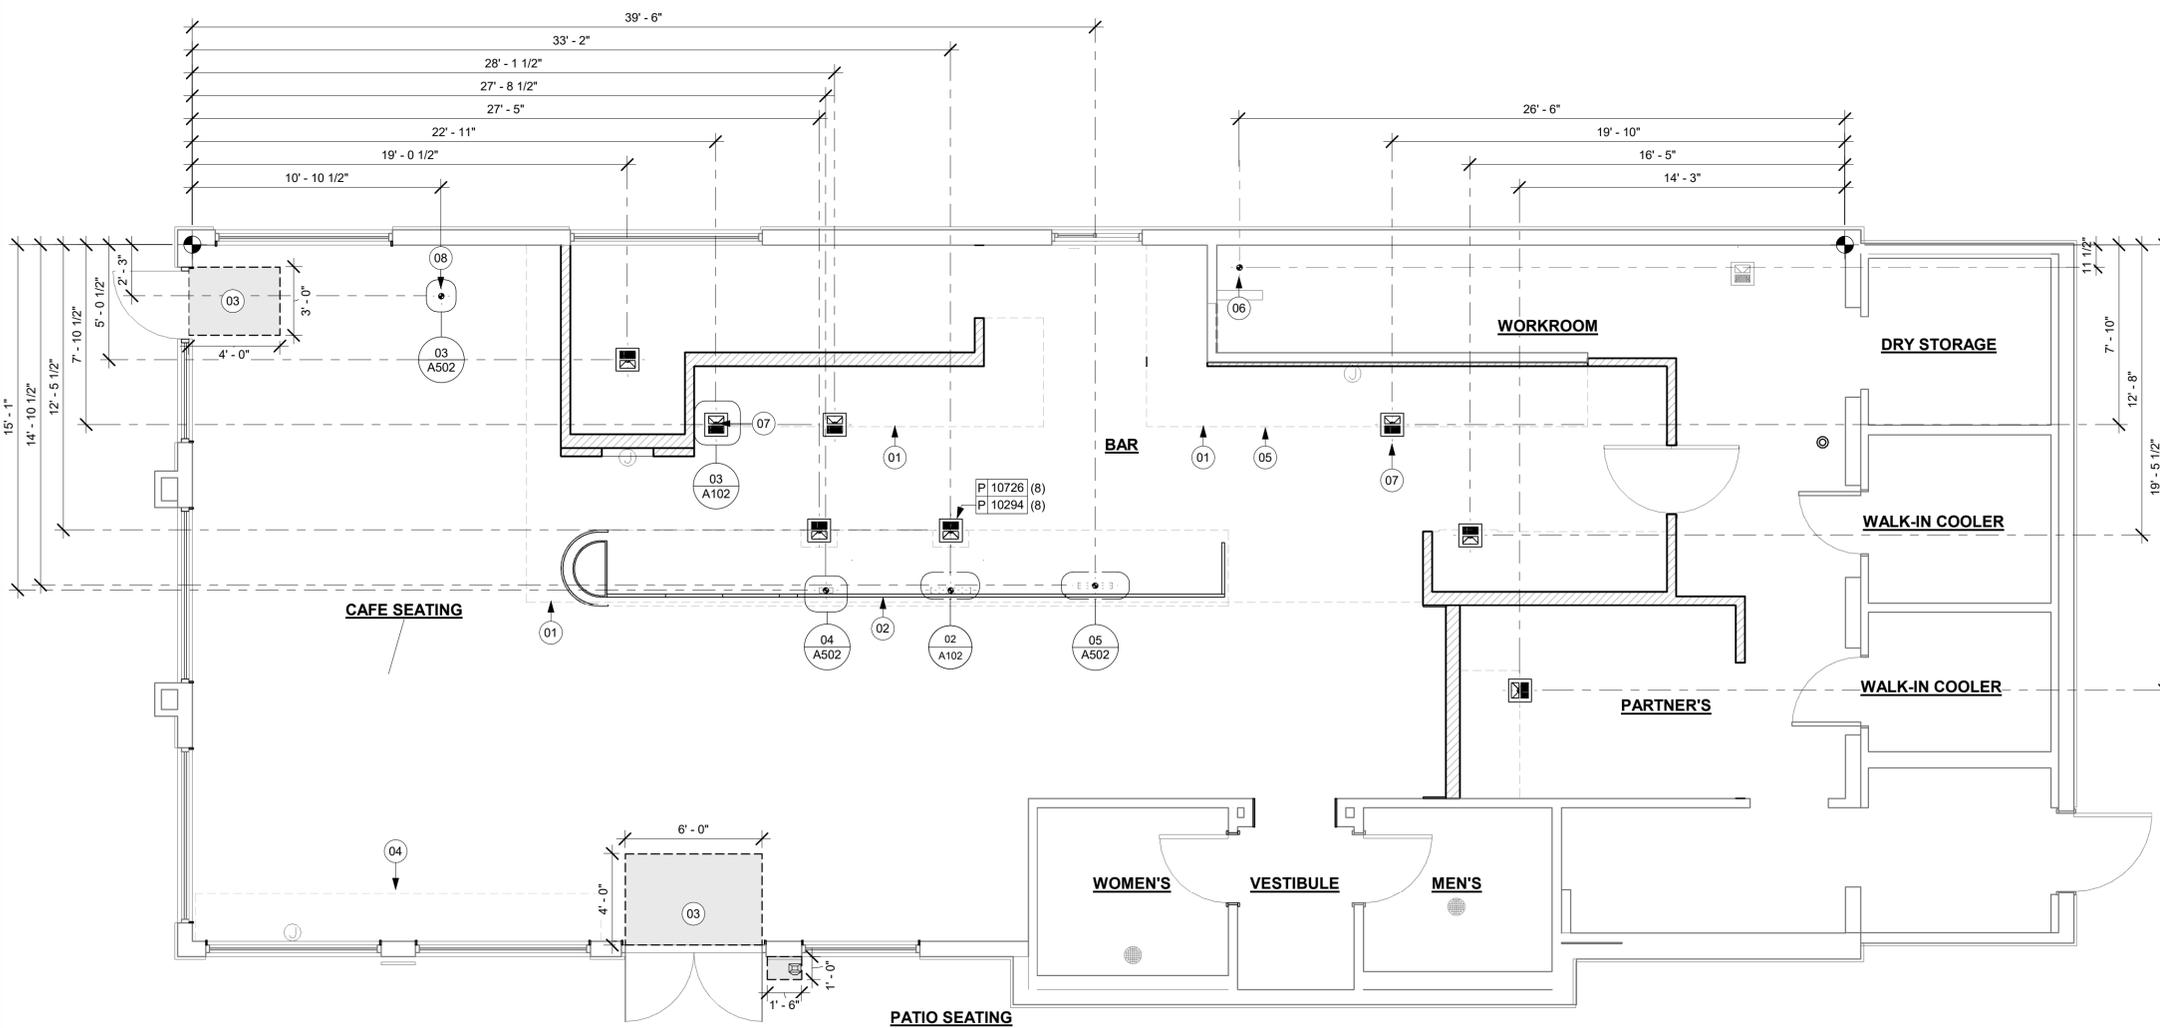

01 FLOOR PENETRATION PLAN

Scale: 1/4" = 1'-0"

LEGEND

- EXISTING WALL
- EXISTING CONCRETE LEAVE-OUT, GC TO ADD CONCRETE SLAB ON GRADE AFTER INSTALLATIONS, AS PER STRUCTURAL DRAWINGS.
- DATUM POINT
- FLOOR CLEAN-OUT
- FLOOR SINK
- WASTE LINE PENETRATION
- PLUMBING STUB-UP PENETRATION
- ELECTRICAL STUB-UP PENETRATION



WINDOW	COUNT	MATERIAL			LINTEL HEIGHT	SILL HEIGHT	FURN. BY	INST. BY	COMMENTS	APPROVAL NUMBER
		FRAME	FINISH	GLAZING						
W 01	1	ALUM	SILVER	IMPACT	7' - 2"	5' - 10"	GC	GC	YKK YHS 50F1.	FL-14218.2
W 01	1	ALUM	SILVER	IMPACT	7' - 2"	5' - 6"	GC	GC	YKK YHS 50F1.	FL-14218.2

GENERAL NOTES:


- SEALANT TO MATCH SILVER SPANDREL ALUMINUM STOREFRONT SYSTEM.
- FIELD VERIFY ALL DIMENSIONS PRIOR TO STOREFRONT MANUFACTURING.

ABBREVIATIONS:

- ALUM: ALUMINUM
- AND: ANODIZED
- TEMP: TEMPERED GLASS
- INSUL: INSULATED GLASS


GLAZING NOTES:

- IMPACT RATED GLAZING, INSULATED GLASS; CLEAR LOW E.

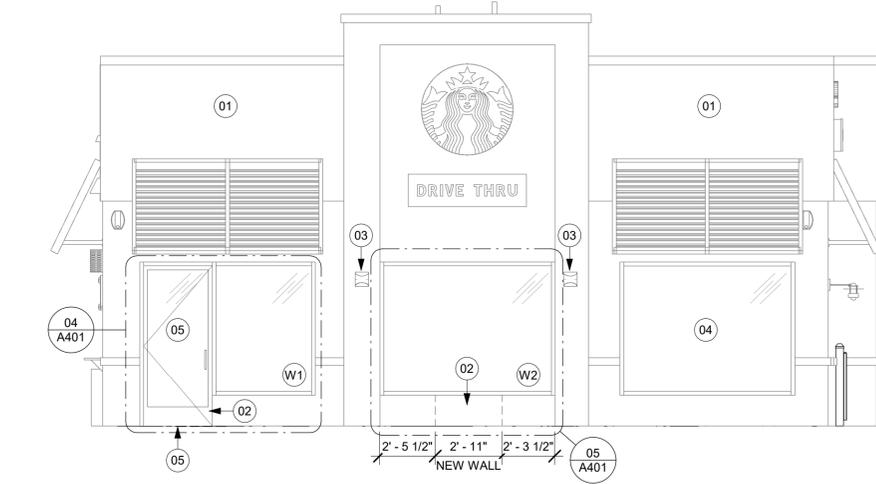

01 EXTERIOR ELEVATION

Scale: 1/4" = 1'-0"

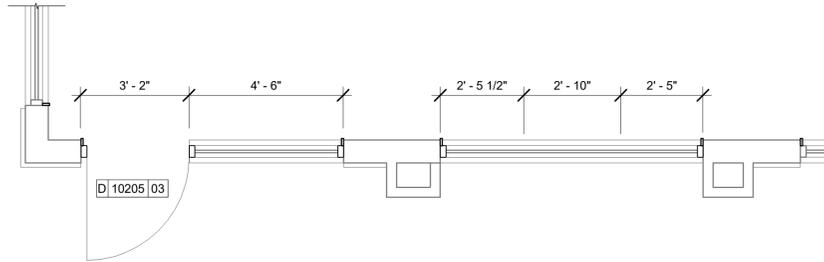


02 ENLARGED STOREFRONT

Scale: 3/8" = 1'-0"




03 DEMO EXTERIOR ELEVATION

Scale: 1/4" = 1'-0"

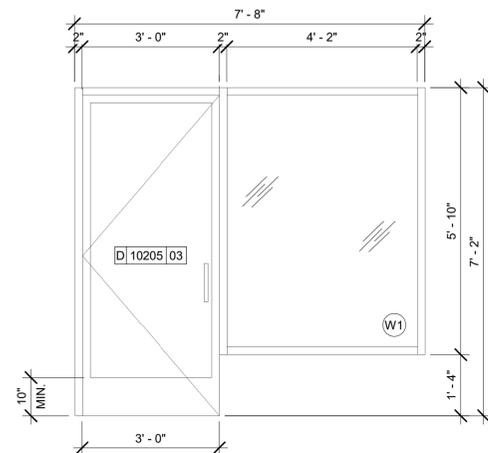

04 STOREFRONT ELEVATION AT SECONDARY ENTRANCE

Scale: 1/2" = 1'-0"

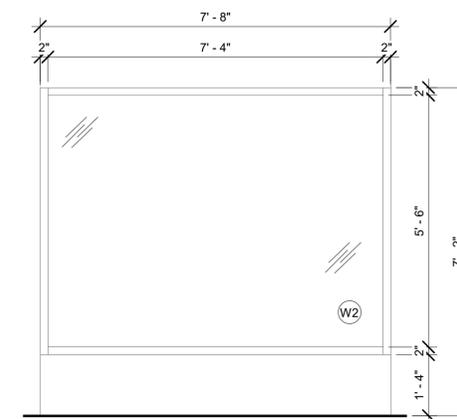

05 STOREFRONT ELEVATION AT W2

Scale: 1/2" = 1'-0"

KEYED NOTES

- EXISTING FINISHES TO REMAIN.
- PATCH, REPAIR AND MATCH EXISTING MATERIALS.
- EXISTING EXTERIOR SCONCES.
- EXISTING STOREFRONT.
- NEW STORE FRONT DOOR.

GENERAL NOTES

- GENERAL CONTRACTOR TO COORDINATE AND SCHEDULE SIGNAGE INSTALLATION WITH THE SIGNAGE CONTRACTOR PROVIDING A MINIMUM SCHEDULING NOTICE OF 4 WEEKS AND 1 WEEK PRIOR TO SCHEDULED DATE OF INSTALLATION. CONSTRUCTION MANAGER TO PROVIDE GENERAL CONTRACTOR WITH SIGNAGE CONTRACTOR CONTACT INFORMATION.
- GENERAL CONTRACTOR SHALL COORDINATE WITH ELECTRICAL CONTRACTOR TO FURNISH AND INSTALL ELECTRICAL CIRCUITS INCLUDING ALL CONDUIT, WIRE, CONNECTIONS AND BREAKER AT PANEL BOARD NECESSARY TO SERVE SIGNAGE.
- GENERAL CONTRACTOR TO PROVIDE FIRE TREATED 2X WOOD BLOCKING OR EQUIVALENT FOR COMPLETE AND SECURE SUPPORT OF ANY WALL-MOUNTED EQUIPMENT, CABINETS, FURNISHINGS, ARTWORK AND/OR SIGNAGE.
- SIGNAGE CONTRACTOR SHALL VERIFY SIZE AND LOCATION OF ANY AND ALL ALLOWABLE MONUMENT OR POLE SIGNAGE AND PROVIDE SHOP DRAWING(S) PRIOR TO FABRICATION TO THE STARBUCKS DESIGNER FOR APPROVAL.
- SIGNAGE CONTRACTOR TO INSTALL SIGNAGE IN COMPLIANCE WITH LOCAL CODES AND OBTAIN PERMIT.
- SIGNAGE CONTRACTOR TO SUPPLY SHOP DRAWINGS TO CONSTRUCTION MANAGER AND TO THE GENERAL CONTRACTOR AS NEEDED. GENERAL CONTRACTOR TO NOTIFY CONSTRUCTION MANAGER IMMEDIATELY IF SHOP DRAWINGS OR INSTALLATION IS IN DISCREPANCY WITH ARCHITECTURAL DRAWINGS.
- GENERAL CONTRACTOR TO CLEAN, PATCH AND REPAIR EXISTING EXTERIOR AS REQUIRED.



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PROJECT ADDRESS:
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JACKSONVILLE BEACH, FL
32250**

STORE #: 8565
PROJECT #: 18756-108
ISSUE DATE: 03-27-2024
DESIGN MANAGER: ROMINA VIGNOLO
PRODUCTION DESIGNER: GENSLER
CHECKED BY: GENSLER

Revision Schedule			
Rev	Date	By	Description

SHEET TITLE:
EXTERIOR ELEVATIONS

SCALE: AS SHOWN

SHEET NUMBER:
A401

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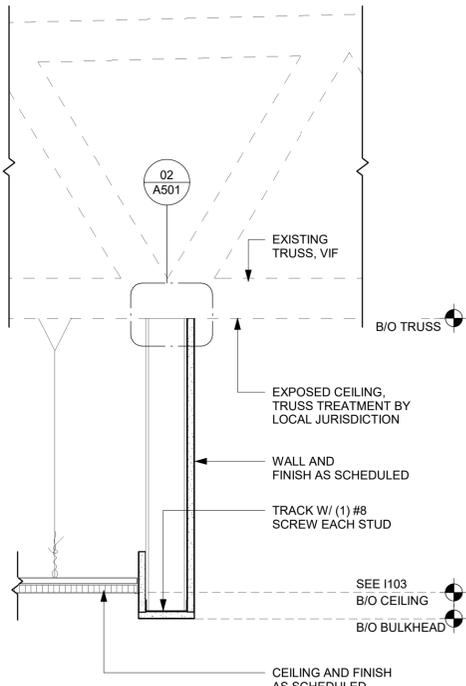
Revision Schedule			
Rev	Date	By	Description

SHEET TITLE:
WALL FRAMING DETAILS


SCALE: AS SHOWN

SHEET NUMBER:
A501


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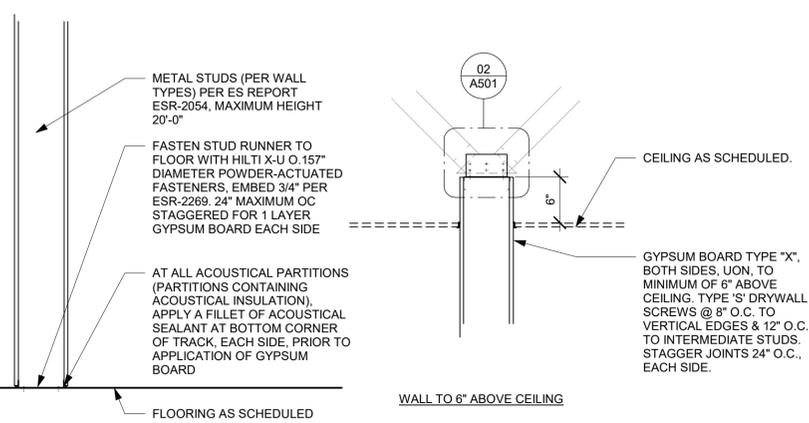
03 HEADER AT WATER HEATER
Scale: 1 1/2" = 1'-0"




04 BLOCKING DETAIL
Scale: 1/2" = 1'-0"

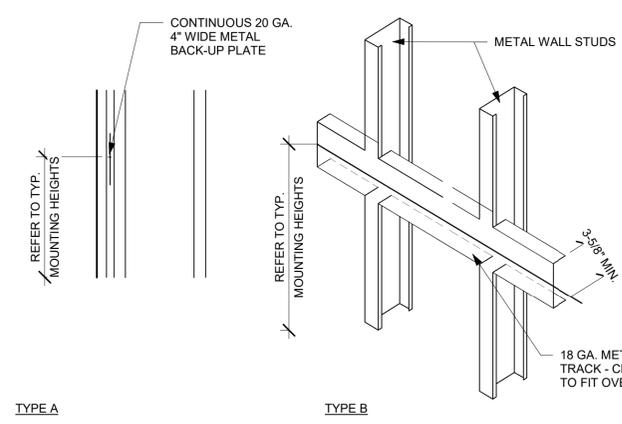


05 PIPE PENETRATION DETAIL
Scale: 3/4" = 1'-0"

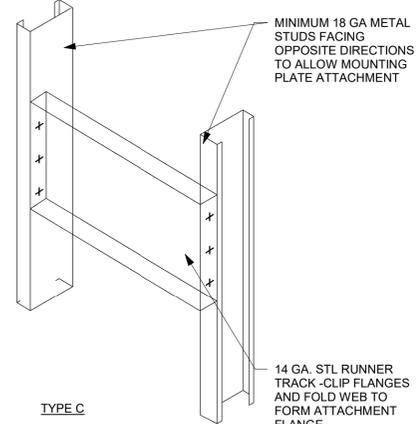


01 NEW PARTITION WALL SECTION
Scale: 1" = 1'-0"

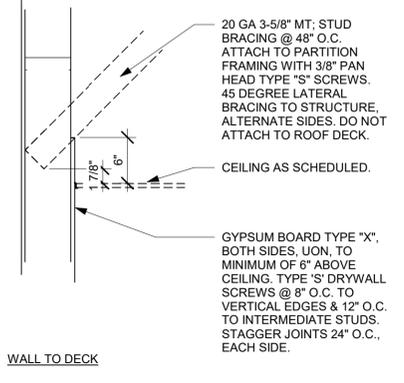


02 TOP OF PARTITION WHERE BRACED TO STRUCTURE ABOVE - SEISMIC
Scale: 3" = 1'-0"

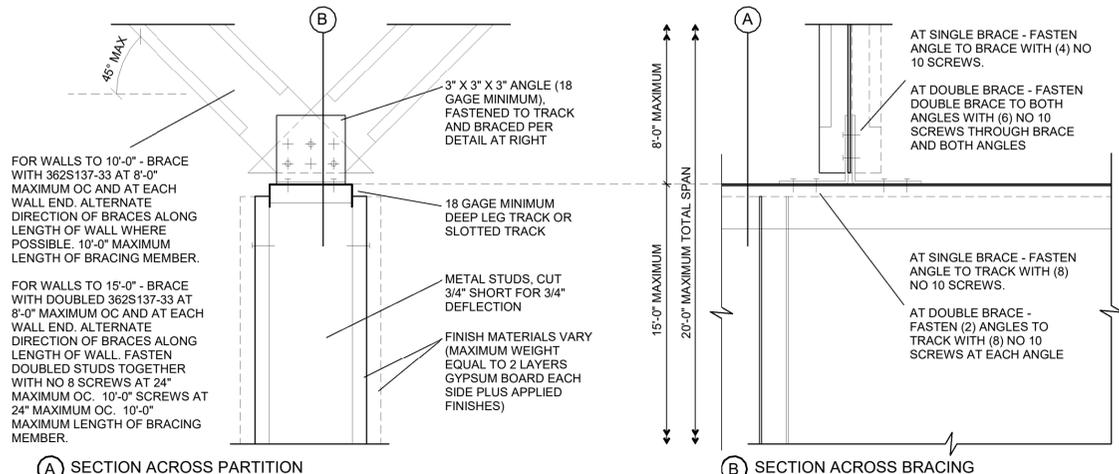


A SECTION ACROSS PARTITION
B SECTION ACROSS BRACING

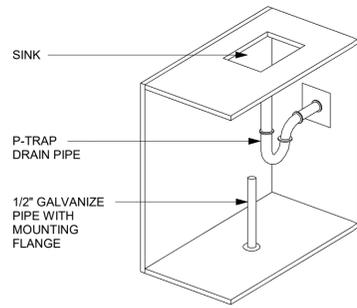


01 P-TRAP GUARD
Scale: NTS

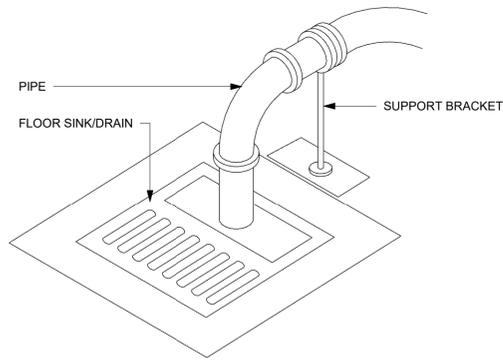

02 PIPE SUPPORT
Scale: NTS

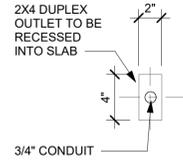


03 STUB UP AT COMMUNITY TABLE
Scale: 1 1/2" = 1'-0"

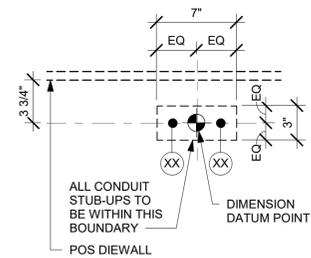


ESPRESSO BAR PLUMBING STUB-UP KEY
1 | CWF STUB-UP
2 | CW STUB-UP
NOTE: SEE SHEET A102 - BUILDING FLOOR PENETRATION PLAN FOR FINAL DIMENSIONED LOCATION.

04 PLUMBING STUB-UPS AT ESPRESSO BAR
Scale: 1 1/2" = 1'-0"

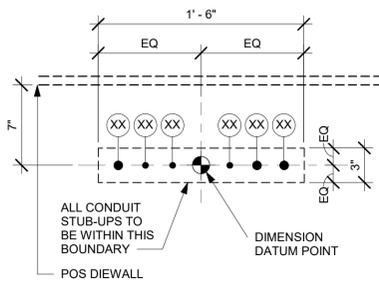


POS ELECTRICAL STUB-UP KEY
1 | 3/4" POWER CONDUIT TO ELECTRICAL PANEL
2 | 1/2" PHONE TO MANAGER'S DESK
3 | 1/2" DATA CONDUIT TO MANAGER'S DESK
4 | 1/2" SECURITY TO MANAGER'S DESK
5 | 3/4" LAN CONDUIT TO POS/SAFE
6 | 3/4" POWER CONDUIT FOR PASTRY CASE
NOTE: SEE SHEET A102 - BUILDING FLOOR PENETRATION PLAN FOR FINAL DIMENSIONED LOCATION.

05 ELECTRICAL STUB-UPS AT POS
Scale: 1 1/2" = 1'-0"

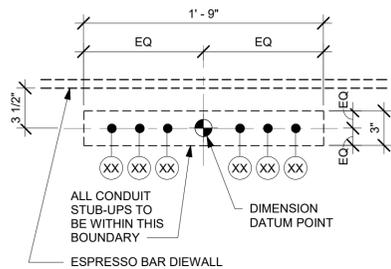


ESPRESSO BAR ELECTRICAL STUB-UP KEY
1 | 3/4" LAN CONDUIT
2 | 3/4" LAN CONDUIT TO MANAGER'S WORKSTATION
3 | 3/4" ISOLATED GROUND POWER CONDUIT
NOTE: SEE SHEET A102 - BUILDING FLOOR PENETRATION PLAN FOR FINAL DIMENSIONED LOCATION.


06 ELECTRICAL STUB-UPS AT ESPRESSO BAR
Scale: 1 1/2" = 1'-0"

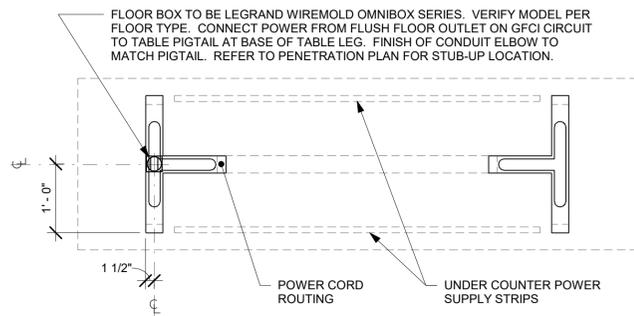


07 TABLE - ANGLED BASE COMMUNITY
Scale: 3/4" = 1'-0"

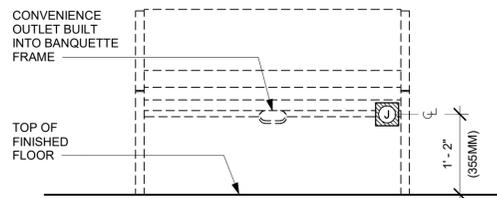

ELEVATION VIEW

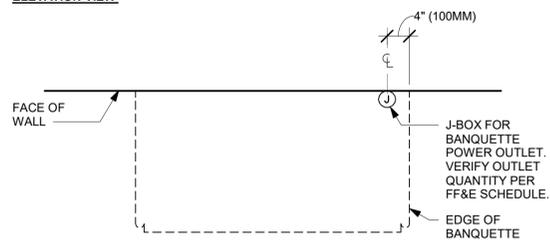

PLAN VIEW - ELECTRICAL COMPONENTS

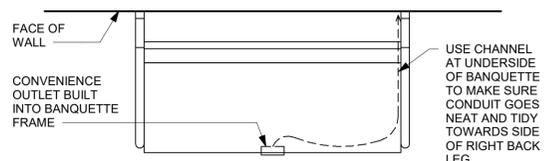

PLAN VIEW

08 BANQUETTE - SAN JUAN - ELECTRICAL
Scale: 3/4" = 1'-0"

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PABLO GARCIA, AIA, REG. FL NO. AR99297

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PROJECT NAME:
A1A & 10TH

PROJECT ADDRESS:
**975 3RD STREET SOUTH
JACKSONVILLE BEACH, FL
32250**

STORE #: 8565
PROJECT #: 18756-108
ISSUE DATE: 03-27-2024
DESIGN MANAGER: ROMINA VIGNOLO
PRODUCTION DESIGNER: GENSLER
CHECKED BY: GENSLER

Revision Schedule			
Rev	Date	By	Description


SHEET TITLE:
BUILDING DETAILS

SCALE: AS SHOWN

SHEET NUMBER:
A502


DOOR SCHEDULE - "D"									
DESIGN ID	MARK	DESCRIPTION	WIDTH	HEIGHT	HARDWARE SET	FURN BY	INST BY	COMMENTS	
Exterior									
10449	E01	Door - Double Storefront Metal Frame	6' - 0"	6' - 10"	EXIST			EXISTING DOOR TO REMAIN.	
10190	E02	Door - Single Flush - 36in 915mm	3' - 5"	6' - 7"	EXIST			EXISTING DOOR TO REMAIN.	
10205	03	DOOR - STOREFRONT METAL FRAME SINGLE - TYPE B	3' - 0"	7' - 0"	3-A-BRFR	LL	GC	MATCH EXISTING MANUFACTURER AND EXTERIOR DESIGN PRESSURES. PROVIDE 32" MIN CLEAR OPENING. BUTTOM RAIL MIN. 10 IN. ACCORDING TO ADA.	
Interior									
10190	02	DOOR - SINGLE FLUSH - 36IN 915MM	3' - 0"	7' - 0"	7	SB	GC	DOOR FINISH BLACK STAIN TO MATCH WD0035. FRAME FINISH: PAINT BLACK MAGIC SW6991	
10190	E03	DOOR - SINGLE FLUSH - 36IN 915MM	3' - 0"	7' - 0"	EXIST	SB	GC	DOOR FINISH BLACK STAIN TO MATCH WD0035. FRAME FINISH: PAINT BLACK MAGIC SW6991	
10086	01	DOOR - SINGLE IMPACT DOUBLE ACTING - 36IN 915MM	3' - 0"	7' - 0"	11	SB	GC	HM, U, NR HM4. DOOR TYPE B. FINISHES: DOOR PANEL: X0302 WILSONART LAMINATE PAPERDUST D327 60 MATTE FINISH. FRAME: MATCH SW7029 AGREABLE GREY.	

DOOR LEGEND

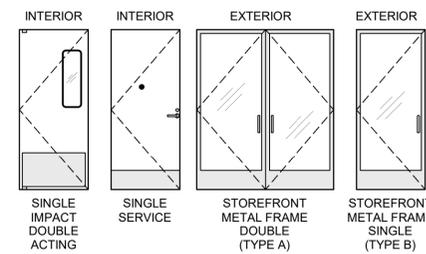

GENERAL NOTES

- STARBUCKS VENDOR TO PROVIDE DOOR HARDWARE COMPONENTS. GC TO INSTALL.
- SEE SHEET A101 FOR TAGGED LOCATION OF EXTERIOR DOORS AND WINDOWS.
- EGRESS SHALL NOT PASS THROUGH KITCHENS, STORAGE ROOMS, CLOSETS OR SIMILAR SPACES. (FBCB 1014.2)
- PANIC AND FIRE EXIT HARDWARE, WHERE INSTALLED ON DOORS IN THIS BUILDING SHALL SATISFY THE FOLLOWING (FBCB 1008.1.10):
 - THE ACTUATION PORTION OF THE RELEASING DEVICE SHALL EXTEND AT LEAST ONE-HALF OF THE DOOR LEAF WIDTH.
 - THE MAXIMUM UNLATCHING FORCE DOES NOT EXCEED 15 POUNDS (6.8 KG).
 - PIVOTED OR BALANCED DOORS SHALL BE OF THE PUSH-PAD TYPE WHERE PANIC HARDWARE IS REQUIRED AND THE PAD SHALL NOT EXTEND ACROSS MORE THAN ONE-HALF OF THE DOOR WIDTH, MEASURED FROM THE LATCH SIDE.
 - PANIC HARDWARE LISTED IN ACCORDANCE WITH UL 305.
 - FIRE EXIT HARDWARE LISTED IN ACCORDANCE WITH UL 10C AND UL 305.
- SPY SCOPE HARDWARE, WHERE INSTALLED SHALL BE CENTERED IN DOOR AT 54" (1370MM) A.F.F.
- FOR BARRIER FREE DOOR HARDWARE INSTALLATION AND TECHNICAL SUPPORT, CONTACT THE STARBUCKS SUPPLIER, LOCKNET, AT SBUXTEAM@LOCKNET.COM.
- PROVIDE SAFETY GLASS IN LOCATIONS AS REQUIRED BY IBC SECTION 2406.
- ALL DOORS TO HAVE BOTTOM CLEARANCE OF 1/4" BETWEEN THRESHOLD AND DOOR BOTTOM. UNO.

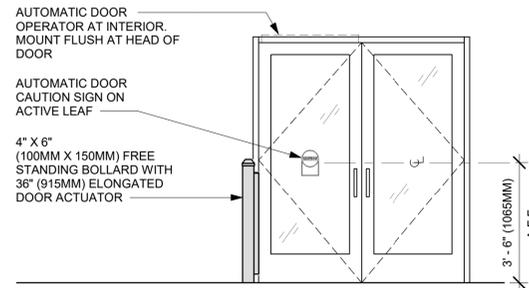


EXTERIOR ELEVATION


BARRIER FREE DOOR HARDWARE SCHEDULE - "D"						
DESIGN ID	COUNT	MARK	DESCRIPTION	FURN BY	INST BY	COMMENTS
23130	1	05	DOOR - BARRIER FREE HARDWARE ACTUATOR BOLLARD	SB	GC	
23129	1	08	DOOR - BARRIER FREE HARDWARE KEY SWITCH	SB	GC	
23134	1	07	DOOR - BARRIER FREE HARDWARE OPERATOR - SILVER	SB	GC	

DOOR HARDWARE SET NO. 7 - For restroom door with lever and keyed lock				
No.	Item	Description	Manufacturer	Finish
3	Hanging Devices	TA2714/MPB79 Hinge MacPro Bearing 5 x 4.5	McKinney	626
1	Securing Devices	B-PB5405LNIC Lever Storeroom LC B-PB5405LN-693-497 1-3/4	Yale Lock	626
1	Securing Devices	C607 7-Pin Core Combined "A" Keyway	Falcon Lock	626
1	Closing Devices	8916 Door Closer 8916 AF89P	Dorma	689
2	Protective Trim Units	K1050 B4E Kickplate 8" x 34" each site 32D	Rockwood	630
3	Accessories	GJ64 Rubber Silencer	Glynn Johnson	Gray
1	Stops and Holders	473 Door Stop w/ Hook 26D	Rockwood	626


DOOR HARDWARE SET NO. 11 - For workroom door at backbar				
No.	Item	Description	Manufacturer	Finish
1	Traffic Door Package	SCP8 36" x 84"	Eliason	As Selected

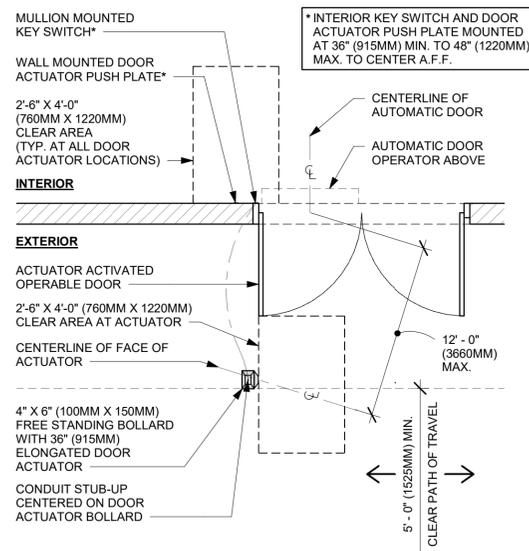


PLAN VIEW

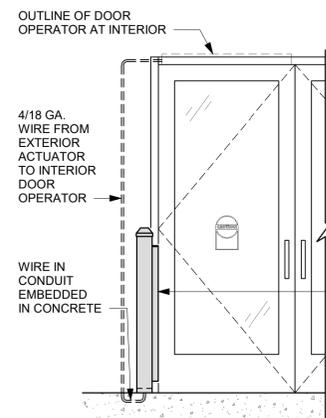

EXTERIOR ELEVATION

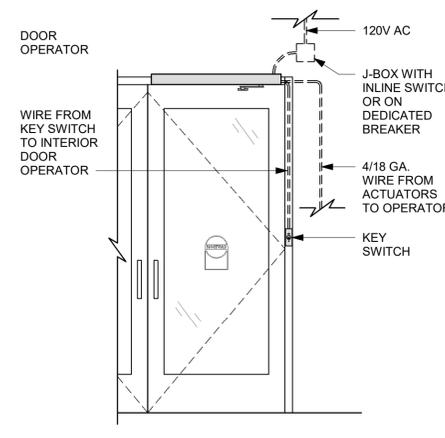

INTERIOR ELEVATION

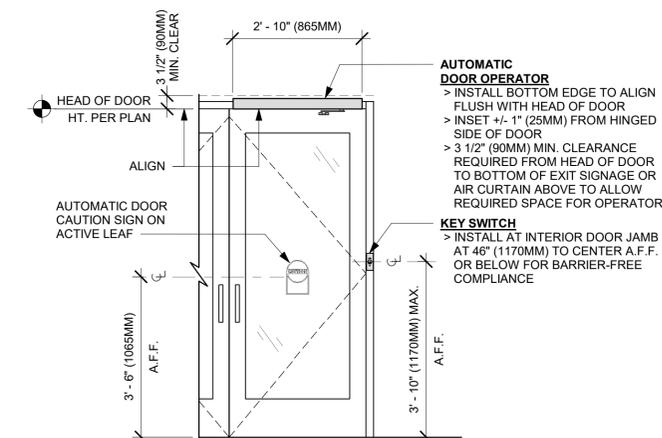


INTERIOR ELEVATION


05 ENTRY/EXIT DOOR ACTUATION - BOLLARD
Scale: 3/8" = 1'-0"

06 ENTRY/EXIT DOOR ACTUATION - ELECTRICAL WIRING DIAGRAM
Scale: 1/2" = 1'-0"


07 ENTRY/EXIT DOOR ACTUATION - KEY SWITCH AND OPERATOR
Scale: 1/2" = 1'-0"

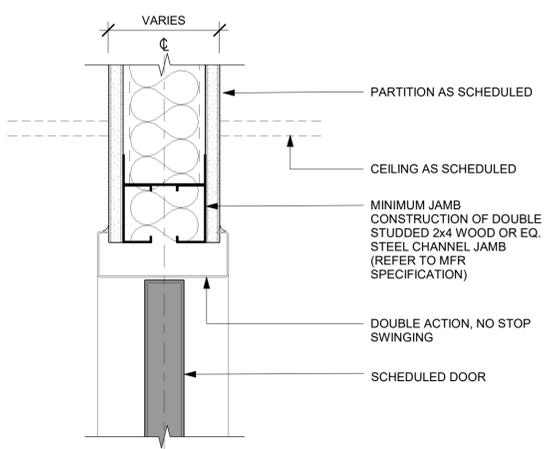


01 DOUBLE ACTION DOOR - FRAME HEAD
Scale: 3" = 1'-0"

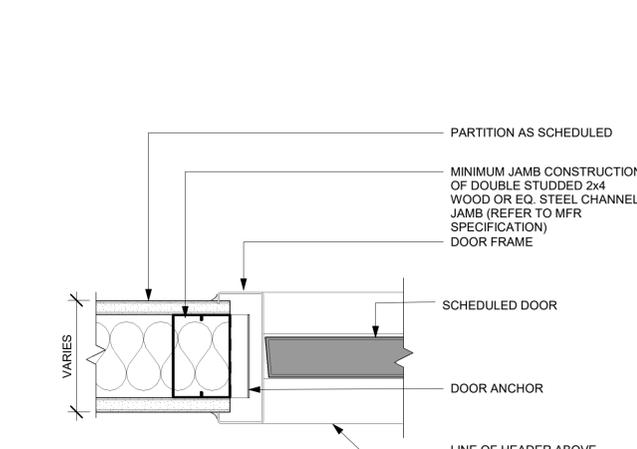

02 DOUBLE ACTION DOOR - FRAME JAMB
Scale: 3" = 1'-0"

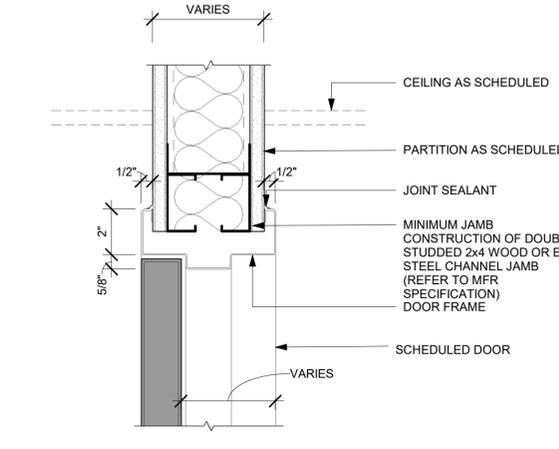

03 SINGLE FLUSH DOOR - FRAME HEAD
Scale: 3" = 1'-0"

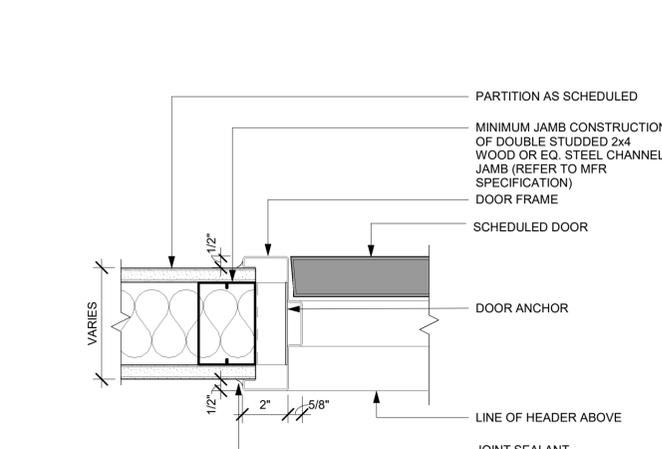

04 SINGLE FLUSH DOOR - FRAME JAMB
Scale: 3" = 1'-0"

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STARBUCKS TEMPLATE VERSION: i2024.01.01

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PROJECT NAME:
A1A & 10TH

PROJECT ADDRESS:
**975 3RD STREET SOUTH
JACKSONVILLE BEACH, FL
32250**

STORE #: 8565
PROJECT #: 18756-108
ISSUE DATE: 03-27-2024
DESIGN MANAGER: ROMINA VIGNOLO
PRODUCTION DESIGNER: GENSLER
CHECKED BY: GENSLER

Revision Schedule			
Rev	Date	By	Description

SHEET TITLE:
**WINDOW AND DOOR
SCHEDULES & DETAILS**
SCALE: AS SHOWN

SHEET NUMBER:
A601

FURNITURE SCHEDULE - "F"					
DESIGN ID	COUNT	DESCRIPTION	FURN. BY	INST. BY	COMMENTS
BANQUETTE					
22502	3	BANQUETTE - SAN JUAN - 6FT 183CM - WHITE OAK WD0073	SB	GC	
23017	3	BANQUETTE - SAN JUAN CUSHION SEAT AND BACK C EDGE - 6FT 183CM - CARAMEL BROWN NATURAL F0008	SB	GC	
CHAIR					
21367	13	CHAIR - CAFE PEGGY UPHOLSTERED - WHITE OAK AND CARAMEL BROWN NATURAL WD0073 F0008	SB	GC	
21456	8	CHAIR - CAFE ASHER UPHOLSTERED BACK - WHITE OAK AND CARAMEL BROWN NATURAL WD0073 F0008	SB	GC	
22569	4	CHAIR - LOUNGE LAIDBACK - WHITE OAK AND CARAMEL BROWN NATURAL WD0073 F0008	SB	GC	
23447	20	CHAIR - CAFE HANS 2.0 - MOTTLED GREY	SB	GC	
23449	10	CHAIR - LOUNGE HANS 2.0 - MOTTLED GREY	SB	GC	
TK0077	1	CHAIR - MANAGERS WORKSTATION	SB	GC	STEELCASE SERIES ONE ARMLESS
DESK					
TK0053	1	DESK - MANAGERS WORKSTATION SHELVES - 48IN 1220MM	SB	GC	
TK0076	1	DESK - MANAGERS WORKSTATION - 48X24X27IN 1220X610X685MM	SB	GC	
MIRROR					
TK0050	1	MIRROR - BOH - 16X51IN 405X1295MM	SB	GC	
OTHER					
10756	2	COAT HOOK 1 PRONG SQUARE - 2IN 50MM - SST			
TK0051	1	COAT HOOK STRIP - 30IN 760MM	SB	GC	BLACK FINISH
STORAGE					
TK0078	1	FILE MOBILE PEDESTAL WITH CUSHION AND LOCK	SB	GC	
TK0079	1	MANAGERS DESK CART - 24X20IN 610X510MM	SB	GC	
TABLE					
17340	8	TABLE - CAFE METAL PEDESTAL BASE SQUARE - 24IN 610MM - BLACK MT0028	SB	GC	
17341	2	TABLE - ACCESSIBLE METAL WITH TAPERED LEGS - 36X24IN 915X610MM - BLACK MT0028	SB	GC	
18400	1	TABLE - COMMUNITY CAFE HEIGHT ANGLE BASE - 8 SEAT WIDE - WITH POWER WHITE OAK WD0073	SB	GC	
20127	5	TABLE - OCCASIONAL SIDE CAMERON - FLAT BLACK MT0028	SB	GC	
21449	8	TABLE - BASE CAFE HEIGHT BOTTLE - FLAT BLACK MT0028	SB	GC	
21453	1	TABLE - BASE ACCESSIBLE BOTTLE - FLAT BLACK MT0028	SB	GC	
21713	1	TABLE - TOP ACCESSIBLE ROUND EDGE OBLONG - 48X24IN 1220X610MM - WHITE WITH VEINING CP0002	SB	GC	
21842	4	TABLE - TOP ROUND EDGE ROUND - 24IN 610MM - WHITE OAK WD0073	SB	GC	
21845	3	TABLE - TOP ROUND EDGE ROUND - 30IN 760MM - WHITE OAK WD0073	SB	GC	

FURNITURE SCHEDULE - "F"					
DESIGN ID	COUNT	DESCRIPTION	FURN. BY	INST. BY	COMMENTS
21848	1	TABLE - TOP ROUND EDGE SQUARE - 24IN 610MM - WHITE OAK WD0073	SB	GC	
21979	2	TABLE - OCCASIONAL SIDE WING - WHITE OAK WD0073	SB	GC	
22553	2	TABLE - OCCASIONAL COFFEE WING - WHITE OAK WD0073	SB	GC	
WINDOW TREATMENT					
22486	12	ROLLER SHADE - DARK BROWN - 5PC OPEN			PROVIDED BY: BLIND EXPRESS (LEAD TIMES: 2 WEEKS) CONTACT ALBERT YU ATAYU@BLINDEXPRESS.COM PH: (770) 664-1688. OR ROLL A SHADE (LEAD TIMES: 4 WEEKS), ORDERING CONTACT KRISTEN FANNIN AT KRISTEN.FANNIN@ROLLASHADE.COM, PH: (951) 245-5077 X 114.

KEYED NOTES


- INSTALL EXTERIOR FURNITURE THROUGHOUT AS SHOWN. REFER TO FURNITURE SCHEDULE FOR ADDITIONAL INFORMATION.
- INSTALL INTERIOR CAFE FURNITURE THROUGHOUT AS SHOWN. REFER TO FURNITURE SCHEDULE FOR ADDITIONAL INFORMATION.
- COMMUNITY BOARD. SEE INTERIOR FINISH ELEVATIONS.
- CONDIMENT CART. SEE INTERIOR FINISH ELEVATIONS.
- DO NOT CAULK TRASH RINGS TO COUNTERTOP.
- MERCHANDISE DISPLAY. SEE DETAILS I509 FOR MORE INFORMATION.
- DO NOT BLOCK FOOD CASE INTAKE/EXHAUST.
- SAFE LOCATED AT POS CABINET. SEE ELECTRICAL FOR ADDITIONAL INFORMATION.
- HAND SINK W/ INTEGRAL SPLASH GUARD.
- INSTALL CORNER GUARD AS INDICATED. SEE INTERIOR FINISH ELEVATIONS.
- LOCATION OF SWITCH GEAR AND THERMOSTAT CONTROLS.
- SECURE LOCKERS TO WALL.
- G.C. TO REVERSE HINGE ON U.C. REFRIGERATOR TO LEFT HAND SWING AS SHOWN.
- MANAGERS DESK. SEE MANAGER'S DESK / EQUIPMENT RACK ELECTRICAL DETAIL FOR ADDITIONAL INFORMATION.
- REFER TO ENLARGED RESTROOM PLANS AND ELEVATIONS (SHEET I-401) FOR FIXTURE LOCATIONS AND MOUNTING HEIGHTS.
- ELECTRICAL PANEL LOCATIONS. MAINTAIN MINIMUM CLEARANCE AS REQUIRED BY CODE.

GENERAL NOTES

- GENERAL CONTRACTOR TO SCHEDULE WITH LOCAL REFRIGERATION CONTRACTOR TO CONDUCT INITIAL FOOD CASE START-UP AND TESTING. FOR LIST OF APPROVED START UP CONTRACTORS, CONTACT PROJECT CONSTRUCTION REPRESENTATIVE.
 - THE SITE IS SERVED BY THE MUNICIPAL WATER AND SEWER SYSTEM UNLESS OTHERWISE NOTED.
 - ALL FOOD STORAGE SHALL BE 6" (150mm) A.F.F.
 - ALL WOOD SURFACES (DOORS, TRIM, SHELVES, CABINETS) SHALL BE SEALED.
 - ALL EQUIPMENT AND INSTALLATION WILL MEET NATIONAL SANITATION FOUNDATION STANDARDS OR EQUIVALENT.
 - ALL EQUIPMENT AND CABINETS WILL BE FLUSH MOUNTED TO COUNTERTOPS, WALLS OR FLOORS, OR BE RAISED TO ALLOW FOR CLEANING.
 - CONFIRM ALL NECESSARY EQUIPMENT CLEARANCES PER PRODUCT CUT SHEET (E.G. ICE MACHINE).
 - FOR LOCATION OF COUNTERTOP EQUIPMENT, REFER TO CASEWORK ELECTRICAL DETAILS.
 - EQUIPMENT UNITS SHALL CONTAIN NO EXPOSED THREADS, EMBELLISHMENTS OR OVERHANGING EDGES THAT SERVE AS PLACES FOR ACCUMULATION OF DUST, DIRT AND DEBRIS.
 - WARMING OVEN(S) SHOWN FOR PERMITTING PURPOSES. INSTALLATION AT STORE OPENING TO BE VERIFIED BY STARBUCKS CONSTRUCTION REPRESENTATIVE.
 - EACH HAND WASHING SINK WILL HAVE A SINGLE SERVICE TOWEL AND SOAP DISPENSER, AND ALL HAND SINKS TO HAVE A COMBINATION FAUCET OR PREMIXING FAUCET.
 - FOR PLUMBING FIXTURES, REFER TO THE PLUMBING DESIGN PLAN. FOR DATA DEVICE SCHEDULE, REFER TO THE ELECTRICAL DESIGN PLAN.
 - SEE ELEVATIONS FOR DISTRIBUTION OF CUP DISPENSERS.
 - PROVIDE FIRE EXTINGUISHERS AS NOTED ON THE APPROVED PLANS FROM THE LOCAL JURISDICTION.
- NOTE: REFER SHEET I601 & I602 FOR DATA DEVICE, FURNITURE, GRAPHICS, PLUMBING FIXTURE, SPECIALTY EQUIPMENT, AND MECHANICAL EQUIPMENT SCHEDULE.

LEGEND

- ITEM/EQUIPMENT FOR FUTURE
 - EXISTING ITEM/EQUIPMENT TO BE REUSED
 - EXISTING ITEM/EQUIPMENT TO REMAIN
 - ADJACENT TENANT
- NOTE: LEGEND IS DEPENDENT ON COLORS USED FOR COMPLETE SCOPE INFORMATION.

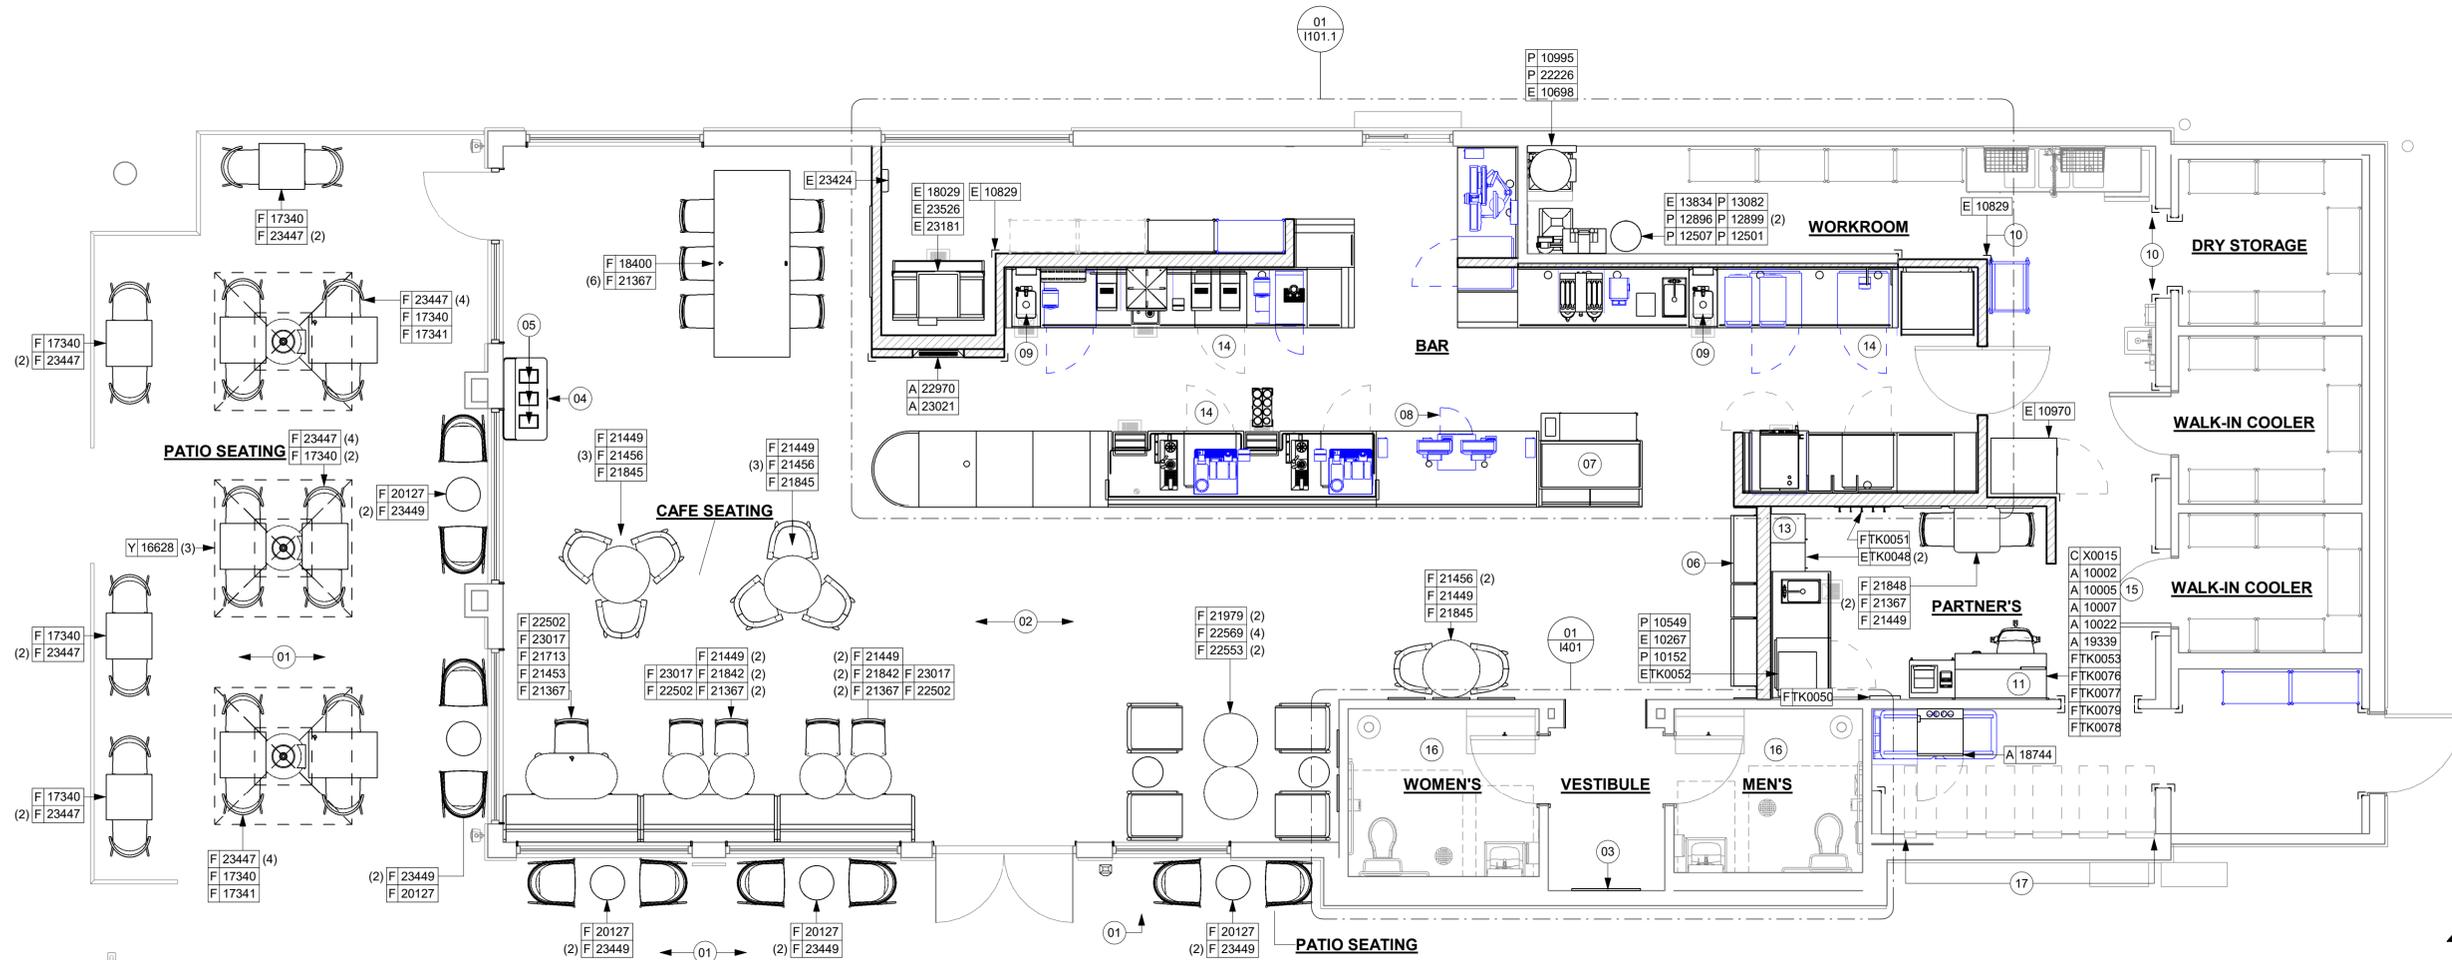

01 FURNITURE, FIXTURES AND EQUIPMENT PLAN
Scale: 1/4" = 1'-0"

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DESIGN MANAGER: ROMINA VIGNOLO
PRODUCTION DESIGNER: GENSLER
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Revision Schedule			
Rev	Date	By	Description

SHEET TITLE:
FF & E PLAN

SCALE: AS SHOWN

SHEET NUMBER:
1101



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STARBUCKS TEMPLATE VERSION: i2024.01.01

PABLO GARCIA, AIA, REG. FL NO. AR99297

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PROJECT NAME:
A1A & 10TH

PROJECT ADDRESS:
**975 3RD STREET SOUTH
JACKSONVILLE BEACH, FL
32250**

STORE #: 8565
PROJECT #: 18756-108
ISSUE DATE: 03-27-2024
DESIGN MANAGER: ROMINA VIGNOLO
PRODUCTION DESIGNER: GENSLER
CHECKED BY: GENSLER

Revision Schedule			
Rev	Date	By	Description

SHEET TITLE:
ENLARGED FF & E

SCALE: AS SHOWN

SHEET NUMBER:
1101.1

PERMIT SET - FOR CONSTRUCTION USE

LEGEND

- ITEM/EQUIPMENT FOR FUTURE
- EXISTING ITEM/EQUIPMENT TO BE REUSED
- EXISTING ITEM/EQUIPMENT TO REMAIN
- ADJACENT TENANT

NOTE: LEGEND IS DEPENDENT ON COLORS USED FOR COMPLETE SCOPE INFORMATION.


KEYED NOTES

- 01 GENERAL CONTRACTOR TO REVERSE DOOR HINGE ON UNDER COUNTER REFRIGERATOR TO LEFT HAND SWING, AS SHOWN.
- 02 DO NOT BLOCK FOOD CASE INTAKE/EXHAUST.
- 03 SAFE LOCATED AT POS CABINET. SEE ELECTRICAL SHEETS FOR ADDITIONAL INFORMATION.
- 04 HAND SINK W/INTEGRAL SPLASH GUARD.
- 05 INSTALL NITRO EQUIPMENT AS INDICATED.
- 06 LED STRIP LIGHT UNDER COUNTER TOP.

GENERAL NOTES


- A. GENERAL CONTRACTOR TO SCHEDULE WITH LOCAL REFRIGERATION CONTRACTOR TO CONDUCT INITIAL FOOD CASE START-UP AND TESTING. FOR LIST OF APPROVED START UP CONTRACTORS, CONTACT PROJECT CONSTRUCTION REPRESENTATIVE.
- B. THE SITE IS SERVED BY THE MUNICIPAL WATER AND SEWER SYSTEM UNLESS OTHERWISE NOTED.
- C. ALL FOOD STORAGE SHALL BE 6" (150mm) A.F.F.
- D. ALL WOOD SURFACES (DOORS, TRIM, SHELVES, CABINETS) SHALL BE SEALED.
- E. ALL EQUIPMENT AND INSTALLATION WILL MEET NATIONAL SANITATION FOUNDATION STANDARDS OR EQUIVALENT.
- F. ALL EQUIPMENT AND CABINERY WILL BE FLUSH MOUNTED TO COUNTERS, WALLS OR FLOORS, OR BE RAISED TO ALLOW FOR CLEANING.
- G. CONFIRM ALL NECESSARY EQUIPMENT CLEARANCES PER PRODUCT CUT SHEET (E.G. ICE MACHINE).
- H. FOR LOCATION OF COUNTERTOP EQUIPMENT, REFER TO CASEWORK ELECTRICAL DETAILS.
- I. EQUIPMENT UNITS SHALL CONTAIN NO EXPOSED THREADS, EMBELLISHMENTS OR OVERHANGING EDGES THAT SERVE AS PLACES FOR ACCUMULATION OF DUST, DIRT AND DEBRIS.
- J. WARMING OVEN(S) SHOWN FOR PERMITTING PURPOSES. INSTALLATION AT STORE OPENING TO BE VERIFIED BY STARBUCKS CONSTRUCTION REPRESENTATIVE.
- K. EACH HAND WASHING SINK WILL HAVE A SINGLE SERVICE TOWEL AND SOAP DISPENSER, AND ALL HAND SINKS TO HAVE A COMBINATION FAUCET OR PREMIXING FAUCET.
- L. FOR PLUMBING FIXTURES, REFER TO THE PLUMBING DESIGN PLAN. FOR DATA DEVICE SCHEDULE, REFER TO THE ELECTRICAL DESIGN PLAN.
- M. SEE ELEVATIONS FOR DISTRIBUTION OF CUP DISPENSERS.
- N. PROVIDE FIRE EXTINGUISHERS AS NOTED ON THE APPROVED PLANS FROM THE LOCAL JURISDICTION.

NOTE:
REFER SHEET I601 & I602 FOR DATA DEVICE, FURNITURE, GRAPHICS, PLUMBING FIXTURE, SPECIALTY EQUIPMENT, AND MECHANICAL EQUIPMENT SCHEDULE.

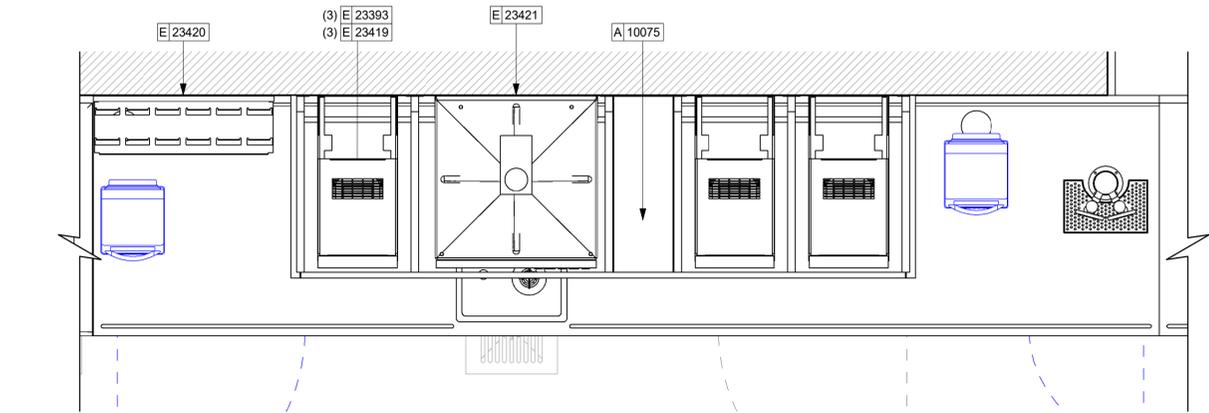


02 ENLARGED SIREN SYSTEM PLAN

Scale: 1" = 1'-0"

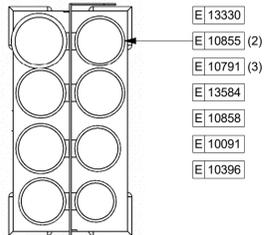

03 CUP HOLDER

Scale: 1 1/2" = 1'-0"

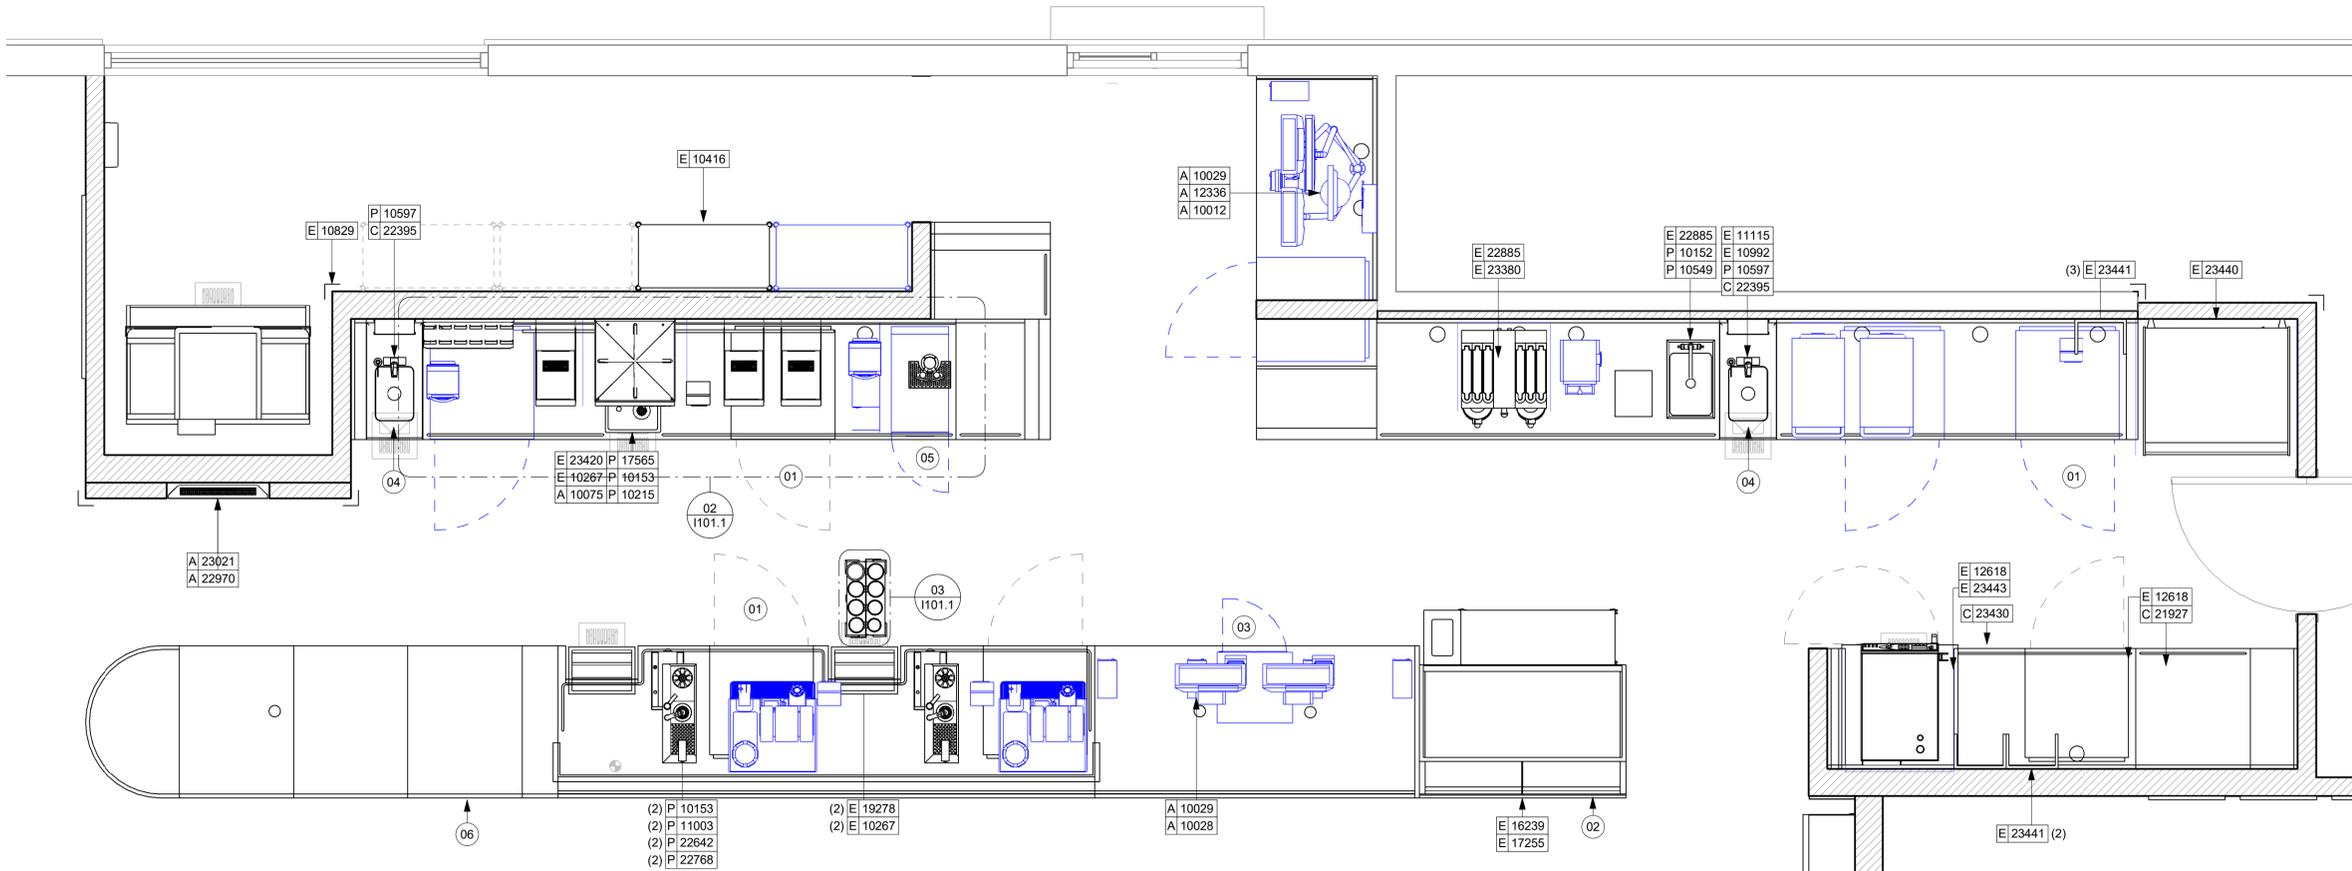

01 FURNITURE, FIXTURES AND EQUIPMENT ENLARGED PLAN

Scale: 1/2" = 1'-0"



CASEWORK SCHEDULE - "C"					
DESIGN ID	COUNT	DESCRIPTION	FURN. BY	INST. BY	COMMENTS
X0001	17	WOOD TRIM - 6 1/2X1 1/2IN 152X38MM - WHITE OAK WD0073.	SB	GC	TO BE PROVIDED BY CASEWORK VENDOR. REQUIRED (V.I.F.); (1)3'-10", (2) 7'-6"
X0010	20	WOOD TRIM - "X" IN "X" MM (VIF) X 3/4IN 20MM - "X"	SB	GC	GC TO VERIFY ALL DIMENSIONS AND NOTIFY SB/VD ANY DISCREPANCIES. TO BE PROVIDED BY CASEWORK VENDOR.
X0015	1	DECORATIVE METAL TRIM - 5X1/8IN 127X3MM	SB	GC	MATERIAL: ALUMINIUM. FINISH: POWDERCOATED FLAT BLACK MT0028. GC TO VERIFY ALL DIMENSIONS AND NOTIFY SB/VD ANY DISCREPANCIES. TO BE PROVIDED BY CASEWORK VENDOR
CABINET					
19281	2	CABINET - ESPRESSO ICE BIN STAINLESS - 20IN 510MM	SB	GC	
21890	39	CABINET - SIDE PANEL	SB	GC	
21891	11	CABINET - BOTTOM SHELF - 15IN 380MM	SB	GC	
21892	8	CABINET - BACK PANEL - 15IN 380MM	SB	GC	
21893	5	CABINET - ADJUSTABLE SHELF - 15IN 380MM	SB	GC	
21894	6	CABINET - DOOR - 15IN 380MM	SB	GC	
21895	9	CABINET - DOOR TRASH - 15IN 380MM	SB	GC	
21896	2	CABINET - DRAWER - 15IN 380MM	SB	GC	
21898	3	CABINET - BOTTOM SHELF - 18IN 455MM	SB	GC	
21899	3	CABINET - BACK PANEL - 18IN 455MM	SB	GC	
21900	2	CABINET - ADJUSTABLE SHELF - 18IN 455MM	SB	GC	
21901	3	CABINET - DOOR - 18IN 455MM	SB	GC	
21902	6	CABINET - BOTTOM SHELF - 30IN 760MM	SB	GC	
21903	3	CABINET - BACK PANEL - 30IN 760MM	SB	GC	
21904	9	CABINET - ADJUSTABLE SHELF - 30IN 760MM	SB	GC	
21905	3	CABINET - DOOR - 30IN 760MM	SB	GC	
21906	1	CABINET - END CAP FRONTBAR	SB	GC	
21907	4	CABINET - END CAP BACKBAR	SB	GC	
21908	7	CABINET - FILLER PANEL - VARIABLE LENGTH	SB	GC	
21909	1	CABINET - DT POS UPPER CUBBY - 32IN 815MM	SB	GC	
21910	1	CABINET - FRENCH CLEAT - VARIABLE LENGTH	SB	GC	DESIGNER TO VERIFY QUANTITY. PROVIDE OVERALL LENGTH REQUIRED.
21912	3	CABINET - BACK PANEL FOR POS - 30IN 760MM	SB	GC	
21913	2	CABINET - EQUIPMENT MOUNTING PANEL	SB	GC	
22749	1	CABINET - ESPRESSO PUMP MOUNT PANEL	SB	GC	

CASEWORK SCHEDULE - "C"					
DESIGN ID	COUNT	DESCRIPTION	FURN. BY	INST. BY	COMMENTS
22986	2	CABINET - DELIVERY DRAWER - 15IN 380MM	SB	GC	
23425	2	CABINET - WRM DOOR LOWERED COUNTER - 15IN 380MM	SB	GC	
CABINETS					
23712	1	CABINET - CBE UPPER CASEWORK TALL IN-LINE - RF - 82IN	SB	GC	
CAFE					
20117	2	CABINET - 36IN 915MM - WHITE OAK WD0073	SB	GC	
20118	1	CABINET - 18IN 455MM - WHITE OAK WD0073	SB	GC	
20377	1	WALL BAY ON STANDARD 3 UNIT - 90IN 2285MM - WHITE OAK WD0073	SB	GC	
23964	1	WASTE AND RECYCLE STATION THREE DROP - GOLDEN BLONDE AND WHITE PL0027 CP0002	SB	GC	
COUNTERTOP					
21918	1	COUNTERTOP - FILLER FRONTBAR - VARIABLE LENGTH	SB	GC	
21919	6	COUNTERTOP - FILLER BACKBAR - VARIABLE LENGTH	SB	GC	
21922	2	COUNTERTOP - FRONTBAR - 30IN 760MM	SB	GC	
21923	1	COUNTERTOP - END CAP FRONTBAR	SB	GC	
21926	2	COUNTERTOP - BACKBAR - 18IN 455MM	SB	GC	
21927	1	COUNTERTOP - BACKBAR - 30IN 760MM	SB	GC	
21928	4	COUNTERTOP - END CAP BACKBAR	SB	GC	
22328	1	COUNTERTOP - BREW - LF - 90IN 2285MM	SB	GC	
22352	1	COUNTERTOP - ESPRESSO FRONTBAR - LF - 141IN 3580MM	SB	GC	
22354	1	COUNTERTOP - ESPRESSO SHROUD - 141IN 3580MM	SB	GC	
22361	1	COUNTERTOP - POS - 84IN 2135MM	SB	GC	
22362	1	COUNTERTOP - DT POS - LF - 76IN 1930MM	SB	GC	
22377	1	COUNTERTOP - WARMING - RF - 92IN 2335MM	SB	GC	
22388	1	COUNTERTOP - CONSOLIDATED HANDOFF - 30IN 760MM	SB	GC	
22394	10	COUNTERTOP - BACKSPLASH - VARIABLE LENGTH	SB	GC	
22395	2	COUNTERTOP - HAND SINK LOW SPLASH - 15IN 380MM	SB	GC	
22404	1	COUNTERTOP - END CAP FRONTBAR ROUNDED	SB	GC	
23151	1	COUNTERTOP - PARTNER AMENITY - 67IN 1700MM	SB	GC	
23403	1	COUNTERTOP - CBE IN-LINE RF - 139IN 3530MM	SB	GC	
23430	1	COUNTERTOP - WRM RF - 78IN 1980MM	SB	GC	
DIEWALL					
21885	18	DIEWALL - FRAMING - VARIABLE LENGTH	SB	GC	
21886	7	DIEWALL - BASE - VARIABLE LENGTH	SB	GC	
21887	7	DIEWALL - SUBSTRATE PANEL - VARIABLE LENGTH	SB	GC	
21888	54	DIEWALL - SUPPORT LEG	SB	GC	
22405	1	DIEWALL - END CAP ROUNDED	SB	GC	
23439	1	DIEWALL - WRM STRUCTURE LOWERED COUNTER	SB	GC	
OTHER					
11155	2	ESPRESSO MACHINE PUMP MOUNT - 10X10IN 255X255MM	SB	GC	
21914	9	FRIDGE STOP BRACKET SET	SB	GC	
PANEL					
21933	7	FINISH PANEL - VARIABLE LENGTH	SB	GC	
22406	1	FINISH PANEL - END CAP ROUNDED	SB	GC	
TRIM					
X0006	6	METAL TRIM - 5X1/8IN 127X3MM	SB	GC	FINISH: POWDERCOATED FLAT BLACK MT0028. MATERIAL: ALUMINIUM. GC TO VERIFY ALL DIMENSIONS AND NOTIFY SB/VD ANY DISCREPANCIES.

KEYED NOTES


- DO NOT CAULK TRASH RINGS TO COUNTERTOPS.
- INSTALL CONDIMENT CART AS INDICATED.
- WALL FINISH BEHIND EXPOSED CABINETS AND BELOW UNDERSIDE OF COUNTERTOP SUBSTRATE TO BE WHITE FRP, EXCEPT AT WARMING WALL.
- INSTALL DRIVE-THRU POS CUBBY TO ALIGN WITH FINISH FACE OF WALL.
- VARIABLE WIDTH FILLER CABINET / COUNTERTOP REQUIRED TO FILL GAP (FIELD VERIFY DIMENSION). FILLER PANEL AND COUNTERTOP SHALL BE SCRIBED AND FIELD CUT TO FIT.
- INSTALL MERCH UNIT AS INDICATED.
- INSTALL METAL TRIM TRANSITION AS INDICATED.
- OUTLINE OF HEADER ABOVE FOR REFERENCE.
- BANQUETTE OUTLINE FOR REFERENCE.
- INSTALL CORNER GUARD AT OUTSIDE CORNER AS INDICATED. REFER TO DETAIL.
- COMMUNITY TABLE OUTLINE FOR REFERENCE.
- INSTALL WOOD TRIM VESTIBULE OPENING AS INDICATED.

GENERAL NOTES

- GENERAL CONTRACTOR TO NOTIFY CONSTRUCTION MANAGER IMMEDIATELY IF A DISCREPANCY EXISTS BETWEEN CASEWORK SHOP DRAWINGS, EXISTING SITE CONDITIONS, ARCHITECTURAL DRAWINGS OR BUILT FIXTURES. ALL DIMENSIONS SHALL BE FIELD VERIFIED BY G.C.
- STARBUCKS CONSTRUCTION MANAGER TO COORDINATE AND SCHEDULE CASEWORK DELIVERY DATE. GENERAL CONTRACTOR TO CONFIRM CASEWORK DELIVERY DATE WITH CASEWORK MANUFACTURER AT FOUR (4) WEEKS PRIOR AND THEN ONE (1) WEEK PRIOR TO SCHEDULED DATE OF DELIVERY.
- STARBUCKS CONTRACTS DIRECTLY WITH CASEWORK VENDOR TO SUPPLY CASEWORK LISTED IN THE CASEWORK SCHEDULE, UNLESS OTHERWISE NOTED.
- CASEWORK VENDOR TO PROVIDE COMPLETE SHOP DRAWINGS AND INSTALLATION PACKAGE TO GENERAL CONTRACTOR TO FACILITATE PROPER INSTALLATION.
- ALL CASEWORK BOX BASES SHALL BE SET AND LEVELED USING 1/4" (6 MM) NON-ABSORBENT PLASTIC SHIMS PROVIDED BY CASEWORK VENDOR.
- SEE INTERIOR FINISH ELEVATIONS AND SCHEDULES FOR EXTENSIONS TO THIS PROJECT WITHOUT THE PRIOR WRITTEN CONSENT OF STARBUCKS CORPORATION. THESE DRAWINGS AND SPECIFICATIONS ARE INTENDED TO EXPRESS DESIGN INTENT FOR A PROTOTYPICAL STARBUCKS STORE (WHICH IS SUBJECT TO CHANGE AT ANYTIME) AND DO NOT REFLECT ACTUAL SITE CONDITIONS. NEITHER PARTY SHALL HAVE ANY OBLIGATION NOR LIABILITY TO THE OTHER (EXCEPT STATED ABOVE) UNTIL A WRITTEN AGREEMENT IS FULLY EXECUTED BY BOTH PARTIES.
- SEE REFLECTED CEILING PLAN FOR ABOVE BAR SOFFIT LOCATIONS.
- REFERENCE PLUMBING AND ELECTRICAL PLANS FOR LOCATION AND TAGGING OF WALL TREATMENTS BY CV AND OTHERS.

LEGEND

- INDICATES STAINLESS STEEL (SS) COUNTERTOP
- INDICATES SOLID SURFACE (SS) COUNTERTOP
- DATUM POINT

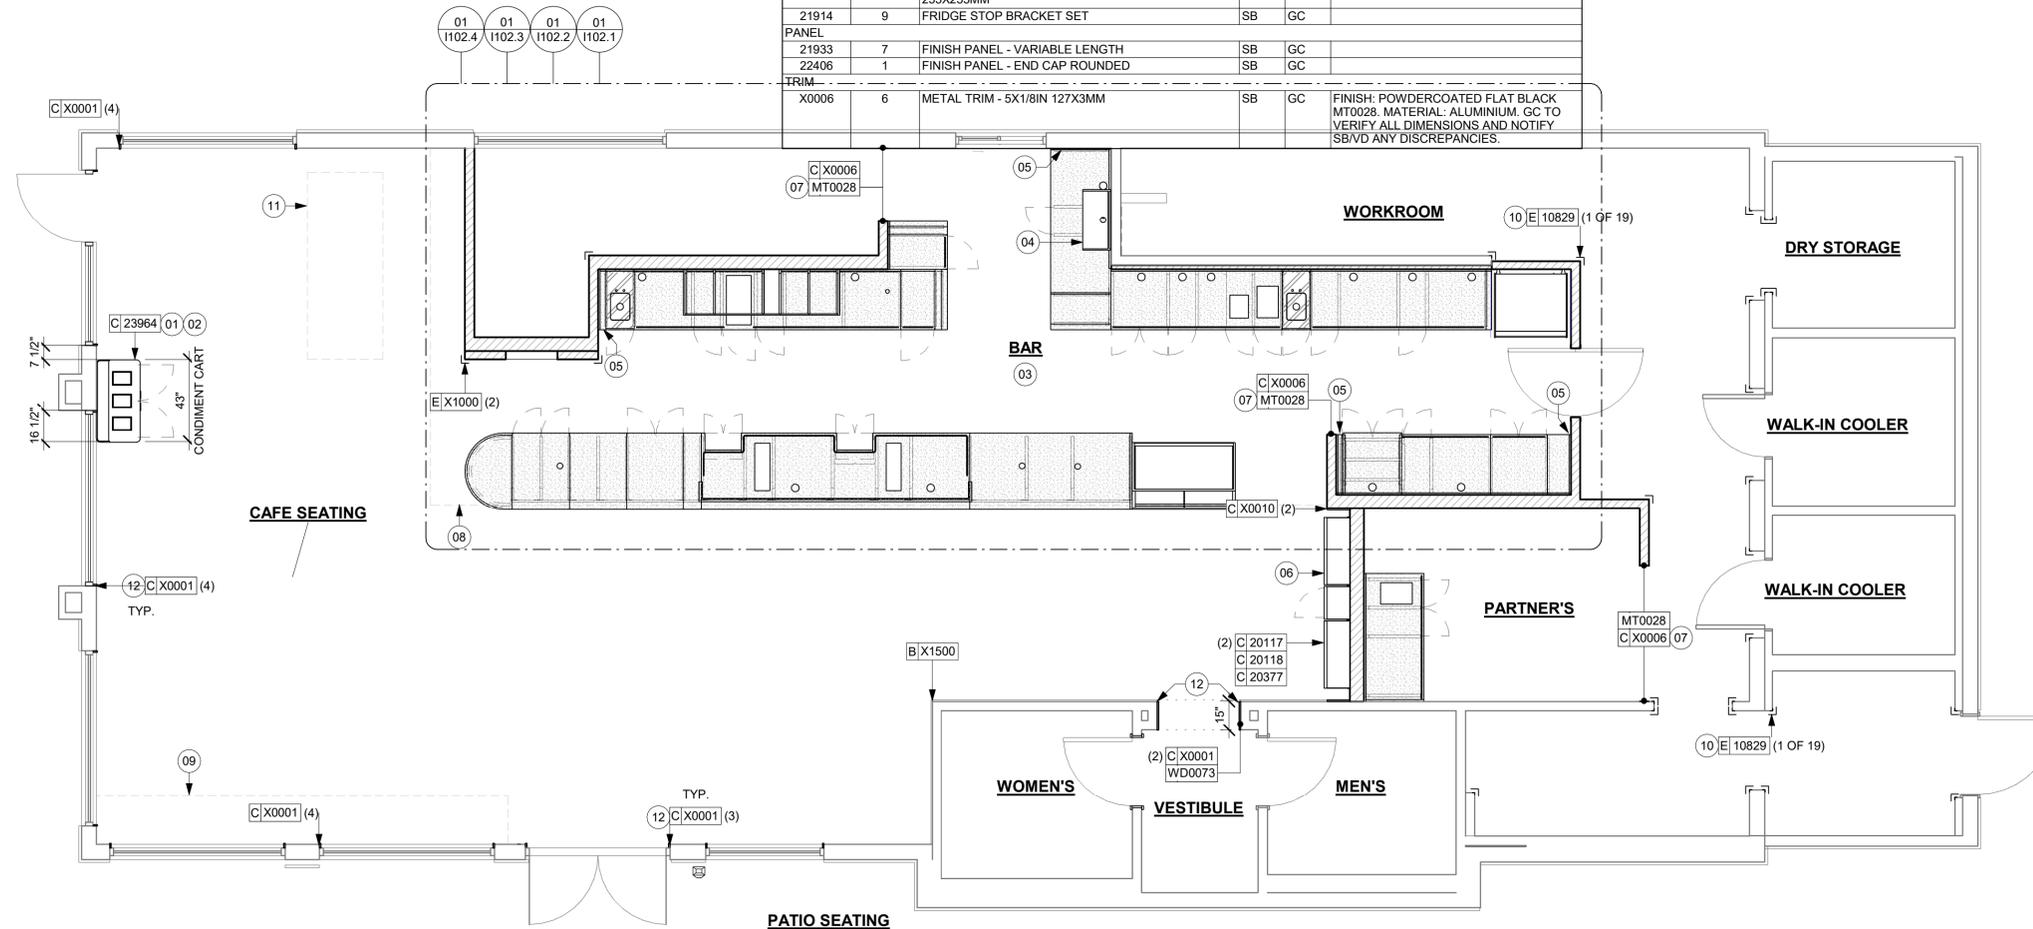

01 CASEWORK PLAN
Scale: 1/4" = 1'-0"

PERMIT SET - FOR CONSTRUCTION USE



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STORE #: 8565
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DESIGN MANAGER: ROMINA VIGNOLO
PRODUCTION DESIGNER: GENSLER
CHECKED BY: GENSLER

Revision Schedule			
Rev	Date	By	Description

SHEET TITLE:
CASEWORK PLAN

SCALE: AS SHOWN

SHEET NUMBER:
1102



ADAPTABLE CASEWORK SUPPORT LEG AND DIEWALL BASE SCHEDULE "C"					
DESIGN ID	COUNT	DESCRIPTION	FURN. BY	INST. BY	COMMENTS
21886	7	DIEWALL - BASE - VARIABLE LENGTH	SB	GC	
21888	54	DIEWALL - SUPPORT LEG	SB	GC	
22405	1	DIEWALL - END CAP ROUNDED	SB	GC	
23439	1	DIEWALL - WRM STRUCTURE LOWERED COUNTER	SB	GC	

CASEWORK FINISH SCHEDULE			
ENGINE ZONE	MATERIAL DESCRIPTION	FINISH CODE	COMMENTS
COMPOSITE - BRUSHED WARM GREY			
COUNTERTOPS - BACKBAR	COMPOSITE - BRUSHED WARM GREY	CP0056	
COUNTERTOPS - ESPRESSO	COMPOSITE - BRUSHED WARM GREY	CP0056	
COUNTERTOPS - ESPRESSO SHROUD	COMPOSITE - BRUSHED WARM GREY	CP0056	
COUNTERTOPS - FRONTBAR	COMPOSITE - BRUSHED WARM GREY	CP0056	
COMPOSITE - MATTE BLACK MOTTLED PAPER			
CABINETS - EXTERIOR	COMPOSITE - MATTE BLACK MOTTLED PAPER	CP0024	
CUSTOM PLAM - WILSONART - KHAKI BROWN D50-60 - MATTE FINISH			
CABINETS - UPPER	CUSTOM PLAM - WILSONART - KHAKI BROWN D50-60 - MATTE FINISH	X0600	
METAL - FLAT BLACK POWDERCOAT			
FRAMING AND HARDWARE	METAL - FLAT BLACK POWDERCOAT	MT0028	
METAL - STAINLESS STEEL - BRUSHED			
CABINETS - UNDERCOUNTER ICE BIN	METAL - STAINLESS STEEL - BRUSHED	#4 BRUSHED 16GA	
COUNTERTOPS - HAND SINK	METAL - STAINLESS STEEL - BRUSHED	#4 BRUSHED 16GA	
FRAMING AND HARDWARE	METAL - STAINLESS STEEL - BRUSHED	#4 BRUSHED 16GA	
PLAM - MOTTLED BLACK			
CABINETS - DT POS CUBBY	PLAM - MOTTLED BLACK	PL0019	
PLASTIC - BLACK			
CABINETS - EXTERIOR	PLASTIC - BLACK	PL0044	
CABINETS - INTERIOR	PLASTIC - BLACK	PL0044	
CABINETS - UPPER	PLASTIC - BLACK	PL0044	
FRAMING AND HARDWARE	PLASTIC - BLACK	PL0044	
PLASTIC - BLACK HDPE			
CABINETS - INTERIOR	PLASTIC - BLACK HDPE	PL0044	
WOOD - WHITE OAK - PLANK - VERTICAL			
FINISH PANELS	WOOD - WHITE OAK - PLANK - VERTICAL	WD0073	
FINISH PANELS - FRONTBAR	WOOD - WHITE OAK - PLANK - VERTICAL	WD0073	

KEYED NOTES

- 01 CASEWORK FRAMEWORK ABOVE.
- 02 FOOD CASE BASE.
- 03 CASEWORK SUPPORT ADJACENT TO WALL TO SIT ON STEEL ANGLE FASTENED TO WALL.
- 05 FOOD CASE WARMING WALL STATION.
- 06 WARMING STRUCTURE.

GENERAL NOTES

- A. SEE SHEET I102 FOR COMPLETE CASEWORK SCHEDULE.
- B. METAL COMPONENTS PROVIDED BY CASEWORK SUPPLIER UNLESS OTHERWISE NOTED.
- C. DIEWALL AND BOX BASES TO BE INSTALLED PRIOR TO FLOORING MATERIAL INSTALLATION.
- D. G.C. TO INSTALL BLOCKING BETWEEN DIEWALL BASE.
- E. ALL DIMENSIONS TAKEN FROM FRONTLINE DATUM POINT TO OUTSIDE CORNER OF DIEWALL BASE.
- F. BOX BASE (IF APPLICABLE) BUTTS UP AGAINST INSIDE FACE OF DIEWALL. PROVIDE SEALANT AT SEAM.
- G. LEVEL BOX BASES TO BOTTOM RAIL OF WALL FRAME.

LEGEND

-  VARIABLE LENGTH BOX BASE
-  CABINET LEG
-  DATUM POINT



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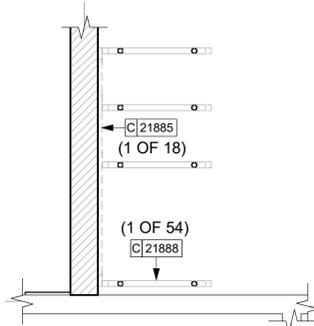
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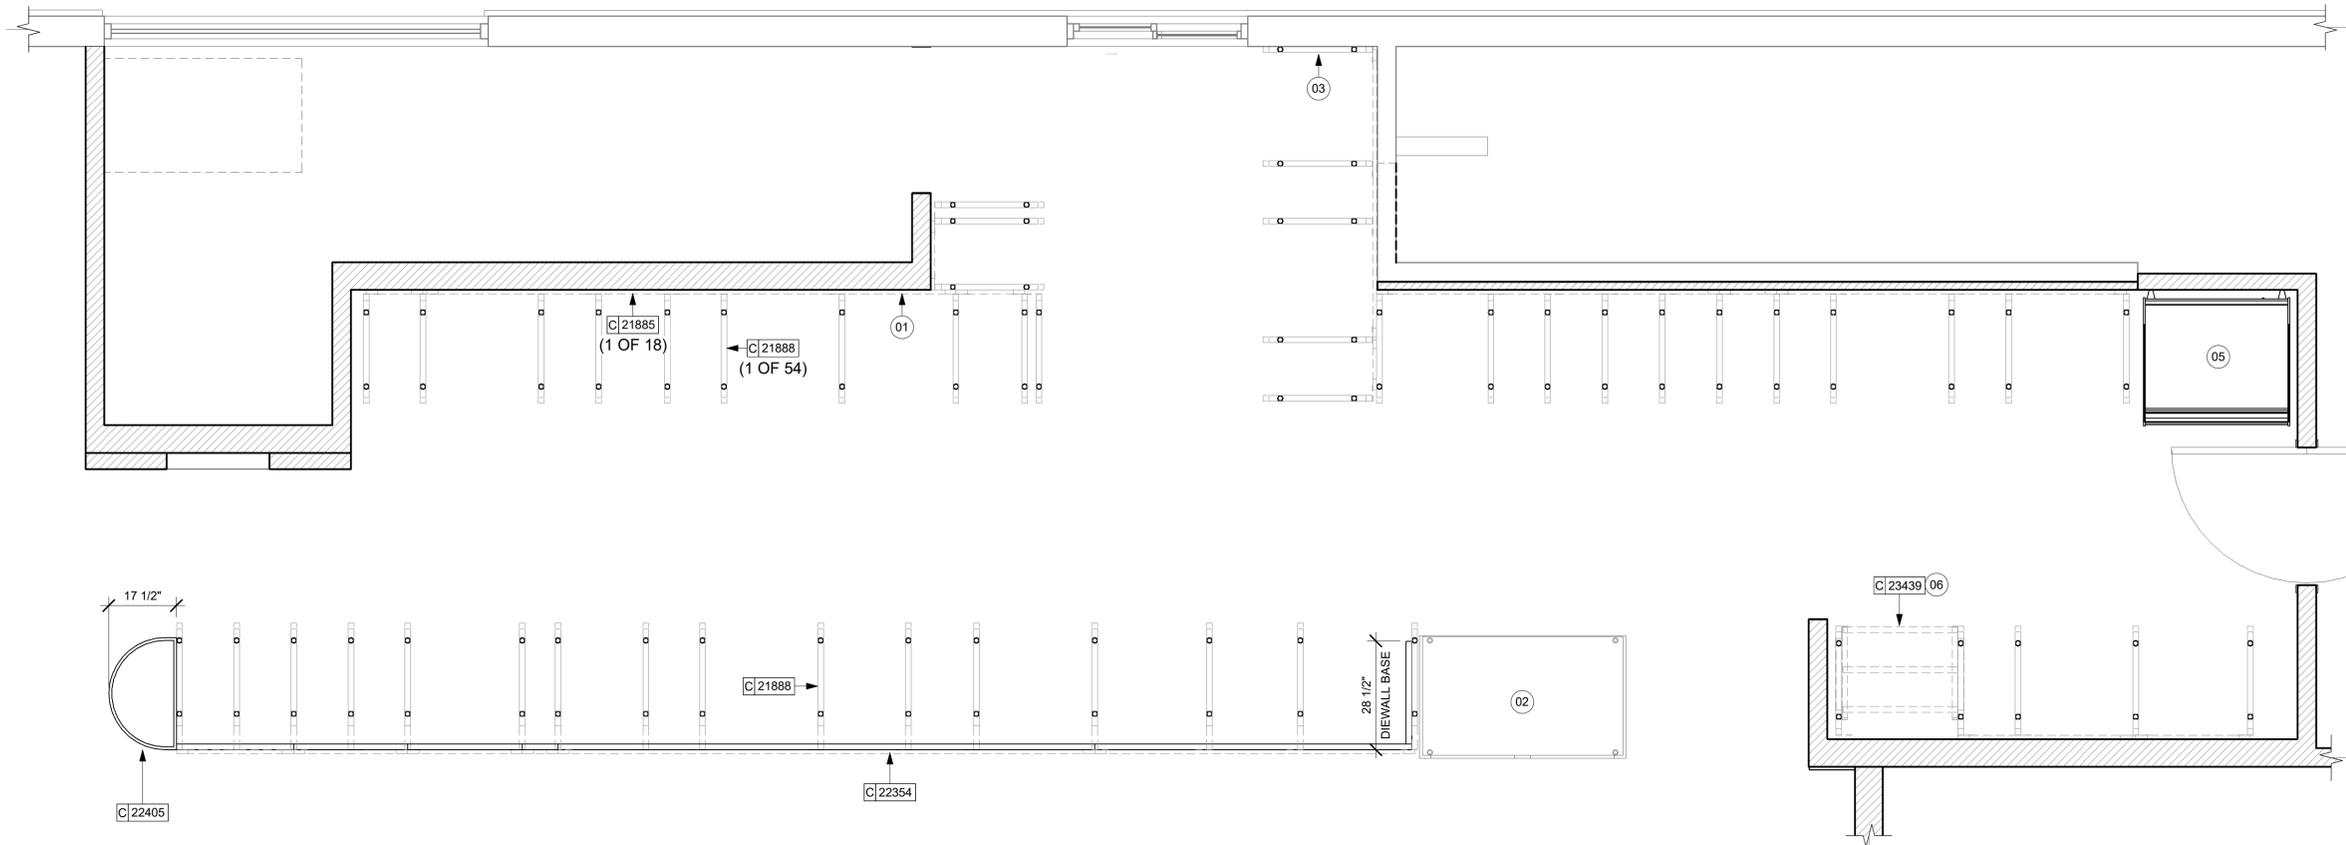
SHEET TITLE:
**ADAPTABLE CASEWORK
BASE PLAN**
SCALE: AS SHOWN

SHEET NUMBER:
1102.1

PERMIT SET - FOR CONSTRUCTION USE



03 A. CASEWORK BASE PLAN PARTNER'S
Scale: 1/2" = 1'-0"



01 ADAPTABLE CASEWORK BASE PLAN
Scale: 1/2" = 1'-0"

ADAPTABLE CASEWORK FRAMEWORK SCHEDULE - "C"					
DESIGN ID	COUNT	DESCRIPTION	FURN. BY	INST. BY	COMMENTS
21885	18	DIEWALL - FRAMING - VARIABLE LENGTH	SB	GC	
21888	54	DIEWALL - SUPPORT LEG	SB	GC	
23439	1	DIEWALL - WRM STRUCTURE LOWERED COUNTER	SB	GC	

ADAPTABLE CASEWORK FRAMEWORK SCHEDULE - "C"					
DESIGN ID	COUNT	DESCRIPTION	FURN. BY	INST. BY	COMMENTS
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21888	54	DIEWALL - SUPPORT LEG	SB	GC	
23439	1	DIEWALL - WRM STRUCTURE LOWERED COUNTER	SB	GC	

KEYED NOTES

- 01 PROVIDE 3/4" BLOCKING TO 34" A.F.F. FOR ALL WALL BRACKETS TO SUPPORT CASEWORK LEG.
- 02 FOOD CASE.
- 03 CUSTOM CORNER. FABRICATE USING TRADITIONAL CASEWORK CONSTRUCTION.
- 04 ALIGN FRAMEWORK.
- 05 METAL SUPPORT LEG ADJACENT TO WALL TO BE SUPPORTED BY METAL ANGLE FASTENED TO WALL PER CONSTRUCTION DETAILS.
- 06 DIMENSIONS LOCATING SUPPORT LEG ARE TO CENTER OF FRAME.

GENERAL NOTES

- A. SEE SHEET I102 FOR COMPLETE CASEWORK SCHEDULE.
- B. METAL COMPONENTS PROVIDED BY CASEWORK SUPPLIER UNLESS OTHERWISE NOTED.
- C. G.C. TO PROVIDE CONTINUOUS WALL BLOCKING BEHIND CASEWORK.
- D. CASEWORK FRAME AT BAR ENDS ARE SUPPORTED BY 90 DEGREE DIEWALL BASE.
- E. ALL DIMENSIONS TAKEN FROM FRONTLINE DATUM POINT TO OUTSIDE CORNER OF DIEWALL BASE.
- F. TOP EDGE OF DIEWALL FRAME TO BE INSTALLED AT 32 13/16" A.F.F. AT LOW POINT.
- G. ALL DIMENSIONS ARE TO CENTER OF CABINET FRAME UNLESS NOTED OTHERWISE.



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STARBUCKS TEMPLATE VERSION: I2024.01.01

PABLO GARCIA, AIA, REG. FL NO. AR99297

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PROJECT NAME:
A1A & 10TH

PROJECT ADDRESS:
**975 3RD STREET SOUTH
JACKSONVILLE BEACH, FL
32250**


STORE #: 8565
PROJECT #: 18756-108
ISSUE DATE: 03-27-2024
DESIGN MANAGER: ROMINA VIGNOLO
PRODUCTION DESIGNER: GENSLER
CHECKED BY: GENSLER

Revision Schedule			
Rev	Date	By	Description

SHEET TITLE:
**ADAPTABLE CASEWORK
FRAMEWORK PLAN**
SCALE: AS SHOWN


SHEET NUMBER:
1102.2

PERMIT SET - FOR CONSTRUCTION USE

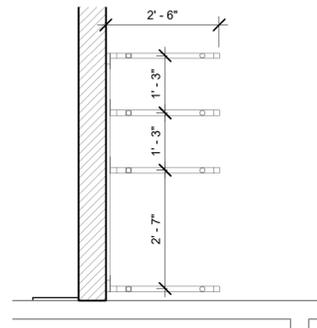

2 A. CASEWORK FRAMEWORK PLAN PARTNER'S

Scale: 1/2" = 1'-0"

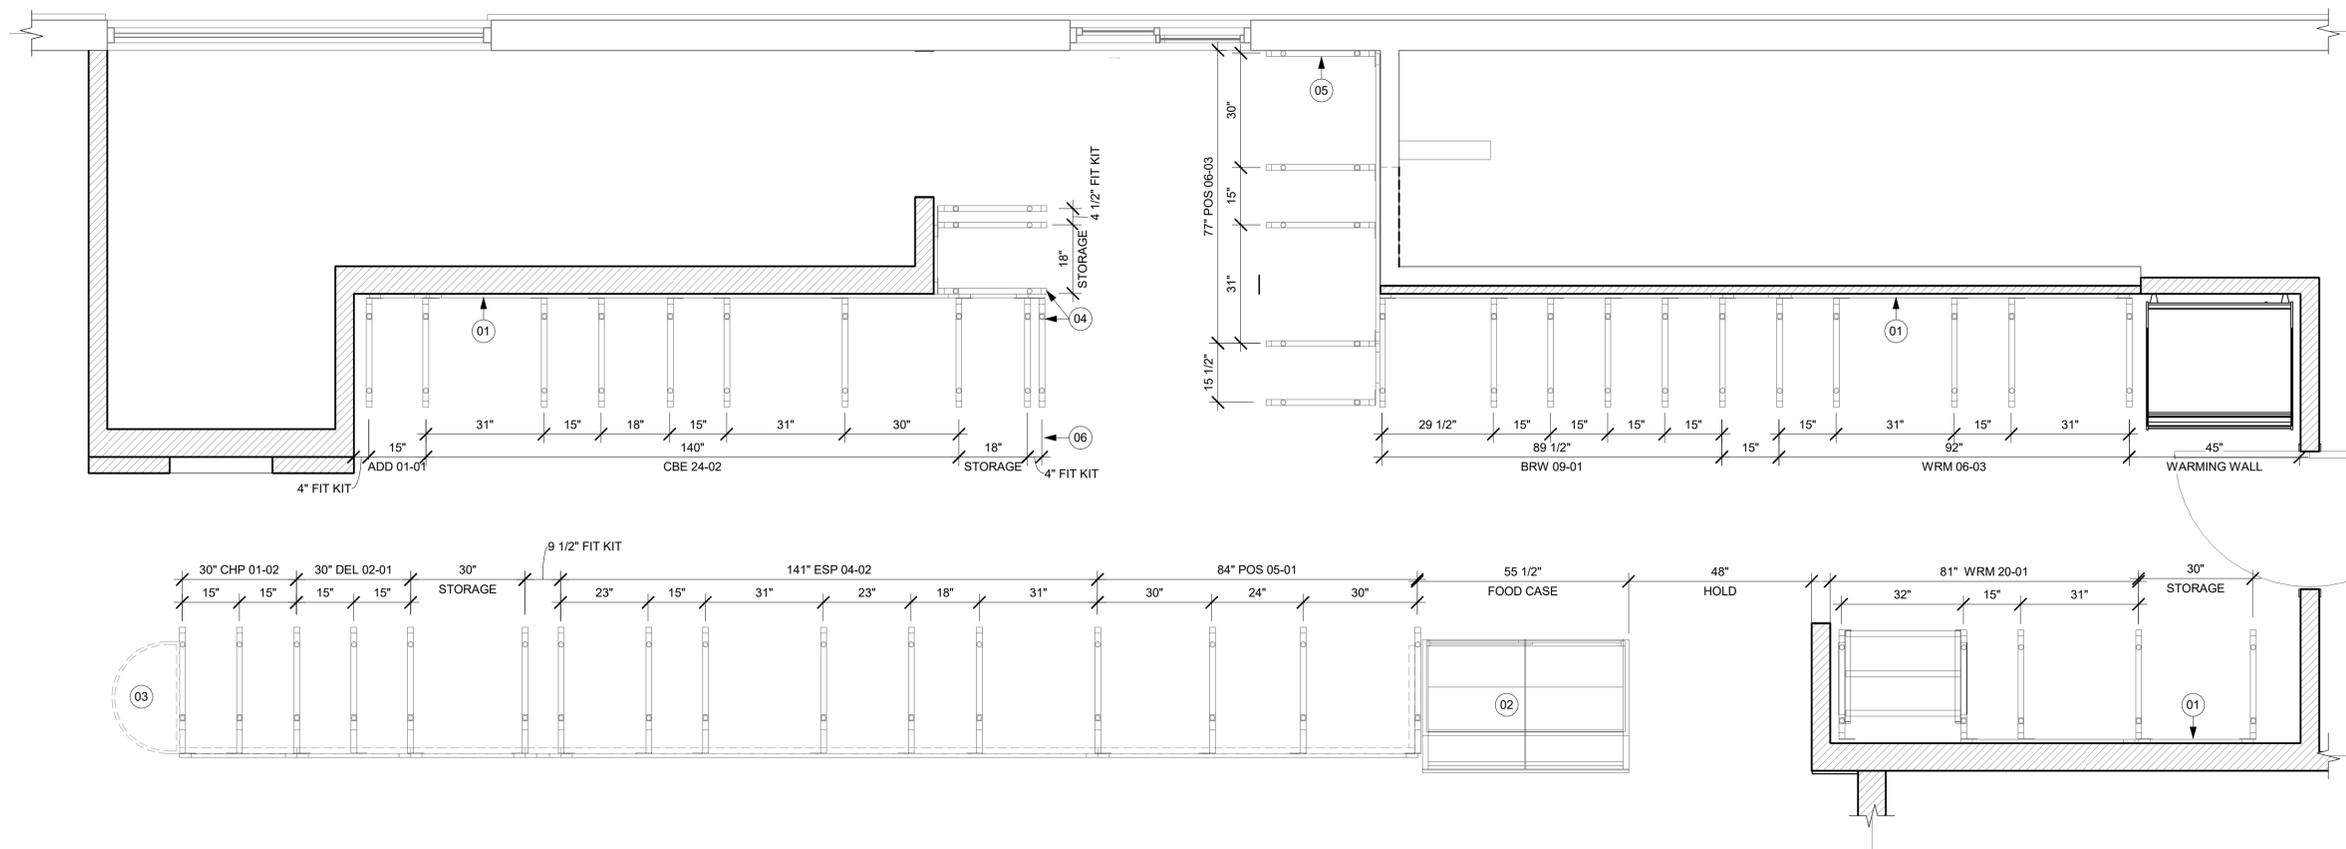

1 ADAPTABLE CASEWORK FRAMEWORK PLAN

Scale: 1/2" = 1'-0"



ADAPTABLE CASEWORK CABINET SCHEDULE - "C"					
DESIGN ID	COUNT	DESCRIPTION	FURN. BY	INST. BY	COMMENTS
X0001	17	WOOD TRIM - 6 1/2X1 1/2IN 152X38MM - WHITE OAK WD0073.	SB	GC	TO BE PROVIDED BY CASEWORK VENDOR. REQUIRED (V.I.F.): (1)3'-10", (2) 7'-8"
X0010	20	WOOD TRIM - "X" IN "X" MM (VIF) X 3/4IN 20MM - "X"	SB	GC	GC TO VERIFY ALL DIMENSIONS AND NOTIFY SB/VD ANY DISCREPANCIES. TO BE PROVIDED BY CASEWORK VENDOR.
X0015	1	DECORATIVE METAL TRIM - 5X1/8IN 127X3MM	SB	GC	MATERIAL: ALUMINIUM. FINISH: POWDERCOATED FLAT BLACK MT0028. GC TO VERIFY ALL DIMENSIONS AND NOTIFY SB/VD ANY DISCREPANCIES. TO BE PROVIDED BY CASEWORK VENDOR
CABINET					
19281	2	CABINET - ESPRESSO ICE BIN STAINLESS - 20IN 510MM	SB	GC	
21890	39	CABINET - SIDE PANEL	SB	GC	
21891	11	CABINET - BOTTOM SHELF - 15IN 380MM	SB	GC	
21892	8	CABINET - BACK PANEL - 15IN 380MM	SB	GC	
21893	5	CABINET - ADJUSTABLE SHELF - 15IN 380MM	SB	GC	
21894	6	CABINET - DOOR - 15IN 380MM	SB	GC	
21895	9	CABINET - DOOR TRASH - 15IN 380MM	SB	GC	
21896	2	CABINET - DRAWER - 15IN 380MM	SB	GC	
21898	3	CABINET - BOTTOM SHELF - 18IN 455MM	SB	GC	
21899	3	CABINET - BACK PANEL - 18IN 455MM	SB	GC	
21900	2	CABINET - ADJUSTABLE SHELF - 18IN 455MM	SB	GC	
21901	3	CABINET - DOOR - 18IN 455MM	SB	GC	
21902	6	CABINET - BOTTOM SHELF - 30IN 760MM	SB	GC	
21903	3	CABINET - BACK PANEL - 30IN 760MM	SB	GC	
21904	9	CABINET - ADJUSTABLE SHELF - 30IN 760MM	SB	GC	
21905	3	CABINET - DOOR - 30IN 760MM	SB	GC	
21906	1	CABINET - END CAP FRONTBAR	SB	GC	
21907	4	CABINET - END CAP BACKBAR	SB	GC	
21908	7	CABINET - FILLER PANEL - VARIABLE LENGTH	SB	GC	
21909	1	CABINET - DT POS UPPER CUBBY - 32IN 815MM	SB	GC	
21910	1	CABINET - FRENCH CLEAT - VARIABLE LENGTH	SB	GC	DESIGNER TO VERIFY QUANTITY. PROVIDE OVERALL LENGTH REQUIRED.
21912	3	CABINET - BACK PANEL FOR POS - 30IN 760MM	SB	GC	
21913	2	CABINET - EQUIPMENT MOUNTING PANEL	SB	GC	
22749	1	CABINET - ESPRESSO PUMP MOUNT PANEL	SB	GC	
22986	2	CABINET - DELIVERY DRAWER - 15IN 380MM	SB	GC	
23425	2	CABINET - WRM DOOR LOWERED COUNTER - 15IN 380MM	SB	GC	
CABINETS					
23712	1	CABINET - CBE UPPER CASEWORK TALL IN-LINE - RF - 82IN	SB	GC	
CAFE					
20117	2	CABINET - 36IN 915MM - WHITE OAK WD0073	SB	GC	
20118	1	CABINET - 18IN 455MM - WHITE OAK WD0073	SB	GC	
20377	1	WALL BAY ON STANDARD 3 UNIT - 90IN 2285MM - WHITE OAK WD0073	SB	GC	
23964	1	WASTE AND RECYCLE STATION THREE DROP - GOLDEN BLONDE AND WHITE PL0027 CP0002	SB	GC	
OTHER					
11155	2	ESPRESSO MACHINE PUMP MOUNT - 10X10IN 255X255MM	SB	GC	

ADAPTABLE CASEWORK CABINET SCHEDULE - "C"					
DESIGN ID	COUNT	DESCRIPTION	FURN. BY	INST. BY	COMMENTS
21914	9	FRIDGE STOP BRACKET SET	SB	GC	
PANEL					
21933	7	FINISH PANEL - VARIABLE LENGTH	SB	GC	
22406	1	FINISH PANEL - END CAP ROUNDED	SB	GC	
TRIM					
X0006	6	METAL TRIM - 5X1/8IN 127X3MM	SB	GC	FINISH: POWDERCOATED FLAT BLACK MT0028. MATERIAL: ALUMINIUM. GC TO VERIFY ALL DIMENSIONS AND NOTIFY SB/VD ANY DISCREPANCIES.

ADAPTABLE CASEWORK CABINET TYPES AND BILL OF MATERIALS SCHEDULE											
KEY NUMBER	CABINET TYPE	FULL HT. DOORS	3/4 DOOR	3/4 DOOR W/ VENT	DRAWER	BOTTOM SHELF	ADJUST. SHELF	BACK PANEL	SIDE PANELS	BOX BASE ^{AA}	
101	15" STORAGE	1 DID 21894	N/A	N/A	N/A	1 DID 21891	1 DID 21893	1 DID 21892	2 ^{**} DID 21890	NO	
102	18" STORAGE	1 DID 21901	N/A	N/A	N/A	1 DID 21898	1 DID 21900	1 DID 21899	2 ^{**} DID 21890	NO	
103	30" STORAGE	2 DID 21905	N/A	N/A	N/A	1 DID 21902	1 DID 21904	1 DID 21903	2 ^{**} DID 21890	NO	
104	30" POS	N/A	N/A	N/A	N/A	1 DID 21902	2 DID 21904	1 DID 21912	2 ^{**} DID 21890	NO	
105	21" POS	N/A	N/A	N/A	N/A	1 DID 22982	2 DID 22980	1 DID 22981	2 ^{**} DID 21890	NO	
106	15" DRAWER	N/A	1 DID 21895	N/A	1 DID 21896	1 DID 21891	1 DID 21893	1 DID 21892	2 ^{**} DID 21890	NO	
107	15" PRODUCTION CONTROLLER	N/A	N/A	1 DID 21897	1 DID 21896	1 DID 21891	1 DID 21893	1 DID 21892	2 ^{**} DID 21890	NO	
108	15" CUBBY - COFFEE	N/A	N/A	N/A	N/A	1 DID 21891	1 DID 21893	1 DID 21892	2 ^{**} DID 21890	NO	
109	15" CUBBY - TRASH	N/A	1/0" DID 21895	N/A	N/A	N/A	0	0	2 ^{**} DID 21890	NO	
110	15" SINK	1/0" DID 21894	N/A	N/A	N/A	1 ^A DID 21891	0	0	2 ^{**} DID 21890	NO	
111	15" ICE BIN	1/0" DID 21894	N/A	N/A	N/A	N/A	0	0	0 (1,2) ^{**} DID 21890	NO	
112	24" SAFE	N/A	N/A	N/A	N/A	N/A	0	0	0 (1,2) ^{**} DID 21890	NO	
113	30" REFRIGERATOR	N/A	N/A	N/A	N/A	N/A	0	0	0 (1,2) ^{**} DID 21890	NO	
114	15" DEL	N/A	N/A	N/A	1 DID 22986	1 DID 21891	0	1 DID 21892	2 ^{**} DID 21890	NO	
115	30" SINK	1/0" DID 21894	N/A	N/A	N/A	1 DID 21902	0	0	2 ^{**} DID 21890	NO	

^{*} DOOR NOT REQUIRED WHERE CUSTOMER VIEW IS LIMITED OR NEGLIGIBLE (i.e. FRONTLINE OR BEHIND WALLS)

^{**} SIDE PANEL QUANTITY SHOWN IS FOR STAND-ALONE CABINETS; ACUTAL SIDE PANEL QUANTITY IS DEPENDENT ON ADJACENT CABINET TYPE AS SIDE PANELS CAN BE SHARED.

^A BOTTOM SHELF AND BOX BASE (IF APPLICABLE), SHOULD BE REMOVED AT SINK/ICE BIN CABINETS WITH FLOOR SINK LOCATED..


^{AA} BOX BASE TO BE PROVIDED AT SPECIFIC CABINETS WHEN REQUIRED BY JURISDICTIONAL CODE OR LOCAL OPERATOR PREFERENCE (NOTED AS "YES")

KEYED NOTES


- NITRO EQUIPMENT LOCATION.
- FOOD CASE.
- FILLER FINISH PANEL TO BE SHIPPED LONGER THAN DIMENSIONED AND CUT TO FIT IN FIELD.
- CASEWORK SUPPLIER TO PROVIDE ADDITIONAL BACKER SUBSTRATE TO ALIGN END CAP PANEL TO ADJACENT DOOR FACES.
- FOOD WARMING WALL STATION.
- PASTRY TRAY LOCATION.

GENERAL NOTES

- SEE SHEET I102 FOR COMPLETE CASEWORK SCHEDULE.
- ALL DIMENSIONS ARE TO CENTER OF FRAME ASSEMBLY.
- CABINET PANELS:
 - > ALL CABINET SHELVEING TO BE SECURED TO METAL COMPONENTS WITH #8 ROUND HEAD SCREWS.
 - > ALL METAL COMPONENTS SHALL BE SECURED TO FRAME ASSEMBLY AT KEY HOLE LOCATIONS.
 - > BOTTOM FLASHING SECURED TO HOPE WITH SILICONE.
- SUBSTRATE PANELS:
 - > SUBSTRATE PANELS SHALL BE MOISTURE RESISTANT (MR) PLYWOOD, MDF OR HDF.
 - > CASEWORK VENDOR SHALL PROVIDE ALL SUB PANELS TO BE CUT TO SIZE PRIOR TO SHIPPING.
 - > CASEWORK VENDOR SHALL APPLY Z-CLIPS TO FINISH PANELS PRIOR TO SHIPPING.
 - > FRONTLINE PANELS TO BE SECURED TO SUBSTRATE VIA Z-CLIP APPLICATION.
 - > PANEL INSTALLATION TO START AT OUTSIDE CORNER LOCATIONS.
 - > END PANELS TO BE SCRIBED ON SITE.
 - > ALL PANEL CUT-OUTS SHALL BE FINISHED ALL AROUND.
 - > Z-CLIPS TO BE INSTALLED 1" AWAY FROM PANEL EDGE.

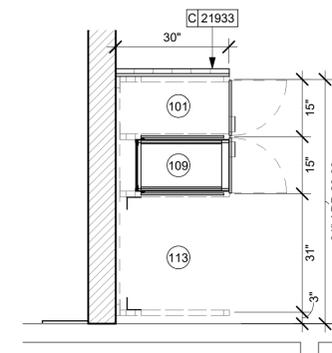

02 A. CASEWORK CABINET PLAN PARTNER'S
Scale: 1/2" = 1'-0"

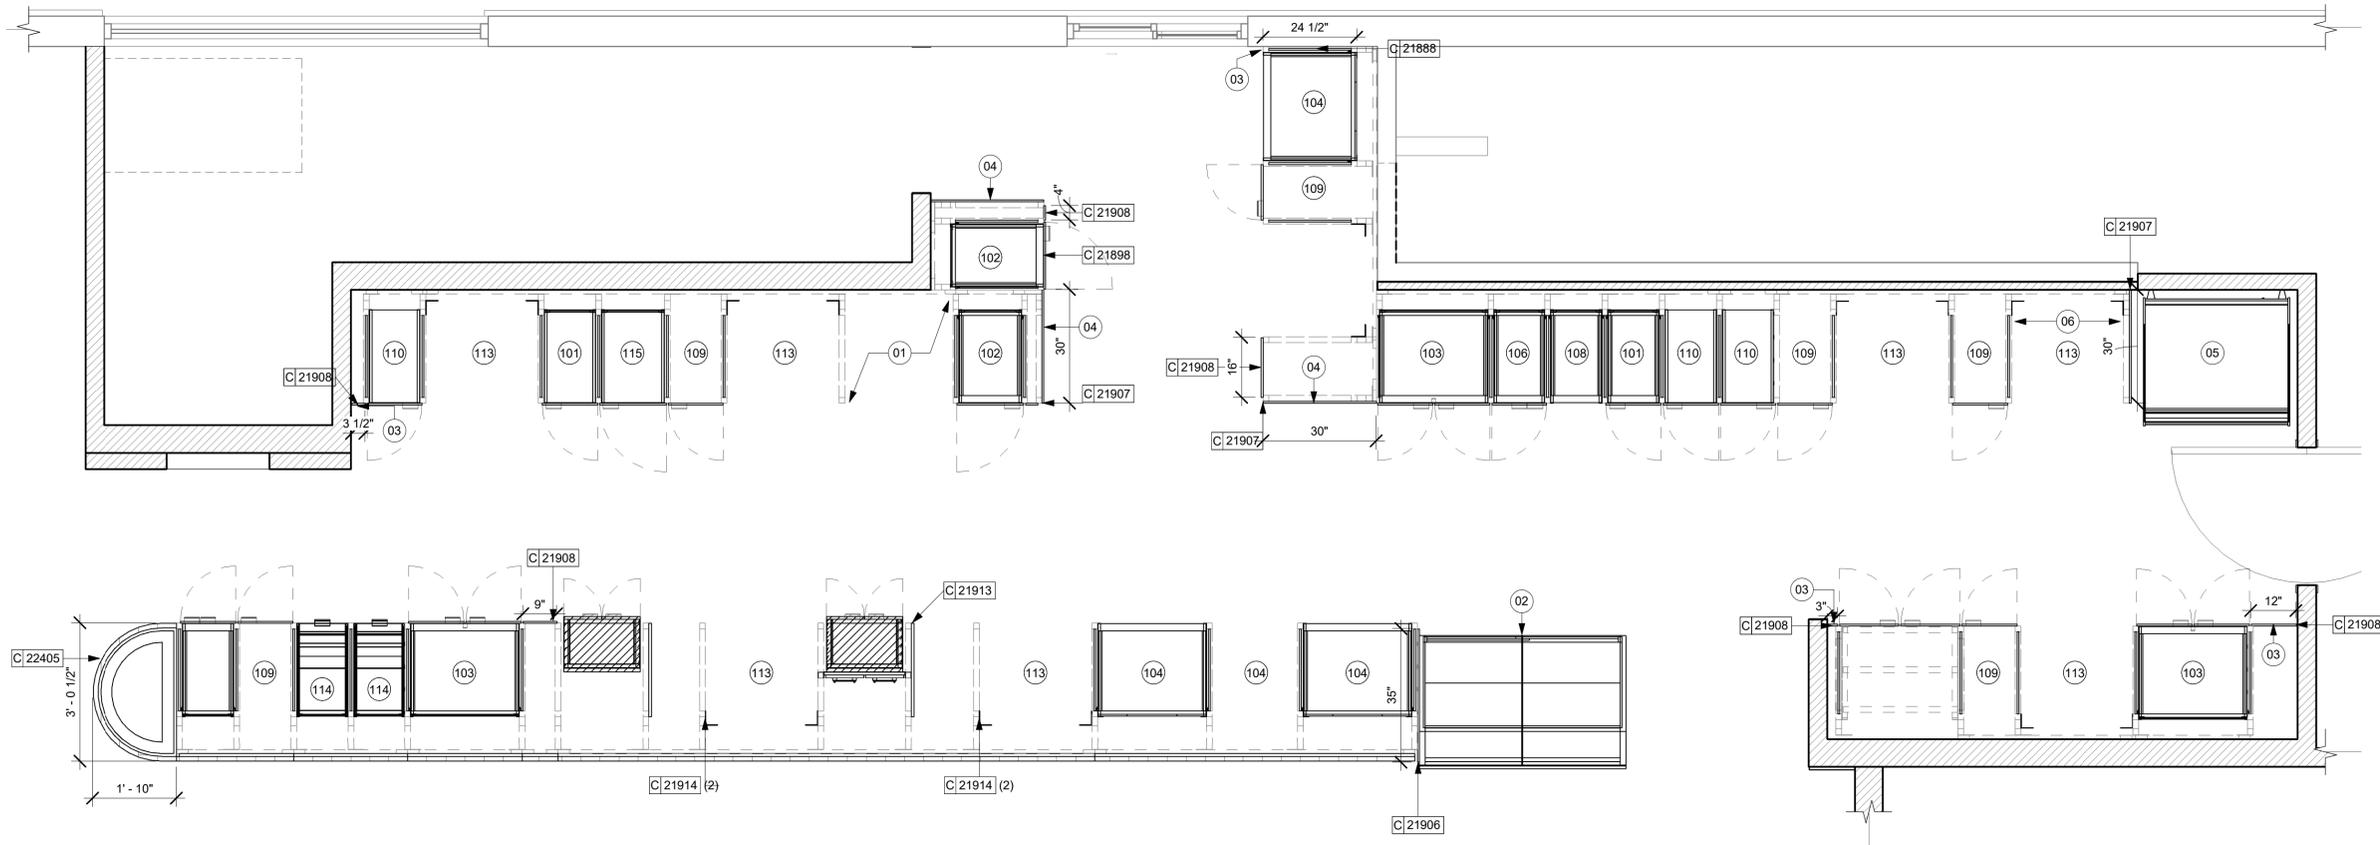

01 ADAPTABLE CASEWORK CABINET PLAN
Scale: 1/2" = 1'-0"

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PROJECT NAME:
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PROJECT ADDRESS:
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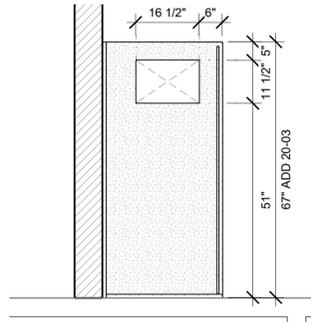
STORE #: 8565
PROJECT #: 18756-108
ISSUE DATE: 03-27-2024
DESIGN MANAGER: ROMINA VIGNOLO
PRODUCTION DESIGNER: GENSLER
CHECKED BY: GENSLER

Revision Schedule			
Rev	Date	By	Description

SHEET TITLE:
**ADAPTABLE CASEWORK
CABINET PLAN**
SCALE: AS SHOWN

SHEET NUMBER:
1102.3

ADAPTABLE CASEWORK COUNTERTOP SCHEDULE - "C"					
DESIGN ID	COUNT	DESCRIPTION	FURN. BY	INST. BY	COMMENTS
COUNTERTOP					
21918	1	COUNTERTOP - FILLER FRONTBAR - VARIABLE LENGTH	SB	GC	
21919	6	COUNTERTOP - FILLER BACKBAR - VARIABLE LENGTH	SB	GC	
21922	2	COUNTERTOP - FRONTBAR - 30IN 760MM	SB	GC	
21923	1	COUNTERTOP - END CAP FRONTBAR	SB	GC	
21926	2	COUNTERTOP - BACKBAR - 18IN 455MM	SB	GC	
21927	1	COUNTERTOP - BACKBAR - 30IN 760MM	SB	GC	
21928	4	COUNTERTOP - END CAP BACKBAR	SB	GC	
22328	1	COUNTERTOP - BREW - LF - 90IN 2285MM	SB	GC	
22352	1	COUNTERTOP - ESPRESSO FRONTBAR - LF - 141IN 3580MM	SB	GC	
22354	1	COUNTERTOP - ESPRESSO SHROUD - 141IN 3580MM	SB	GC	
22361	1	COUNTERTOP - POS - 84IN 2135MM	SB	GC	
22362	1	COUNTERTOP - DT POS - LF - 76IN 1930MM	SB	GC	
22377	1	COUNTERTOP - WARMING - RF - 92IN 2335MM	SB	GC	
22388	1	COUNTERTOP - CONSOLIDATED HANDOFF - 30IN 760MM	SB	GC	
22394	10	COUNTERTOP - BACKSPLASH - VARIABLE LENGTH	SB	GC	
22395	2	COUNTERTOP - HAND SINK LOW SPLASH - 15IN 380MM	SB	GC	
22404	1	COUNTERTOP - END CAP FRONTBAR ROUNDED	SB	GC	
23151	1	COUNTERTOP - PARTNER AMENITY - 67IN 1700MM	SB	GC	
23403	1	COUNTERTOP - CBE IN-LINE RF - 139IN 3530MM	SB	GC	
23430	1	COUNTERTOP - WRM RF - 78IN 1980MM	SB	GC	



02 A. CASEWORK COUNTERTOP PLAN PARTNER'S
Scale: 1/2" = 1'-0"

KEYED NOTES

- 01 LOCATE WATER TROUGH AT EDGE OF COUNTERTOP AS SHOWN.
- 02 RAISED EDGE GROMMETS.
- 03 CORIAN SHROUD AT ESPRESSO BAR.
- 04 CUT OUT FOR RECESSED SINK, ICE BIN OR TRASH DROP. SEE EQUIPMENT AND/OR MANUFACTURER'S CUTSHEETS FOR DIMENSIONS.
- 05 FOOD CASE.
- 06 OVERHANG EDGE 4IN.
- 07 BACKBAR W/ 8IN INTEGRAL BACKSPLASH.

GENERAL NOTES

- A. SEE SHEET I102 FOR COMPLETE CASEWORK SCHEDULE.
- B. G.C.'S INSTALLER SHALL VERIFY COUNTER CHANNEL REQUIREMENTS PRIOR TO CUTTING IN FIELD.
- C. G.C./INSTALLER TO VERIFY COUNTERTOP SUPPORT CHANNEL MEASUREMENTS PRIOR TO CUTTING. FIELD CUT AT SINKS AND ICE BINS.
- D. "C" CHANNEL MOUNTS OVER FRONT AND REAR INDEX BRACKETS WHICH ARE INSERTED INTO FRAMEWORK.
- E. SILICONE SEAM AT TRANSITION FROM COUNTERTOP TO HAND SINKS.
- F. SILICONE AND SEAL ALL SEAMS BETWEEN SINKS, EQUIPMENT AND COUNTERTOPS.
- G. ONCE COUNTERTOP IS SET, LEVELED AND SEAMED, SECURE CHANNEL TO UNDERSIDE OF SUBSTRATE.

LEGEND

- INDICATES STAINLESS STEEL (SST) COUNTERTOP
- INDICATES SOLID SURFACE (SS) COUNTERTOP
- DATUM POINT

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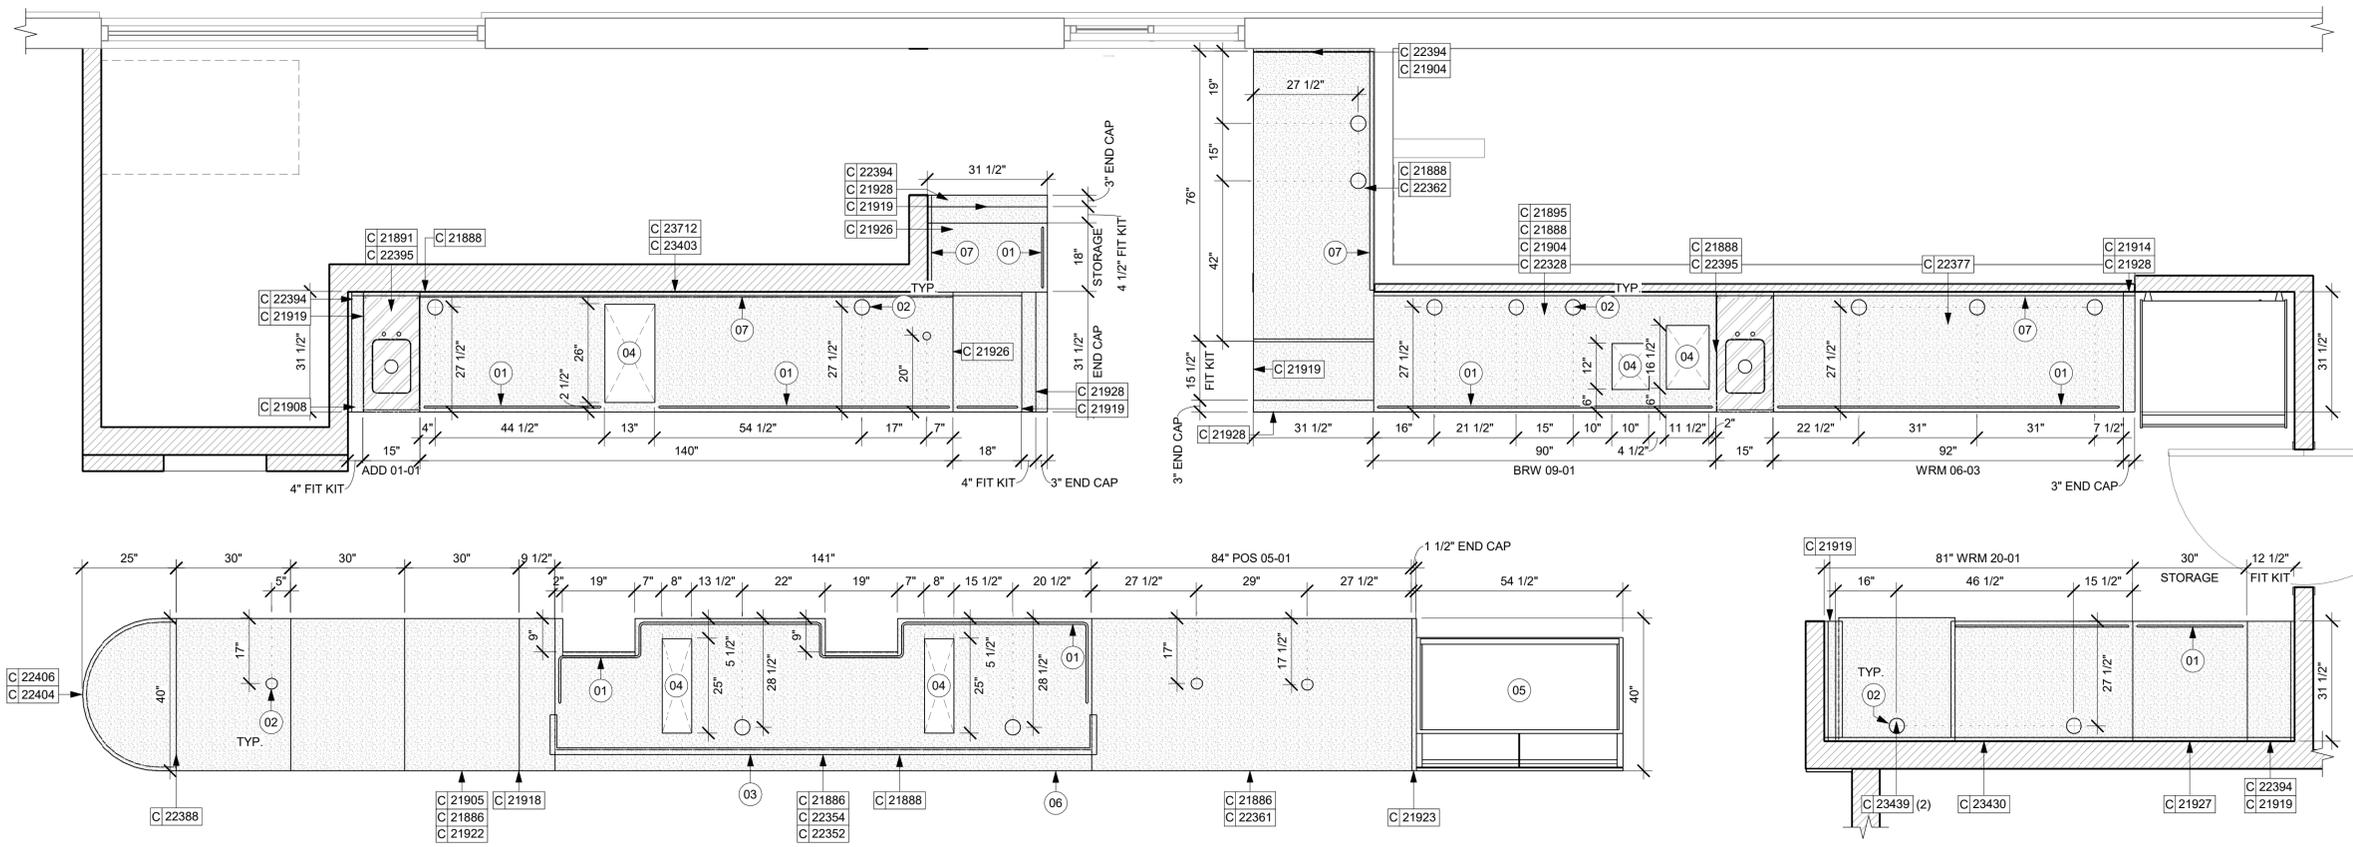
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32250**

STORE #: 8565
PROJECT #: 18756-108
ISSUE DATE: 03-27-2024
DESIGN MANAGER: ROMINA VIGNOLO
PRODUCTION DESIGNER: GENSLER
CHECKED BY: GENSLER

Revision Schedule			
Rev	Date	By	Description

SHEET TITLE:
**ADAPTABLE CASEWORK
COUNTERTOP PLAN**
SCALE: AS SHOWN

SHEET NUMBER:
1102.4



01 ADAPTABLE CASEWORK COUNTERTOP PLAN
Scale: 1/2" = 1'-0"



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STORE #: 8565
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ISSUE DATE: 03-27-2024
DESIGN MANAGER: ROMINA VIGNOLO
PRODUCTION DESIGNER: GENSLER
CHECKED BY: GENSLER

Revision Schedule			
Rev	Date	By	Description

SHEET TITLE:
**DIMENS. REFLECTED
CEILING PLAN**
SCALE: AS SHOWN

SHEET NUMBER:
1103.1

PERMIT SET - FOR CONSTRUCTION USE

KEYED NOTES

- 01 STARTING POINT FOR CEILING TILE GRID INSTALLATION. TYPE AND FINISH AS SCHEDULED.
- 02 CENTER EMERGENCY FIXTURE. REFER TO INTERIOR ELEVATIONS FOR MOUNTING HEIGHTS AND ELECTRICAL SHEETS FOR ADDITIONAL INFORMATION. GC TO VERIFY FINAL PLACEMENT WITH LOCAL FIRE MARSHALL PRIOR TO INSTALLATION.
- 03 TRACK HEADS TO BE CENTER WITH ARTWORK, CONDIMENT CART AND MERCH BAY AS SHOWN.

GENERAL NOTES

- A. REFERENCE LOW VOLTAGE PLAN SHEET AND ELECTRICAL DRAWINGS.
- B. IF REQUIRED BY LOCAL CODE, GENERAL CONTRACTOR TO PROVIDE SEMI-RECESSED SPRINKLER HEADS WITH POLISHED CHROME ESCUTCHEONS CENTERED IN ACOUSTICAL CEILING TILE. IF PENDANT HEADS ARE REQUIRED IN GWB SOFFIT OVER FRONT BAR, CONCEAL SUPPLY PIPING WITHIN SOFFIT. GENERAL CONTRACTOR TO SUBMIT SPRINKLER LAYOUT TO STARBUCKS' CONSTRUCTION MANAGER FOR APPROVAL PRIOR TO INSTALLATION.
- C. LEAVE TEN (10) ADDITIONAL RETAIL CEILING TILES TO MATCH RETAIL CEILING PAINT COLOR ABOVE THE WORKROOM CEILING AT MANAGER'S DESK FOR FUTURE USE.
- D. PROVIDE GROMMET AT ACOUSTIC CEILING PENETRATIONS FOR FIXTURES OF SUPPORTS.
- E. HEATING, VENTILATING AND AIR CONDITIONING SHOWN ON THIS PLAN PROVIDED FOR REFERENCE ONLY. SEE MECHANICAL DRAWINGS FOR ADDITIONAL INFORMATION.
- F. DIFFUSERS AND RETURNS IN ACOUSTICAL CEILING TILE TO BE CENTERED IN TILE AND PAINTED TO MATCH ADJACENT FINISHES (TYP.).
- G. PAINT ALL EXPOSED HVAC DUCTS, HVAC DIFFUSERS, LIGHT TRIM RINGS, PIPING, CONDUIT AND JUNCTION BOXES THE SAME COLOR AS SPECIFIED ON SURROUNDING CEILING OR SOFFIT UNLESS OTHERWISE NOTED. TYPICAL THROUGHOUT RETAIL AREA OF STORE.
- H. PAINT SUBSTITUTIONS ARE NOT ALLOWED. USE STARBUCKS' NATIONAL ACCOUNT "COLOR CODE" WHEN ORDERING PAINTS.
- I. DATA CABLING ABOVE HEAD SHALL BE IN PLENUM WHEN AVAILABLE.
- J. DATA CABLING AT EXPOSED CEILING SHALL BE INSTALLED IN METAL CONDUIT OR PER LOCAL CODE REQUIREMENT.

LIGHTING LEGEND


- CUSTOM CAN - LED ADJUSTABLE RECESSED - 3IN 75MM - BLACK - 1155LM FLOOD WITH DIMMER [L X0601]
- TRACK - LED FIXTURE WITH SNOOT - 3IN 75MM - BLACK - 1100LM FLOOD [L 21779]
- STRIP - LED TAPE IN HOUSING - VARIABLE LENGTH - BLACK - 350LM PER FT [L 22215]
- LIGHT DIRECTIONAL SYMBOL
NOTE: LEGEND IS DEPENDENT ON COLORS USED FOR COMPLETE SCOPE INFORMATION.
- EMERGENCY LIGHT [L 19057]

LEGEND

- EXISTING ITEM/EQUIPMENT FOR FUTURE
- EXISTING ITEM/EQUIPMENT TO BE REUSED
- EXISTING ITEM/EQUIPMENT TO REMAIN
- ADJACENT TENANT

NOTE: LEGEND IS DEPENDENT ON COLORS USED FOR COMPLETE SCOPE INFORMATION.

- ELEVATION DATUM
- TRACK LIGHTING
- STRIP LIGHTING
- PENDANT LIGHT
- RECESSED CAN LIGHT
- TROFFER
- EXIT SECURITY LIGHT
- EXIT SIGN/ EMERGENCY LIGHTING COMBO
- MUSIC SYSTEM WALL MOUNTED SPEAKER
- 360° SECURITY CAMERA
- SUPPLY AIR
- RETURN AIR
- EXHAUST FAN
- PIR MOTION SENSOR
- WALL MOUNTED SPEAKER
- WALL SCONCE AT RESTROOM
- WIFI ACCESS POINT (WAP)
- (E) 2'X2' ACT SUSPENDED CEILING SYSTEM
- (E) 2'X4' ACT SUSPENDED CEILING SYSTEM

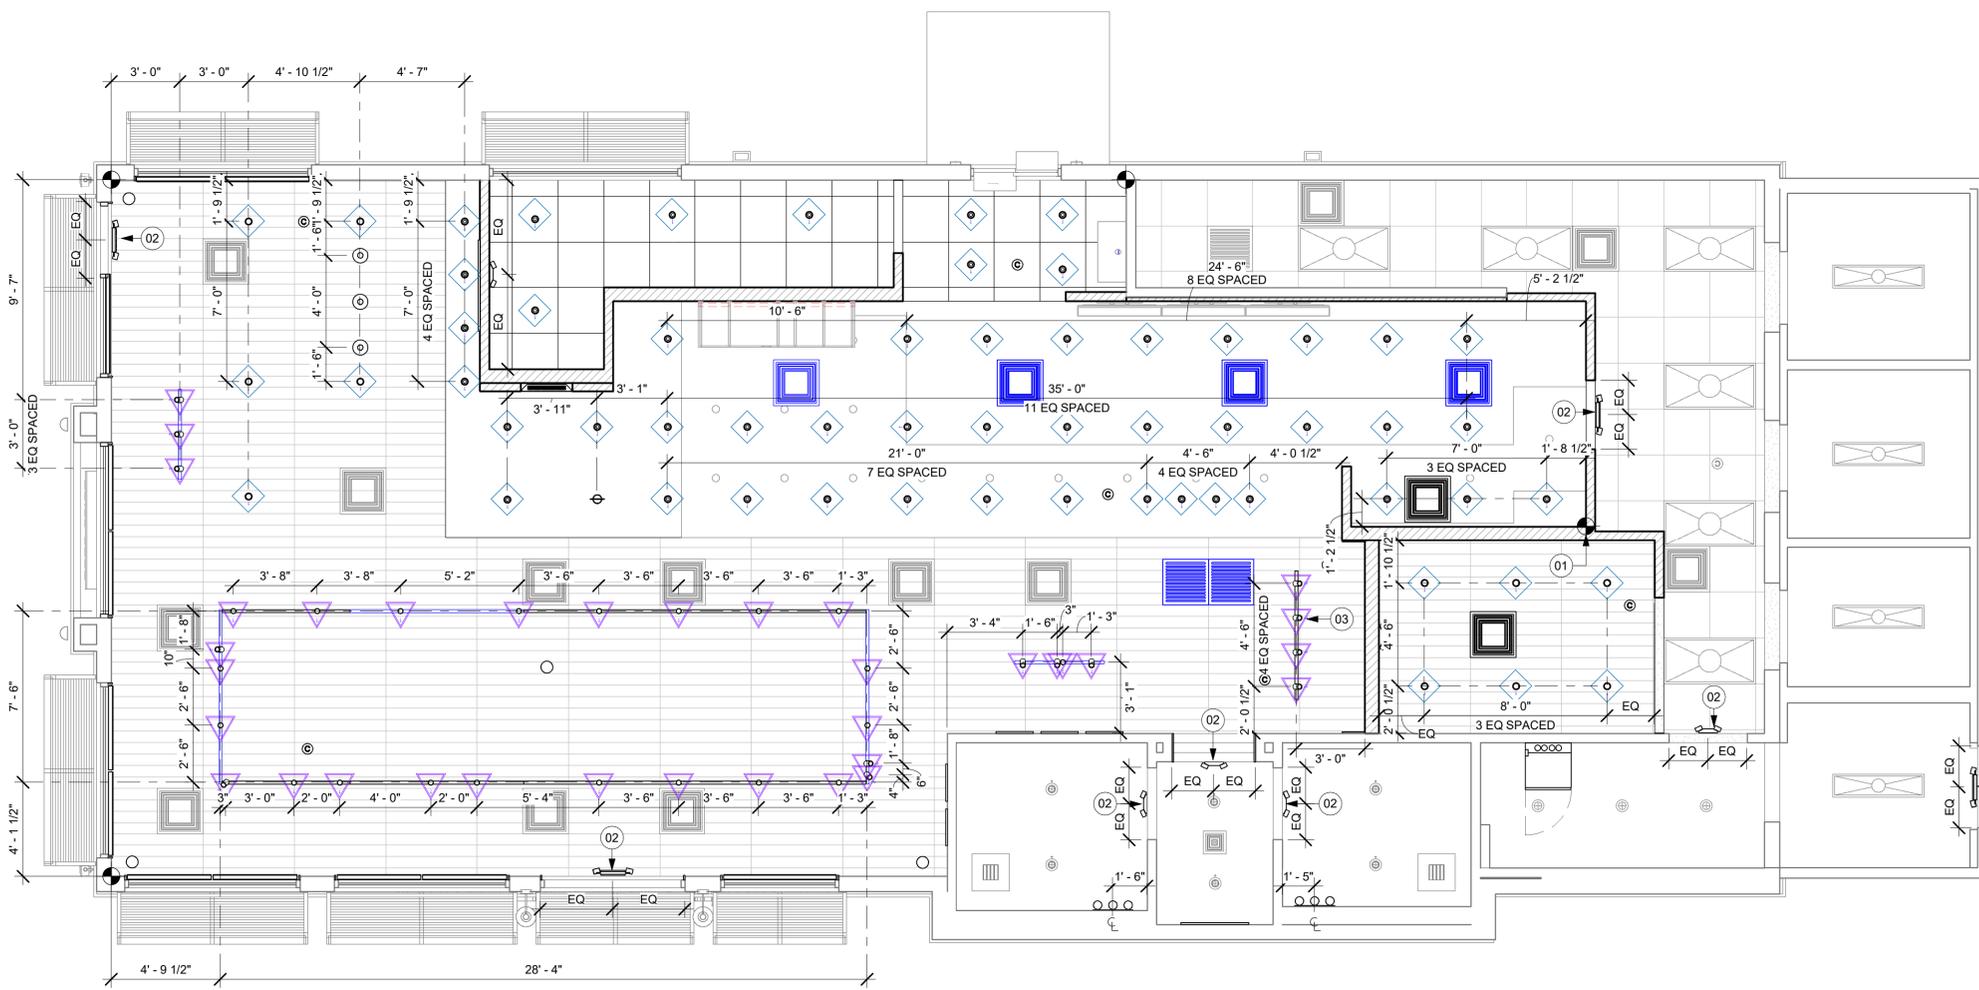

01 REFLECTED CEILING PLAN
Scale: 1/4" = 1'-0"





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PABLO GARCIA, AIA, REG. FL NO. AR99297

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PROJECT NAME:
A1A & 10TH

PROJECT ADDRESS:
**975 3RD STREET SOUTH
JACKSONVILLE BEACH, FL
32250**

STORE #: 8565
PROJECT #: 18756-108
ISSUE DATE: 03-27-2024
DESIGN MANAGER: ROMINA VIGNOLO
PRODUCTION DESIGNER: GENSLER
CHECKED BY: GENSLER

Revision Schedule			
Rev	Date	By	Description

SHEET TITLE:
**REFLECTED CEILING
PLAN REFERENCE**
SCALE: AS SHOWN

SHEET NUMBER:
1103.2

PERMIT SET - FOR CONSTRUCTION USE

LIGHTING LEGEND

- CUSTOM CAN - LED ADJUSTABLE RECESSED - 3IN 75MM - BLACK - 1155LM FLOOD WITH DIMMER [L] X0601
- TRACK - LED FIXTURE WITH SNOOT - 3IN 75MM - BLACK - 1100LM FLOOD [L] 21779
- STRIP - LED TAPE IN HOUSING - VARIABLE LENGTH - BLACK - 350LM PER FT [L] 22215
- LIGHT DIRECTIONAL SYMBOL NOTE: LEGEND IS DEPENDENT ON COLORS USED FOR COMPLETE SCOPE INFORMATION.
- EMERGENCY LIGHT [L] 19057

GENERAL NOTES


- A. REFERENCE LOW VOLTAGE PLAN SHEET AND ELECTRICAL DRAWINGS.
- B. IF REQUIRED BY LOCAL CODE, GENERAL CONTRACTOR TO PROVIDE SEMI-RECESSED SPRINKLER HEADS WITH POLISHED CHROME ESCUTCHEONS CENTERED IN ACOUSTICAL CEILING TILE. IF PENDANT HEADS ARE REQUIRED IN GWB SOFFIT OVER FRONT BAR, CONCEAL SUPPLY PIPING WITHIN SOFFIT. GENERAL CONTRACTOR TO SUBMIT SPRINKLER LAYOUT TO STARBUCKS' CONSTRUCTION MANAGER FOR APPROVAL PRIOR TO INSTALLATION.
- C. LEAVE TEN (10) ADDITIONAL RETAIL CEILING TILES TO MATCH RETAIL CEILING PAINT COLOR ABOVE THE WORKROOM CEILING AT MANAGER'S DESK FOR FUTURE USE.
- D. PROVIDE GROMMET AT ACOUSTIC CEILING PENETRATIONS FOR FIXTURES OF SUPPORTS.
- E. HEATING, VENTILATING AND AIR CONDITIONING SHOWN ON THIS PLAN PROVIDED FOR REFERENCE ONLY. SEE MECHANICAL DRAWINGS FOR ADDITIONAL INFORMATION.
- F. DIFFUSERS AND RETURNS IN ACOUSTICAL CEILING TILE TO BE CENTERED IN TILE AND PAINTED TO MATCH ADJACENT FINISHES (TYP.).
- G. PAINT ALL EXPOSED HVAC DUCTS, HVAC DIFFUSERS, LIGHT TRIM RINGS, PIPING, CONDUIT AND JUNCTION BOXES THE SAME COLOR AS SPECIFIED ON SURROUNDING CEILING OR SOFFIT UNLESS OTHERWISE NOTED. TYPICAL THROUGHOUT RETAIL AREA OF STORE.
- H. PAINT SUBSTITUTIONS ARE NOT ALLOWED. USE STARBUCKS' NATIONAL ACCOUNT "COLOR CODE" WHEN ORDERING PAINTS.
- I. DATA CABLING ABOVE HEAD SHALL BE IN PLENUM WHEN AVAILABLE.
- J. DATA CABLING AT EXPOSED CEILING SHALL BE INSTALLED IN METAL CONDUIT OR PER LOCAL CODE REQUIREMENT.

LEGEND

- EXISTING ITEM/EQUIPMENT FOR FUTURE
- EXISTING ITEM/EQUIPMENT TO BE REUSED
- EXISTING ITEM/EQUIPMENT TO REMAIN
- ADJACENT TENANT

NOTE: LEGEND IS DEPENDENT ON COLORS USED FOR COMPLETE SCOPE INFORMATION.

- ELEVATION DATUM
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- WIFI ACCESS POINT (WAP)
- (E) 2'X2' ACT SUSPENDED CEILING SYSTEM
- (E) 2'X4' ACT SUSPENDED CEILING SYSTEM

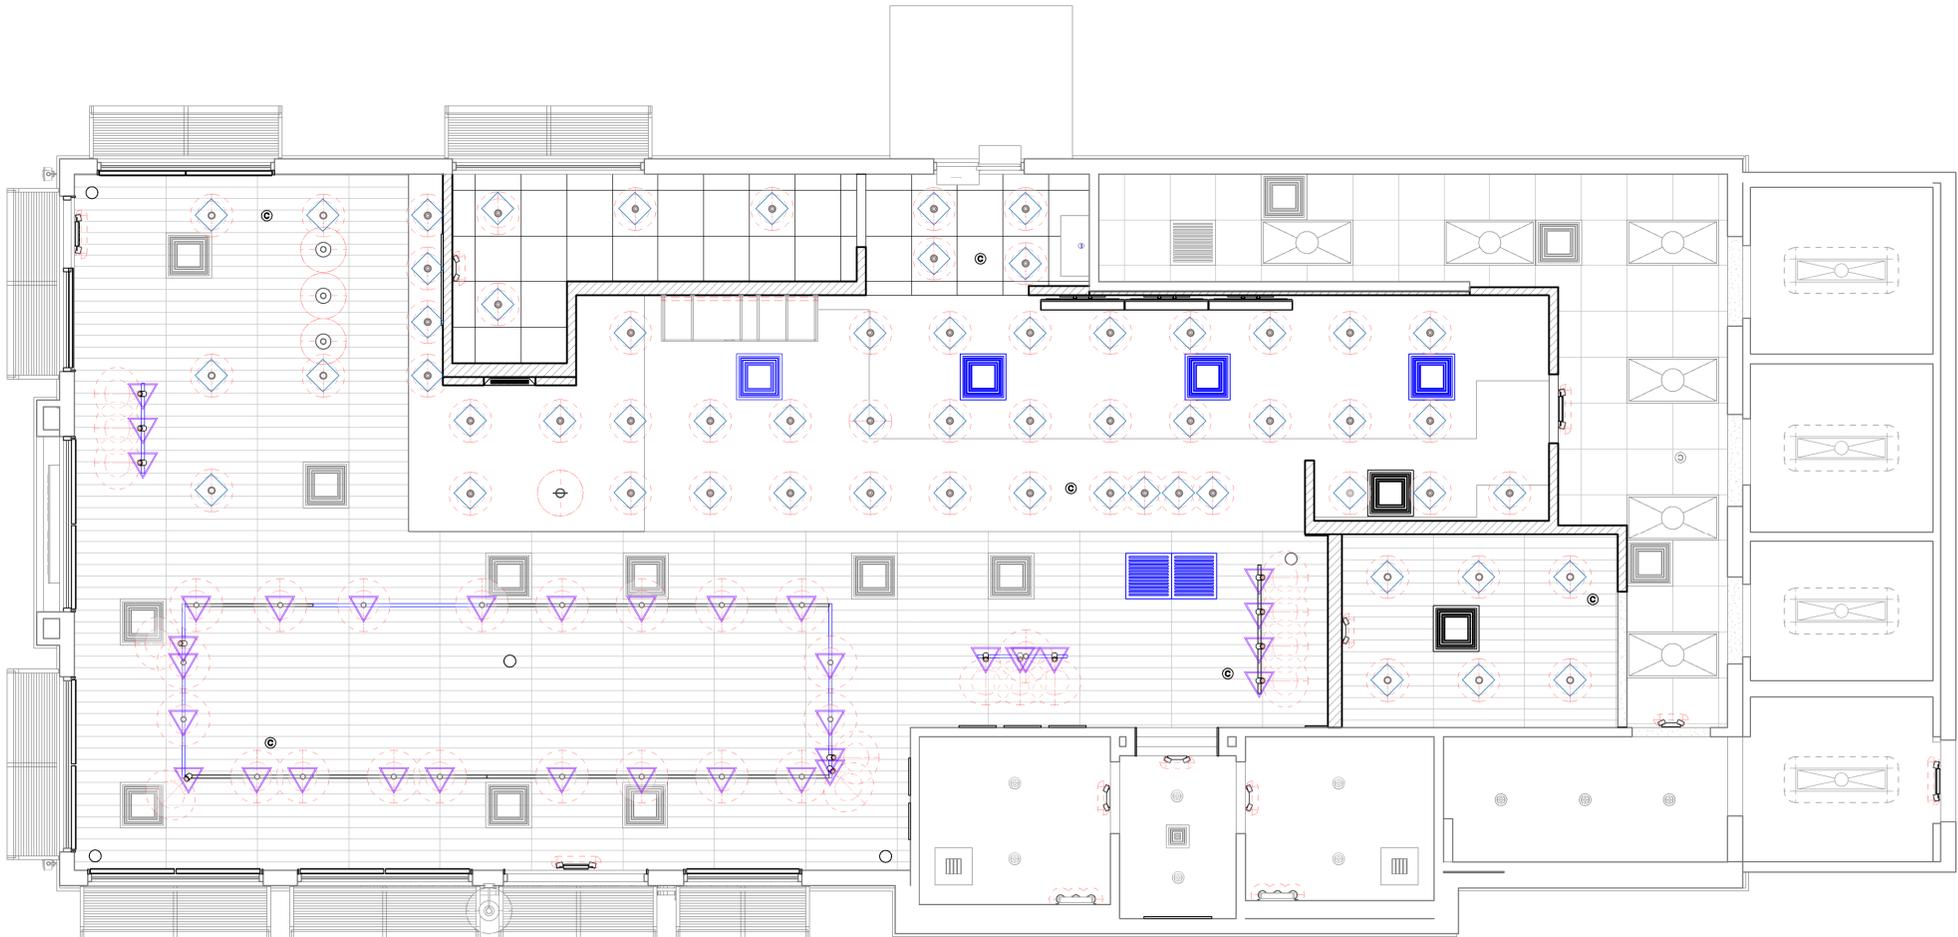

01 REFLECTED CEILING PLAN
Scale: 1/4" = 1'-0"

FLOOR TREATMENT SCHEDULE - "T"					
DESIGN ID	AREA	DESCRIPTION	FURN. BY	INST. BY	COMMENTS
PLASTIC					
19795	1282 SF	POLYVINYL FLOOR TILE - ECO-GRIP - PEWTER	SB	GC	GC TO PROCURE FROM ALLIED INDUSTRIES
TILE					
20228	1247 SF	TILE - I COCCI - CEMENTO - 24X24IN 600X600MM	SB	GC	GROUT: MAPEI - 47 CHARCOAL, OR EQUAL
WALK OFF MAT					
19288	36 SF	WALK OFF MAT - HELIX Z1 - BLACK - 12X9IN 305X230MM	SB	GC	

WALL BASE SCHEDULE - "B"					
DESIGN ID	LENGTH	DESCRIPTION	FURN. BY	INST. BY	COMMENTS
COVE BASE					
X1300	55' - 6 1/2"	SCHLUTER - DILEX - AHK 100 ATGB	GC	GC	W/ SANITARY 3/8IN COVE BASE MOLDING. FINISH: DARK ANTHRACITE
METAL BASE					
X1301	33' - 9 1/4"	METAL BASE - BLACK MT0028 - 6IN 150MM	GC	GC	W/ SANITARY 1/2IN COVE BEND 45-DEGREE. PROVIDED BY CASEWORK VENDOR.
TILE BASE					
18740	173' - 7 3/4"	TILE BASE - PLAZA NOVA - BLACK SHADOW - 6X12IN 150X300MM	SB	GC	W/ BULLNOSE SANITARY 3/8IN COVE BASE MOLDING. GROUT: MAPEI - 10 BLACK, OR EQUAL.
19795	321' - 5 1/2"	POLYVINYL FLOOR TILE - ECOGRIP - PEWTER	GC	GC	
TRANSITION BASE					
X1301	25' - 0"	TAPERED ALUMINIUM FRAME - 16 GA	GC	GC	FINISH: TEXTURED COLOR-COATED BLACK (DID: MT0028).

KEYED NOTES

- PROPOSED LOCATION OF CASEWORK DIEWALL. GC TO COORDINATE WITH CASEWORK VENDOR FOR LOCATION ON SITE.
- OUTLINE OF ENGINE FOR REFERENCE.
- OUTLINE OF BANQUETTE SEATING FOR REFERENCE.
- RECESSED WALK-OFF MAT AT ENTRY. CUT OUT CONCRETE AS REQUIRED PER MANUFACTURER'S SPECIFICATIONS. SEE INTERIOR DETAIL SHEETS FOR TRANSITION.
- DUPLEX FLOOR OUTLET. COORDINATE FLOOR RECEPTACLE.
- TILE START POINT WHERE INDICATED IN PLAN.
- MOP SINK LOCATION. DO NOT CONTINUE WALL BASE IN FRONT OF MOP SINK. SEE PLUMBING PLANS FOR MORE INFORMATION.
- INSTALL TILE FLOORING AT CAFE, RESTROOM VESTIBULE, RESTROOMS AND PARTNER'S AREA AS INDICATED IN PLAN.
- INSTALL CUSTOM METAL ALUMINIUM TRIM AROUND WALK-OFF MAT AS INDICATED IN PLAN AND DETAIL.
- INSTALL POLYVINYL FLOORING AND BASE AT BACKBAR, AND WORKROOM.
- POLYVINYL START POINT WHERE INDICATED.
- INSTALL TILE BASE AT CAFE, RESTROOM VESTIBULE AND PARTNER'S AREA AS INDICATED IN PLAN.
- INSTALL SCHLUTER BASE AT RESTROOMS AS INDICATED IN PLAN AND DETAIL.
- ECO-GRIP TO ALIGN WITH BASE CONCRETE AT FRONT COUNTER.

GENERAL NOTES

- WORKROOM TO BE FINISHED PER LOCAL CODE REQUIREMENTS.
- FLOORS, WALLS AND CEILING FINISHES IN FOOD PREPARATION AREAS SHALL BE SMOOTH, NON-TOXIC, NON-ABSORBENT, DURABLE AND EASILY CLEANABLE. PAINT SHALL BE WASHABLE, SEMI-GLOSS OR HIGH-GLOSS FINISH.
- STARBUCKS TO SUPPLY FLOORING AND BASE FOR FRONT AND BACK OF HOUSE AS NOTED IN SCHEDULES. GENERAL CONTRACTOR TO INSTALL. GENERAL CONTRACTOR TO SUPPLY WORKROOM TILE AND BASE AND INSTALL. GENERAL CONTRACTOR TO SUPPLY AND INSTALL MORTAR, ADHESIVE, AND GROUT. GENERAL CONTRACTOR TO INSPECT ALL TILES AND REJECT DAMAGED OR SUBSTANDARD TILES PRIOR TO INSTALLATION.
- ALIGN TILE TRANSITIONS ON WHOLE TILES AS SHOWN.
- ALL FLOOR AND WALL JUNCTIONS IN STORAGE AND FOOD PREPARATION AREAS SHALL HAVE A 6" COVED BASE.
- SEE BUILDING FLOOR PENETRATION PLAN ON SHEET A102 AND PLUMBING FOR ADDITIONAL INFORMATION.



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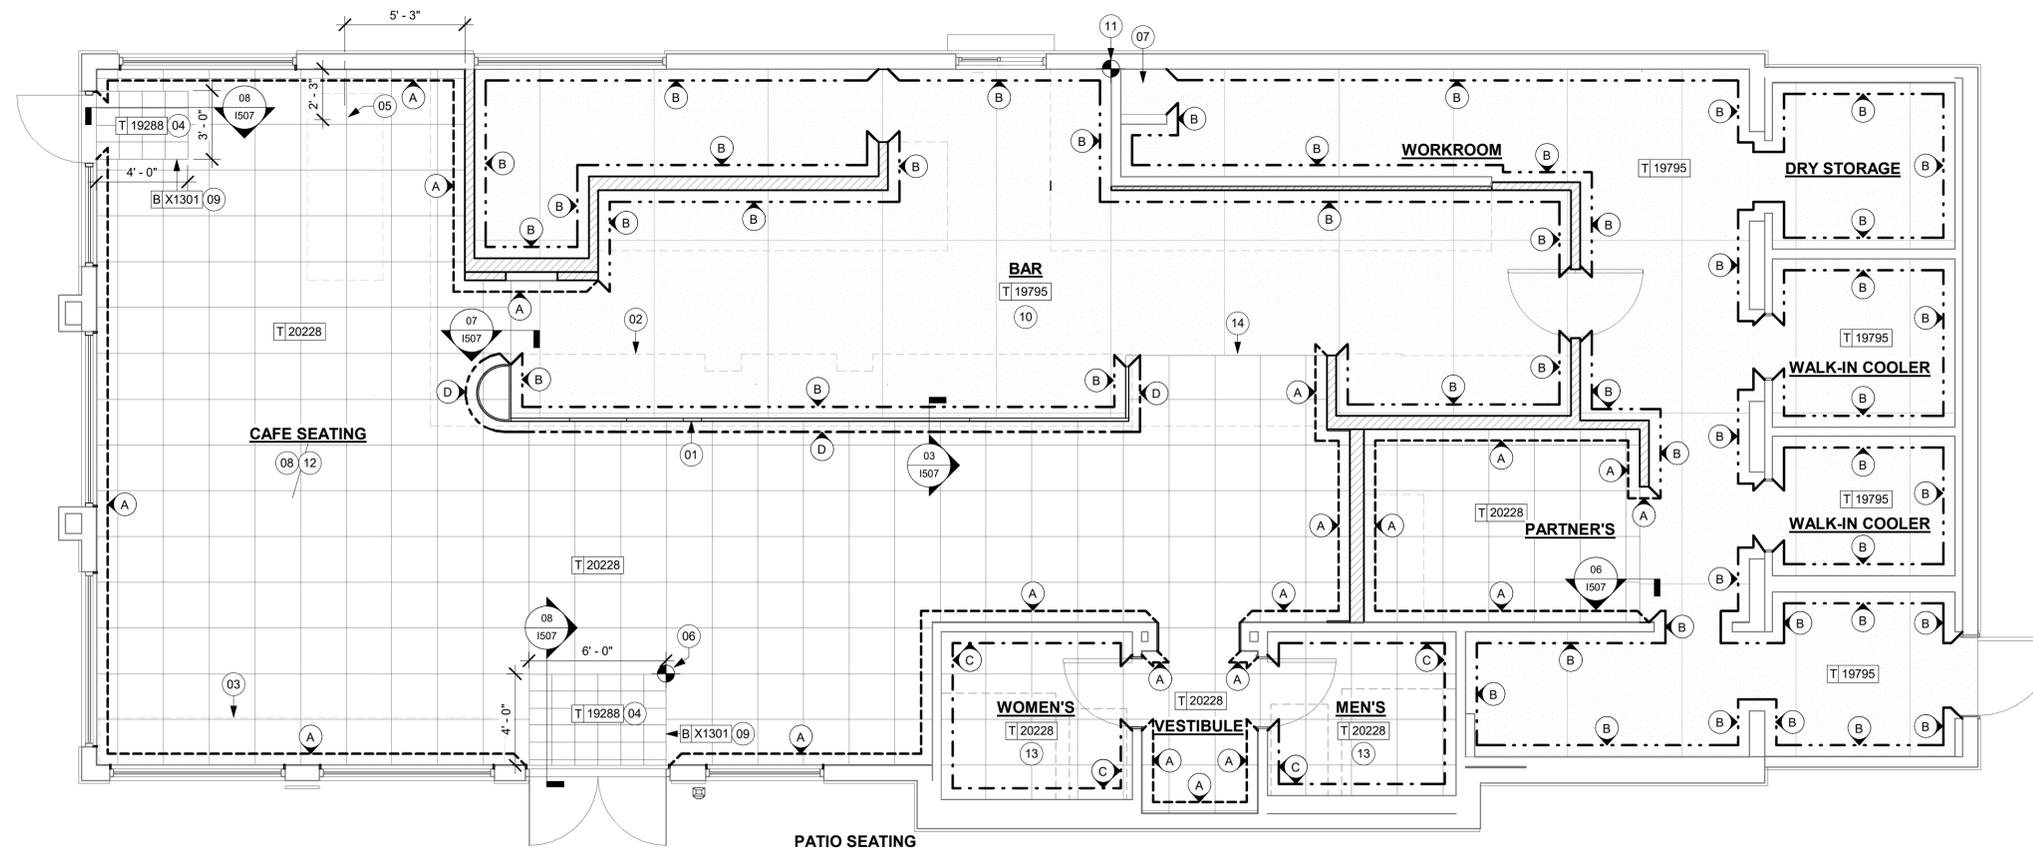
STORE #: 8565
PROJECT #: 18756-108
ISSUE DATE: 03-27-2024
DESIGN MANAGER: ROMINA VIGNOLO
PRODUCTION DESIGNER: GENSLER
CHECKED BY: GENSLER

Revision Schedule			
Rev	Date	By	Description

SHEET TITLE:
FLOOR FINISH PLAN

SCALE: AS SHOWN

SHEET NUMBER:
1104



LEGEND

- WALK OFF MAT - HELIX Z1 - BLACK - 12X9IN 305X230MM T19288
- POLYVINYL FLOOR - ECOGRIP - PEWTER - 60X96IN 1524X2438MM T19795
- TILE - I COCCI - CEMENTO - 24X24IN 600X600MM T20228
- TILE BASE - PLAZA NOVA - BLACK SHADOW - 6X12IN 150X300MM B18740
- POLYVINYL FLOOR - ECOGRIP - PEWTER - 60X96IN 1524X2438MM B19795
- SCHLUTER COVE BASE - DILEX - AHK B1300
- METAL BASE - POWERCOATED FLAT BLACK - MT0028 - 6IN 150MM B1301
- DATUM POINT
- FLOOR DRAIN
- FLOOR CLEAN-OUT
- FLOOR SINK
- CONSTRUCTION JOINT. REFER TO STRUCTURAL.



01 FLOOR FINISH PLAN

Scale: 1/4" = 1'-0"

PERMIT SET - FOR CONSTRUCTION USE

WALL TREATMENT (AREA) SCHEDULE - "Q"					
DESIGN ID	AREA	DESCRIPTION	FURN. BY	INST. BY	COMMENTS
23764	2960 SF	POLYWALL WALL COVERING - MATTE WHITE	GC	GC	
OTHER					
X1100	413 SF	GYP CEILING - GWB CEILING WITH LEVEL 4 FINISH - PAINT AS SCHEDULED	GC	GC	FINISH: REFER TO RCP PLAN AT I103 FOR TONE TAG; INSTALLATION SHALL BE IN STRICT ACCORDANCE W/ MANUFACTURER'S INSTRUCTIONS.
TILE					
12201	528 SF	TILE - HAMMERED WARM TAUPE - 13X13IN 330X330MM	SB	GC	GROUT GR0007; MAPEI - 47 CHARCOAL; LATICRETE - 35 MOCHA
X1400	689 SF	TILE - ALTAMIRA - VANILLA - GLOSSY	SB	GC	GROUT: MAPEI - 105 DRIFTWOOD, OR EQUAL
WALL COVERING					
20623	1396 SF	WALL COVERING - BURLAP - RETREAT	SB	GC	
WOOD					
X1401	251 SF	WOOD - WHITE OAK - PLANK - VERTICAL	SB	GC	CLASS A FIRE RETARDANT TREATMENT (PER ASTM E 94) OR PASSES NFPA 286 (DID: SPC006) SELECTED GRAIN, FULL PLANK. LENGTH REQUIRED (V.I.F.): (1) 10'-1" W X 9'-4" H

PAINT SCHEDULE					
DESIGN ID	DESCRIPTION	LRV	FURN. BY	INST. BY	COMMENTS
20444	SW7043 WORLDLY GRAY, OR EQUIVALENT	57	GC	GC	
20446	SW7045 INTELLECTUAL GRAY, OR EQUIVALENT	36	GC	GC	SW USE PRIMER CP-1; NCS - S 3005-Y20R; AKZO NOBEL - 40YY 44/095
20456	SW7631 CITY LOFT, OR EQUIVALENT	70	GC	GC	SW USE PRIMER CP-1; NCS - S 7502-Y; AKZO NOBEL - 30YY 10/038

WALL TREATMENT (LENGTH) SCHEDULE - "R"					
DESIGN ID	LENGTH	DESCRIPTION	FURN. BY	INST. BY	COMMENTS
CHAIR RAIL					
X0006	3' - 10"	CHAIR RAIL - 4IN 100MM - WALNUT WD0077	SB	GC	MOUNTED AT 36IN (915MM) AFF. PROVIDED BY CASEWORK VENDOR
X1500	19' - 10 1/2"	CHAIR RAIL	SB	GC	SEE CASEWORK FINISH SCHEDULE FOR MATERIAL. SUPPLIED BY CASWORK VENDOR
WAINSCOT					
X1501	19' - 10 1/2"	VINYL - WAINSCOT - BLACK STRIPE TEXTURE AT 36IN 915MM AFF	GC	GC	

KEYED NOTES

- REFER TO INTERIOR ELEVATIONS FOR PAINT COLORS AND TRANSITIONS.
- GC TO FURNISH AND INSTALL FRP BELOW ENGINE EXPOSED WALLS, EXCEPT AT WARMING WALL. EXTEND FROM WALL BASE TO UNDERSIDE OF COUNTERTOP. SEAL AT BASE. WALL TILE TO START ABOVE THE BACKSPLASH. REFER TO INTERIOR ELEVATIONS FOR ADDITIONAL INFORMATION AND START POINTS.
- OUTLINE OF ENGINE FOR REFERENCE.
- METAL MILLWORK TRANSITION. REFER TO I102.
- DECORATIVE METAL TRIM. REFER TO I102.
- INSTALL FULL HEIGHT FRP AT WORKROOM AND STORAGE WALLS AS INDICATED.
- GC TO INSTALL BACKBAR WALL TILE AS INDICATED ON INTERIOR FINISH ELEVATIONS.
- BACKBAR TILE TO RETURN TO MULLIONS WITHIN DRIVE-THRU WINDOW OPENING AS INDICATED.
- MOP SINK. FULL HEIGHT FRP AT ENCLOSURE (SEE PLUMBING PLANS FOR MORE INFORMATION).


GENERAL NOTES

- GC TO PATCH AND REPAIR ANY DAMAGE TO EXISTING WALLS TO A SMOOTH, PAINT READY SURFACE PRIOR TO PAINTING.
- CHANGE OF PAINT COLOR ALLOWED ONLY AT INSIDE CORNERS, UNLESS OTHERWISE NOTED.
- PAINT SUBSTITUTIONS ARE NOT ALLOWED. USE STARBUCKS NATIONAL SHERWIN-WILLIAMS ACCOUNT "COLOR CODE" WHEN ORDERING PAINTS.
- REFER TO INTERIOR ELEVATIONS FOR PAINT COLORS AND GRAPHICS' LOCATIONS.
- WALL AND CEILING COVERING MATERIALS SHALL BE ATTACHED SO THAT THEY ARE EASILY CLEANABLE.
- MATERIALS FOR INDOOR WALL SURFACES FOR CONDITIONS OF NORMAL USE SHALL BE SMOOTH, DURABLE, AND EASILY CLEANABLE.
- GC TO PROVIDE AND INSTALL WORKROOM WALL FINISHES PER LOCAL CODE REQUIREMENTS.
- FLOORS, WALLS AND CEILING FINISHES IN FOOD PREPARATION AREAS SHALL BE SMOOTH, NON-TOXIC, NON-ABSORBENT, DURABLE AND EASILY CLEANABLE.
- PAINT SHALL BE WASHABLE; SEMI-GLOSS OR HIGH-GLOSS FINISH.
- PAINT FINISHES SHALL BE APPLIED AS FOLLOWS, UNLESS NOTED OTHERWISE:
 - WOODS AND METAL SURFACES SHALL BE SEMI-GLOSS OR EQUAL.
 - ACCENT AND TRIM PAINTS TO BE SEMI-GLOSS OR EQUAL.
 - WALL AND CEILING PAINTS TO BE EGGSHELL OR EQUAL.
 - PAINTS IN BOH, RESTROOM(S) OR CAFE BAR SHALL BE SEMI-GLOSS OR EQUAL.
- ALL WOOD SURFACES (DOORS, TRIM, SHELVES, CABINETS) SHALL BE SEALED.
- REFER TO CASEWORK FINISH SCHEDULE FOR CASEWORK FINISH MATERIAL INFORMATION.
- REFER TO INTERIOR FINISH ELEVATIONS FOR ARTWORK/ GRAPHICS LOCATIONS. REFER TO MANUFACTURER'S INSTRUCTIONS INCLUDED WITH ARTWORK/GRAPHICS FOR PROPER INSTALLATION.
- ALL FLOOR AND WALL JUNCTIONS IN STORAGE AND FOOD PREPARATION AREAS SHALL HAVE 6" COVED BASE.
- INSTALL BLOCKING AND HANGERS FOR WALL SHELVING BEFORE INSTALLING BACK BAR TILE.
- CV SHOULD PROVIDE WOOD CLEAR SHERWIN WILLIAMS "CLASS A VARNISH SYSTEM" FLAMES SPREAD RETARDANT FOR ALL WOOD ITEMS OR "CLASS A" EQUIVALENT. APPLY PER MFR'S RECOMMENDATIONS ON ALL SIDES OF PANELS PRIOR TO SEALER. GC TO TEST PRIOR TO INSTALLATION.
- PROVIDE FIRE TREATED BLOCKING AS REQUIRED TO SUPPORT WALL ATTACHMENTS (SEE BUILDING FLOOR PLAN ON SHEET A-101 FOR MORE INFORMATION).
- REFER TO SHEET I-502 FOR WALL FINISH DETAILS.

LEGEND

- EXISTING WALL TO REMAIN
- NEW FULL HEIGHT WALL
- WOOD CLADDING TO CEILING
- WALL COVERING TO CEILING
- POLYWALL PANELING TO 2'-10" AFF WALL TILE TO CEILING
- WALL TILE TO CEILING
- POLYWALL PANELING
- WAINSCOT AT 2' - 10" AFF, 4IN WOOD CHAIR RAIL, PAINT TO CEILING
- PAINT TO CEILING
- INDICATES APPLY WALL FINISH ABOVE THE DOOR SILL AS INDICATED. REFER TO ELEVATIONS.

SEE INTERIOR FINISH ELEVATIONS FOR TAGGED LOCATION OF WALL FINISH MATERIAL

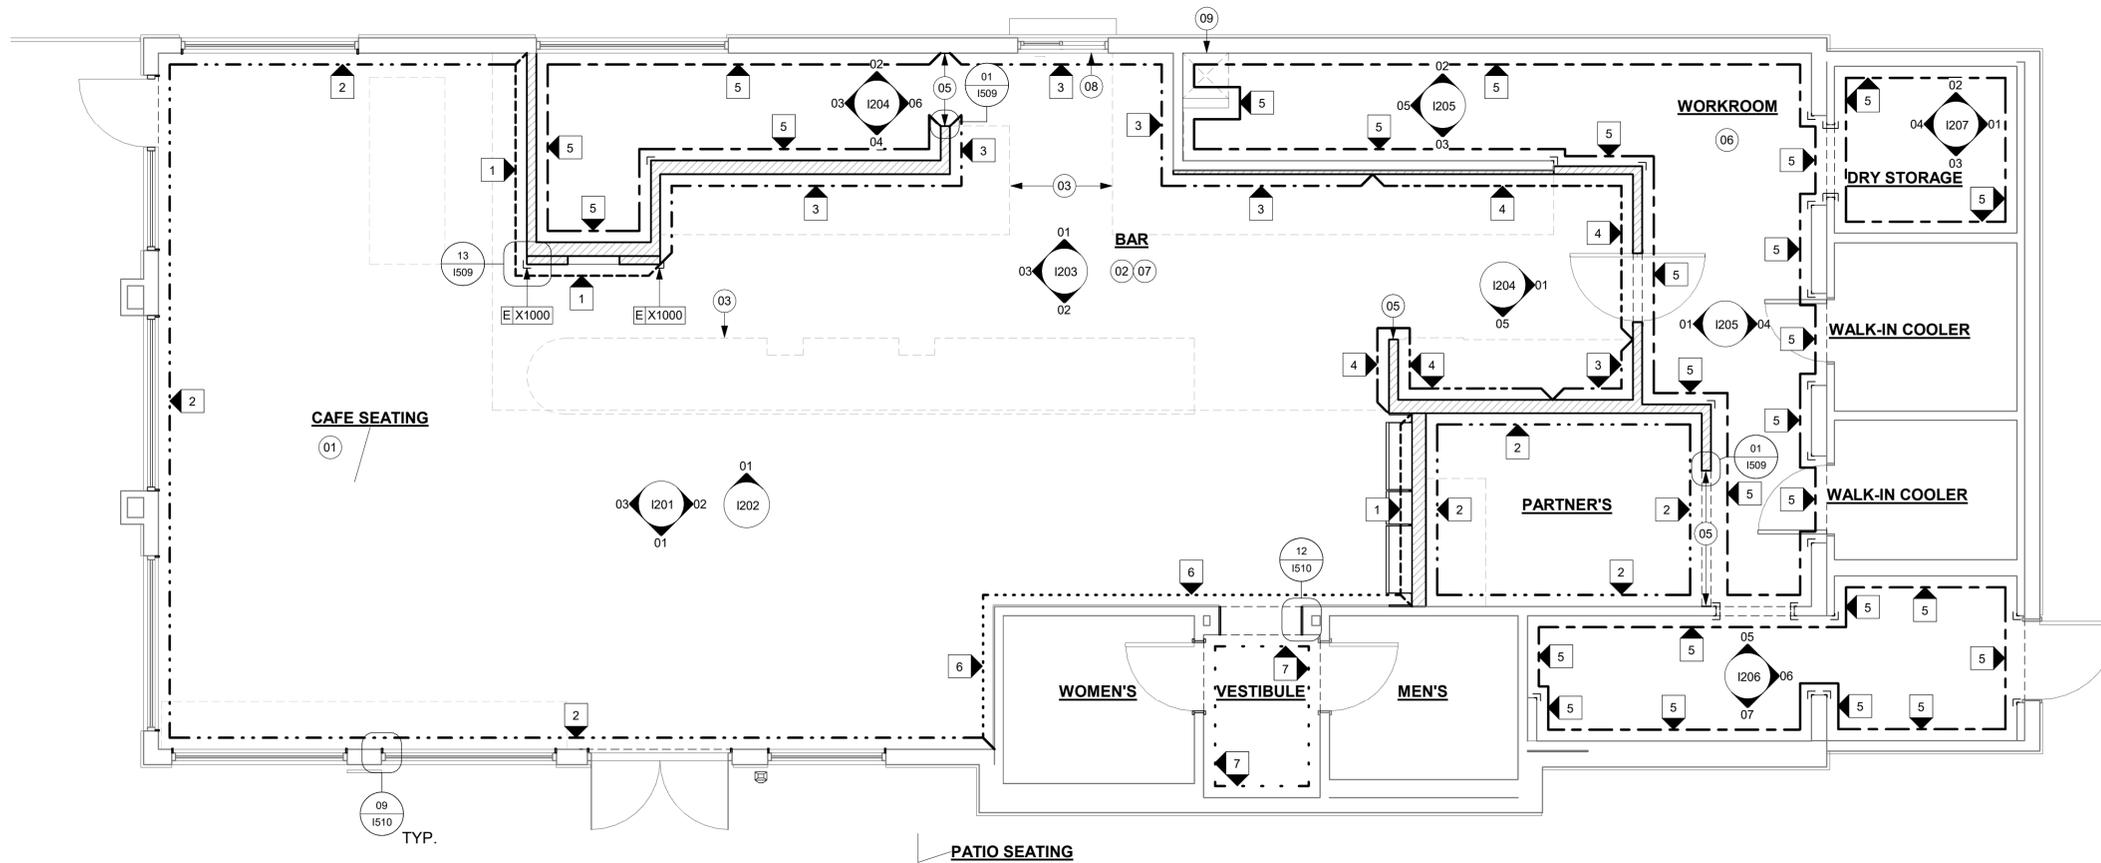

01 WALL FINISH PLAN
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STORE #: 8565
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DESIGN MANAGER: ROMINA VIGNOLO
PRODUCTION DESIGNER: GENSLER
CHECKED BY: GENSLER

Revision Schedule			
Rev	Date	By	Description

SHEET TITLE:
WALL FINISH PLAN

SCALE: AS SHOWN

SHEET NUMBER:
1105

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Revision Schedule			
Rev	Date	By	Description

SHEET TITLE:
**INTERIOR FINISH
ELEVATIONS**
SCALE: AS SHOWN

SHEET NUMBER:
1201

PERMIT SET - FOR CONSTRUCTION USE

KEYED NOTES


- LIGHT FIXTURE (SEE REFLECTED CEILING PLAN ON SHEET 1103 AND LIGHTING PLAN ON SHEET E102 FOR ADDITIONAL INFORMATION)
- EMERGENCY EXITLIGHT SIGNAGE COMBO, CEILING ATTACHMENT. REFER TO 1103 AND ELECTRICAL SHEETS FOR ADDITIONAL INFORMATION. GC TO VERIFY WITH LOCAL FIRE MARSHALL ON PLACEMENT AND QUANTITIES PRIOR TO INSTALLATION. GC TO ATTACH AN SUSPENSION KIT.
- ROLLER SHADE TO BE INSTALLED AS SHOWN.
- INSTALL CEILING MOUNTED SECURITY CAMERA AS INDICATED.
- ATTACH DIGITAL MENU BOARDS PER INSTALLATION DETAIL.
- CORIAN SHROUD.
- DO NOT BLOCK FOOD CASE INTAKE/EXHAUST.
- UNDERCOUNTER LED LIGHTING TO BE INSTALLED AT FRONT BAR AS INDICATED. REFER TO SCHEDULE FOR SPECIFICATIONS AND ELECTRICAL SHEETS FOR ADDITIONAL INFORMATION.
- WALL FINISH BEHIND EXPOSED CABINETRY AND BELOW UNDERSIDE OF COUNTERTOP SUBSTRATE TO BE FRP. EXCEPT WARMING WALL, TILE TO BE EXTEND FROM WALL BASE TO UNDERSIDE OF COUNTERTOP.
- PROVIDE 6" (150MM) MIN. INTEGRAL SPLASHGUARD AT HAND SINK PER JURISDICTIONAL REQUIREMENTS.
- HAND SINK WITH SOAP AND PAPER TOWEL DISPENSER. G.C. TO PROVIDE BLOCKING FOR FASTENERS.
- INSTALL PASTRY WALL-STORAGE FOR WARMING STATION AS SHOWN. G.C. TO PROVIDE WALL BLOCKING FOR FASTENERS.
- IN-WALL WOOD BLOCKING. VERIFY BLOCKING LOCATION, EXTENTS AND BLOCKING WITH MANUFACTURER'S REQUIREMENTS.
- ICE MACHINE (SEE PLUMBING AND ELECTRICAL DRAWINGS FOR ADDITIONAL INFORMATION).
- ICE DIVERTER.
- ICE MANAGER CONTROL PANEL.
- WATER FILTRATION EQUIPMENT. REFER TO PLUMBING DRAWINGS.
- WATER HEATER. REFER TO PLUMBING DRAWINGS.
- EXISTING WALL FINISHES TO REMAIN. GC TO CLEAN, PATCH AND REPAIR TO ACHIEVE LIKE-NEW CONDITION.
- INSTALL CORNER GUARD AT OUTSIDE CORNER AS INDICATED. REFER TO DETAIL.
- STARTING POINT FOR TILE INSTALLATION. WALL TILE GROUT LINES TO ALIGN AS INDICATED. EXCESS TILE TO BE CUT TO ALIGN.
- INSTALL SHELVING AS SHOWN. G.C. TO PROVIDE WALL BLOCKING FOR FASTENERS.
- BARRIER FREE NEW HARDWARE. REFER TO SHEET A602 FOR MORE INFORMATION. GC WILL BE RESPONSIBLE TO SPECIFY, REPAIR THE AREA, INSTALL IT, AND COORDINATE WITH LANDLORD.
- RECESSED ELECTRICAL PANELS (SEE ELECTRICAL DRAWINGS FOR ADDITIONAL INFORMATION).
- PLACE FIRE EXTINGUISHER PER LOCAL FIRE CODE REQUIREMENTS. COORDINATE TYPE AND SIZE WITH LOCAL INSPECTOR.

GENERAL NOTES

- FOR GRAPHICS SCHEDULE, REFER TO THE FURNITURE, FIXTURES, AND EQUIPMENT (FF & E) SCHEDULES ON SHEET 1601.
- REFER TO MANUFACTURER'S INSTRUCTIONS INCLUDED WITH ARTWORK/GRAPHICS FOR PROPER INSTALLATION.
- CHANGE PAINT COLOR ONLY AT INSIDE CORNERS UNLESS OTHERWISE INDICATED.
- PAINT FINISHES SHALL BE APPLIED AS FOLLOWS, UNLESS NOTED OTHERWISE:
 - WOODS AND METAL SURFACES SHALL BE SEMI-GLOSS OR EQUAL.
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 - WALL AND CEILING PAINTS TO BE EGGSHELL OR EQUAL.
 - PAINTS IN BOH, RESTROOM(S) OR CAFE BAR SHALL BE SEMI-GLOSS OR EQUAL.
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- FLOORS, WALLS AND CEILING FINISHES IN FOOD PREPARATION AREAS SHALL BE SMOOTH, NON-TOXIC, NON-ABSORBENT, DURABLE AND EASILY CLEANABLE. PAINT SHALL BE WASHABLE, SEMI-GLOSS OR HIGH GLOSS FINISH.
- ALL WOOD SURFACES (DOORS, TRIM, SHELVES, CABINETRY) SHALL BE SEALED.
- REFER TO CASEWORK FINISH SCHEDULE ON THE CASEWORK FINISH PLAN ON SHEET 1102 FOR CASEWORK FINISH MATERIAL INFORMATION.
- ALIGN TILE TRANSITIONS ON WHOLE TILES AS SHOWN.
- ALL FLOOR AND WALL JUNCTIONS IN STORAGE AND FOOD PREPARATION AREAS SHALL HAVE A 6" COVED BASE.
- ALL FOOD STORAGE SHALL BE 6" (150MM) A.F.F.
- INSTALL BLOCKING AND HANGERS FOR WALL SHELVING BEFORE INSTALLING BACK BAR TILE.
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- CLASS A FIRE RETARDANT TREATMENT (PER ASTM E 84), OR PASSES NFPA 286 (DID: SPC006), CASEWORK VENDOR TO PROVIDE WOOD CLEAR SHERWIN WILLIAMS "CLASS A VARNISHSYSTEM" FLAMES SPREAD RETARDANT OR SIMILAR, APPLY PER MFR'S RECOMMENDATIONS ON ALL SIDES OF PANELS PRIOR TO SEALER. GC TO TEST PRIOR TO INSTALLATION.


LEGEND

- INDICATES WALL BLOCKING. BLOCKING TO BE PROVIDED AS REQUIRED TO SUPPORT WALL ATTACHMENTS. EXTEND BLOCKING 4" (100mm) BEYOND EDGE OF ATTACHMENTS.
- WALL TILE START POINT DATUM

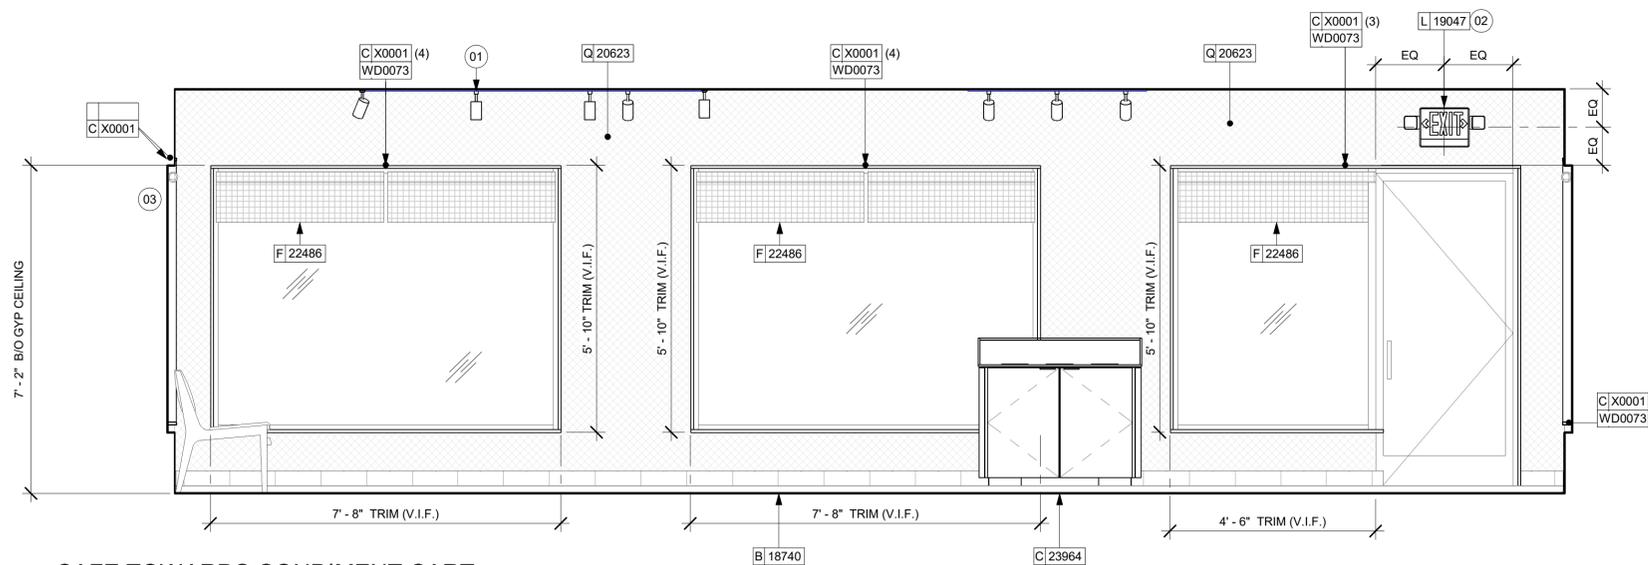


03 CAFE TOWARDS CONDIMENT CART

Scale: 1/2" = 1'-0"

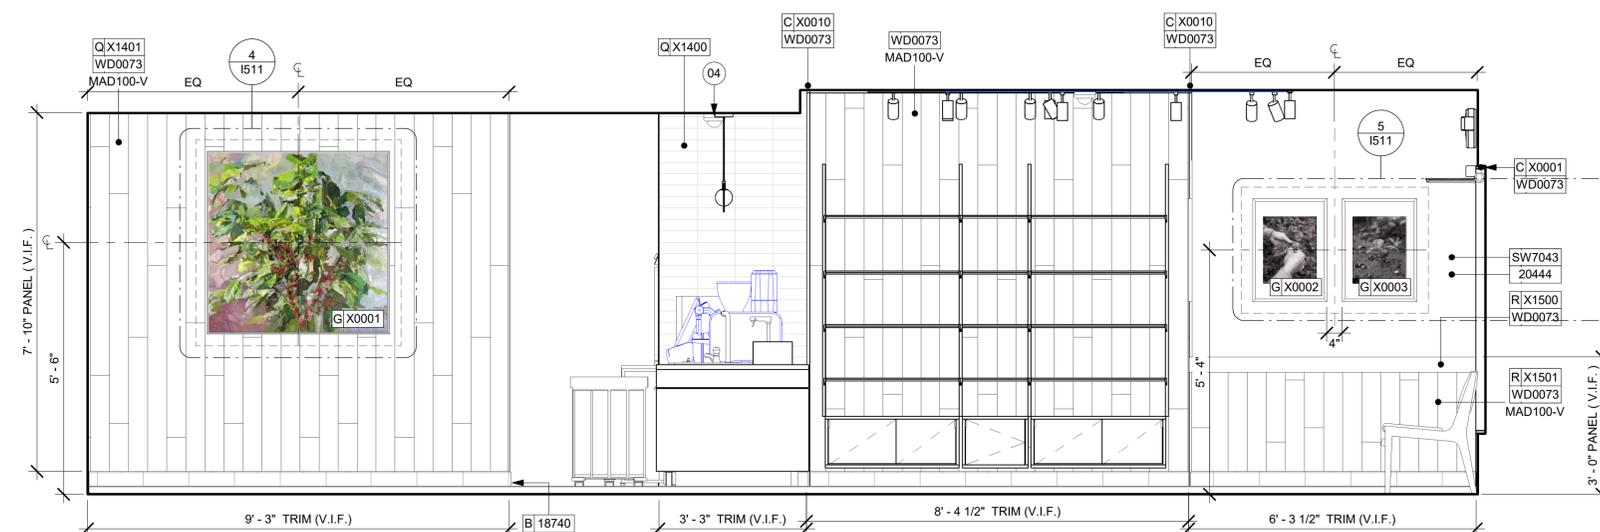

02 CAFE TOWARDS WOOD CLADDING

Scale: 1/2" = 1'-0"

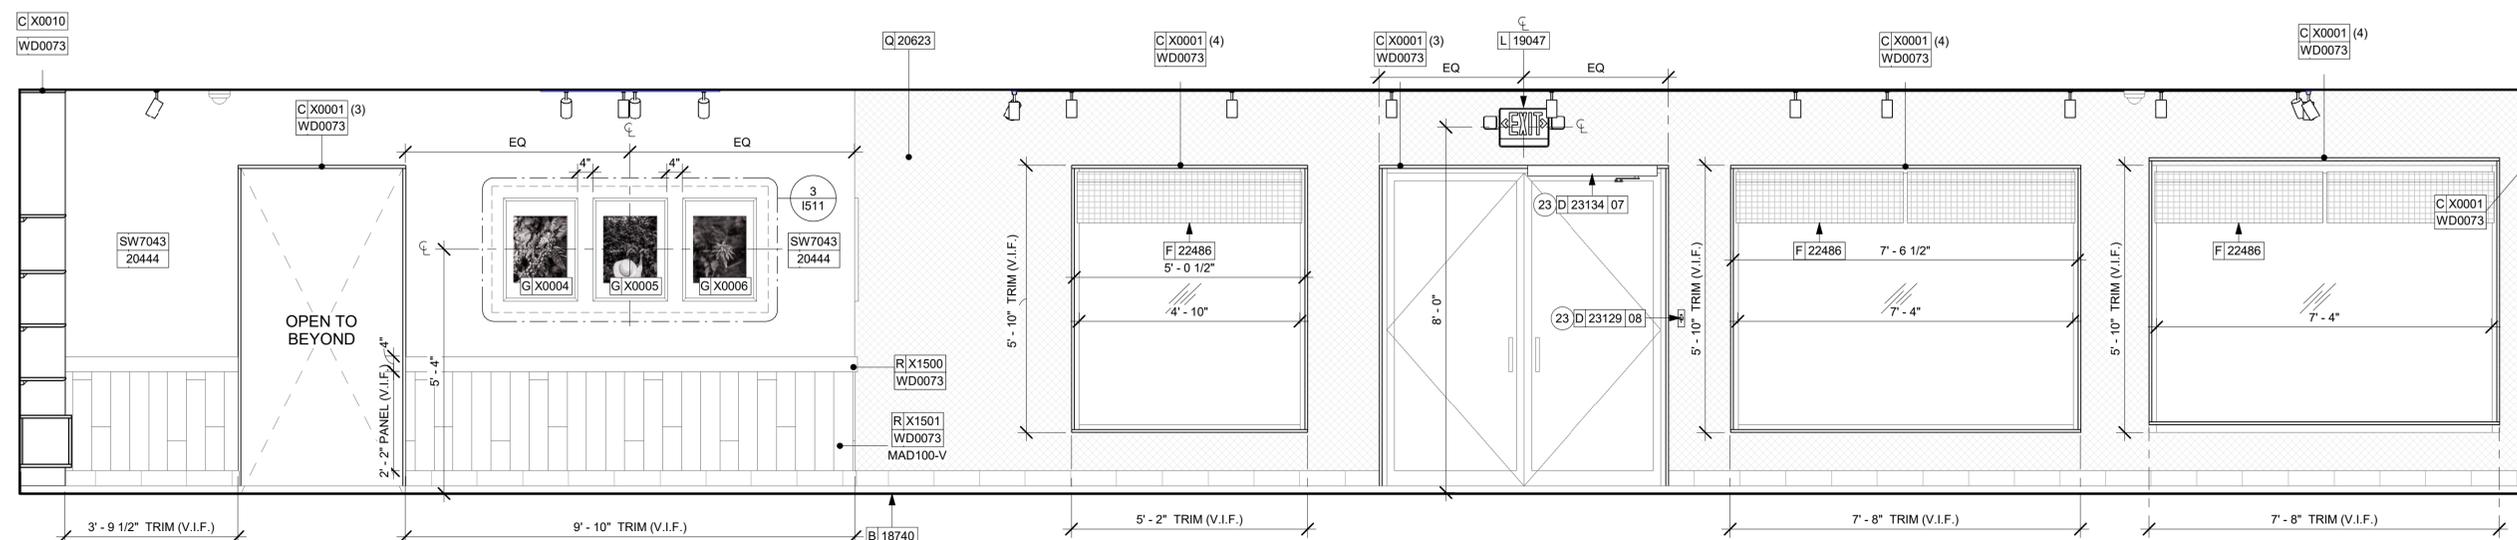

01 CAFE TOWARDS ENTRANCE

Scale: 1/2" = 1'-0"

KEYED NOTES


- 01 LIGHT FIXTURE (SEE REFLECTED CEILING PLAN ON SHEET 1103 AND LIGHTING PLAN ON SHEET E102 FOR ADDITIONAL INFORMATION)
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- 03 ROLLER SHADE TO BE INSTALLED AS SHOWN.
- 04 INSTALL CEILING MOUNTED SECURITY CAMERA AS INDICATED.
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- 07 DO NOT BLOCK FOOD CASE INTAKE/EXHAUST.
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- 25 PLACE FIRE EXTINGUISHER PER LOCAL FIRE CODE REQUIREMENTS. COORDINATE TYPE AND SIZE WITH LOCAL INSPECTOR.

GENERAL NOTES

- A. FOR GRAPHICS SCHEDULE, REFER TO THE FURNITURE, FIXTURES, AND EQUIPMENT (FF & E) SCHEDULES ON SHEET I601.
- B. REFER TO MANUFACTURER'S INSTRUCTIONS INCLUDED WITH ARTWORK/GRAPHICS FOR PROPER INSTALLATION.
- C. CHANGE PAINT COLOR ONLY AT INSIDE CORNERS UNLESS OTHERWISE INDICATED.
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- G. ALL WOOD SURFACES (DOORS, TRIM, SHELVES, CABINETS) SHALL BE SEALED.
- H. REFER TO CASEWORK FINISH SCHEDULE ON THE CASEWORK FINISH PLAN ON SHEET I102 FOR CASEWORK FINISH MATERIAL INFORMATION.
- I. ALIGN TILE TRANSITIONS ON WHOLE TILES AS SHOWN.
- J. ALL FLOOR AND WALL JUNCTIONS IN STORAGE AND FOOD PREPARATION AREAS SHALL HAVE A 6" COVED BASE.
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01 CAFE TOWARDS FRONT LINE
Scale: 1/2" = 1'-0"

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STARBUCKS TEMPLATE VERSION: I2024.01.01

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PROJECT NAME:
A1A & 10TH

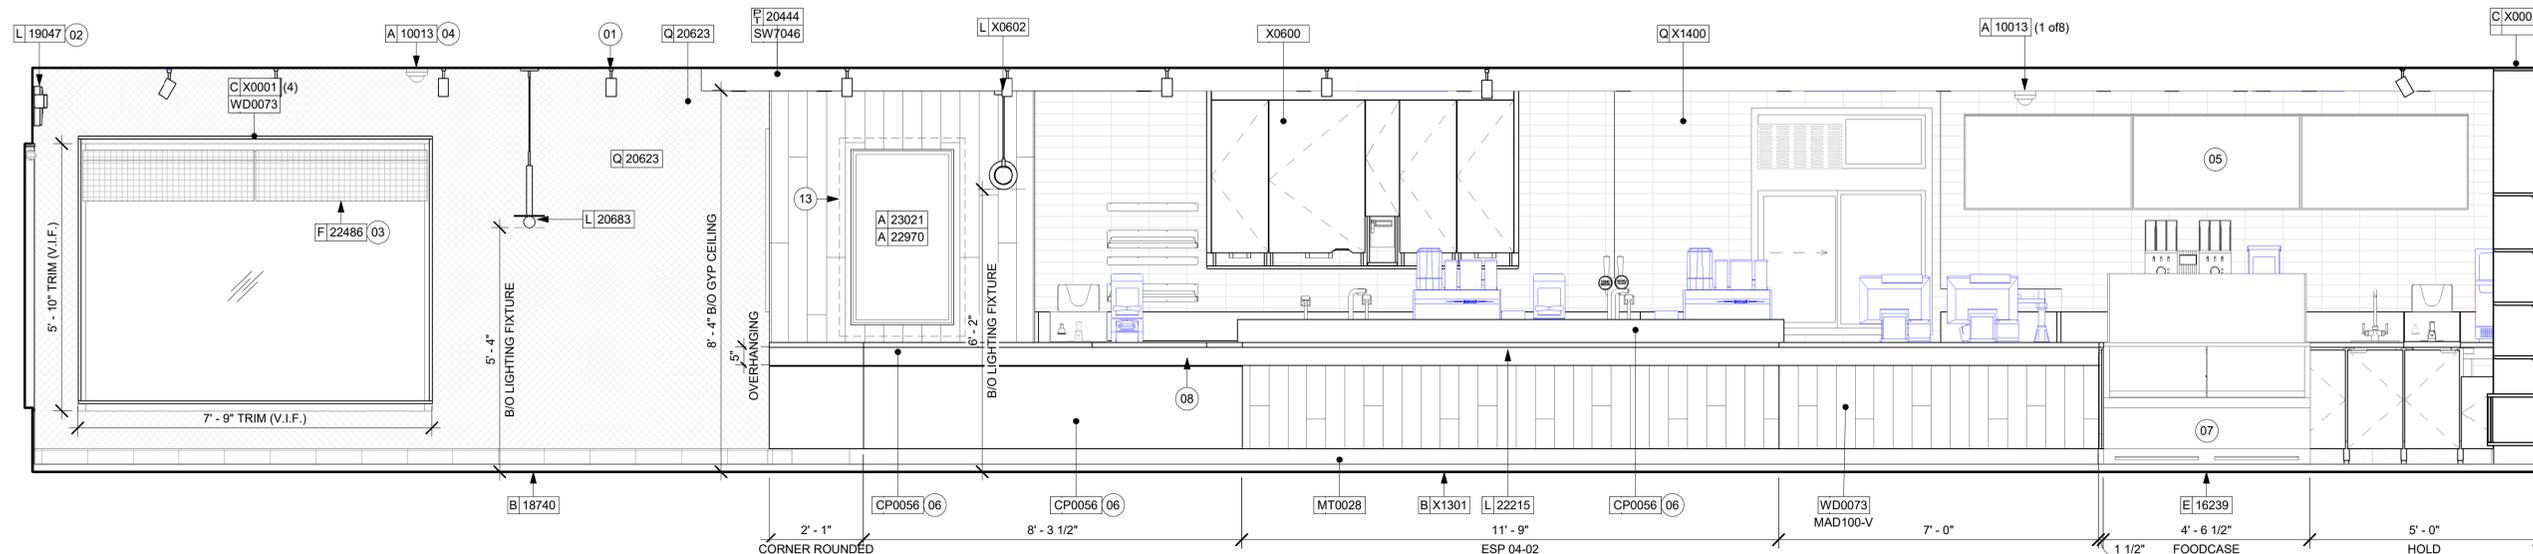
PROJECT ADDRESS:
**975 3RD STREET SOUTH
JACKSONVILLE BEACH, FL
32250**

STORE #: 8565
PROJECT #: 18756-108
ISSUE DATE: 03-27-2024
DESIGN MANAGER: ROMINA VIGNOLO
PRODUCTION DESIGNER: GENSLER
CHECKED BY: GENSLER


Revision Schedule			
Rev	Date	By	Description

SHEET TITLE:
**INTERIOR FINISH
ELEVATIONS**
SCALE: AS SHOWN


SHEET NUMBER:
1202

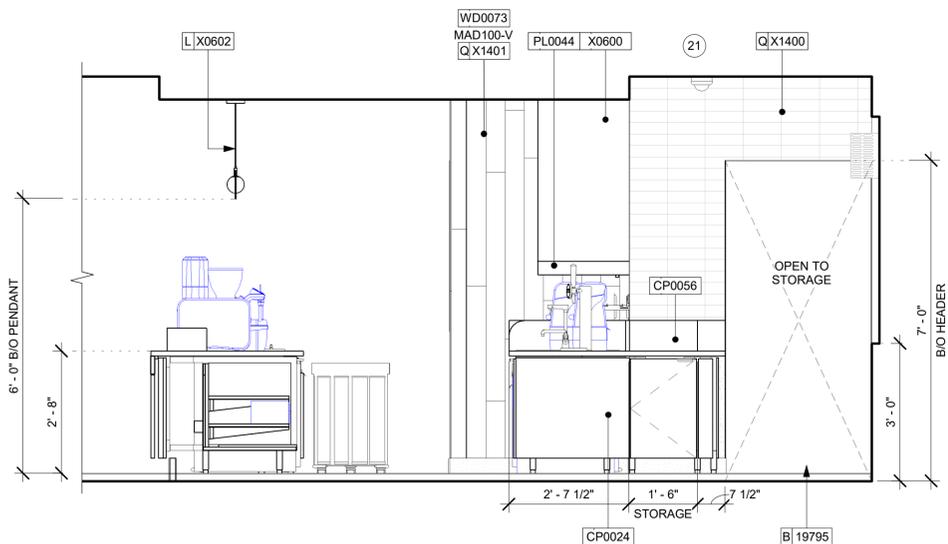

03 ENGINE TOWARDS DRY STORAGE
Scale: 1/2" = 1'-0"

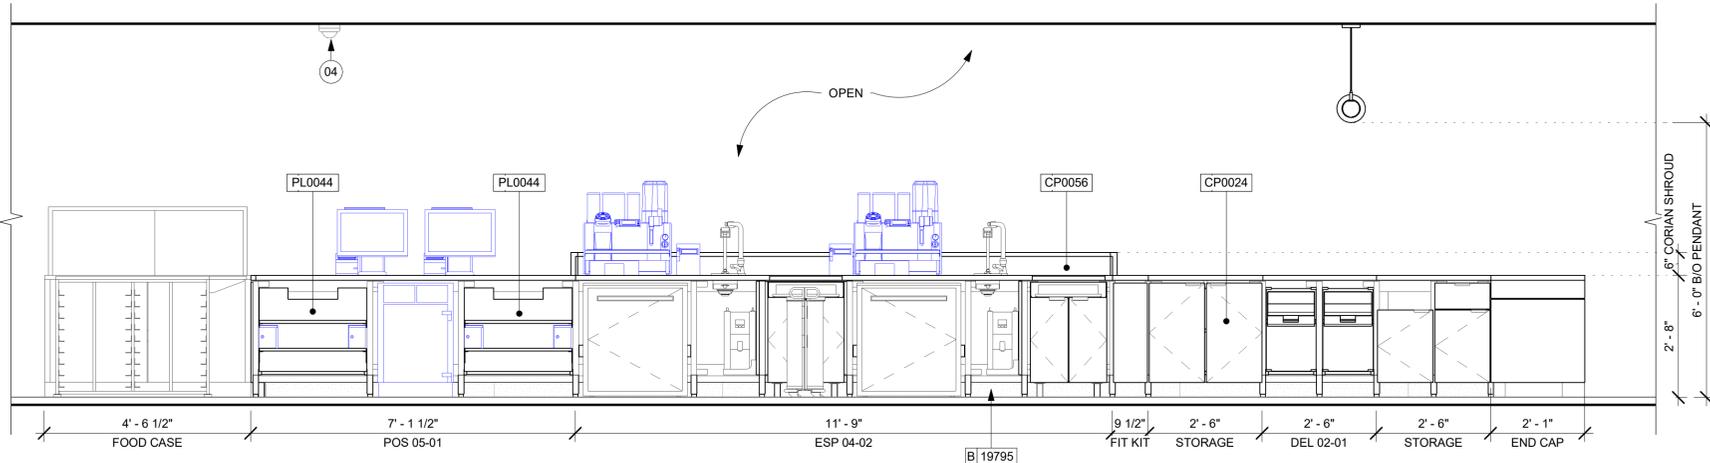

02 ENGINE TOWARDS FRONT LINE
Scale: 1/2" = 1'-0"

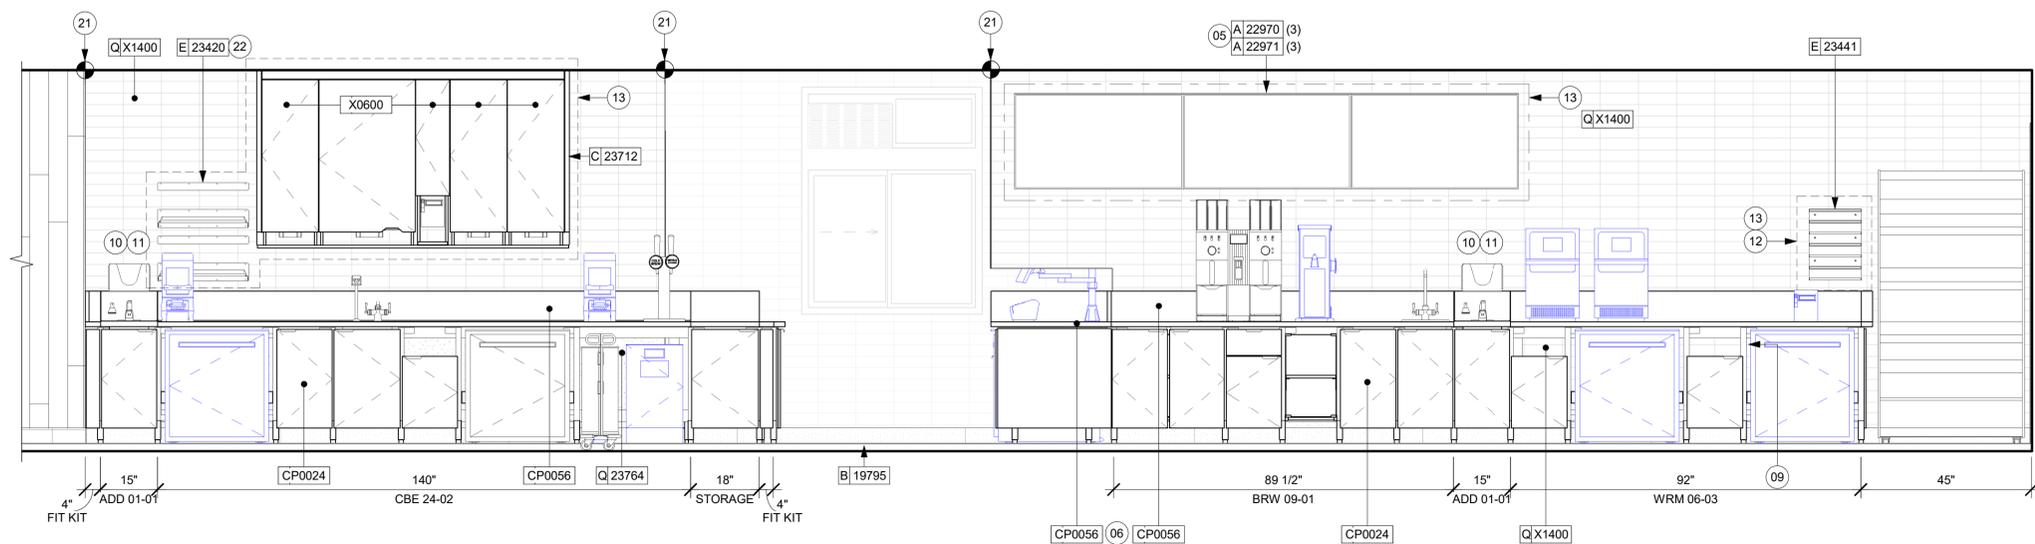

01 ENGINE TOWARDS BACK LINE
Scale: 1/2" = 1'-0"

KEYED NOTES

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STARBUCKS TEMPLATE VERSION: i2024.01.01

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PERMIT SET - FOR CONSTRUCTION USE

PROJECT NAME:
A1A & 10TH


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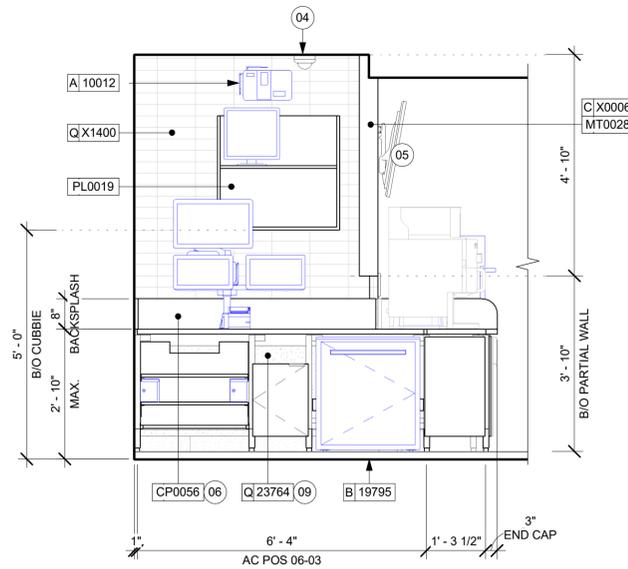
Revision Schedule			
Rev	Date	By	Description

SHEET TITLE:
**INTERIOR FINISH
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SCALE: AS SHOWN


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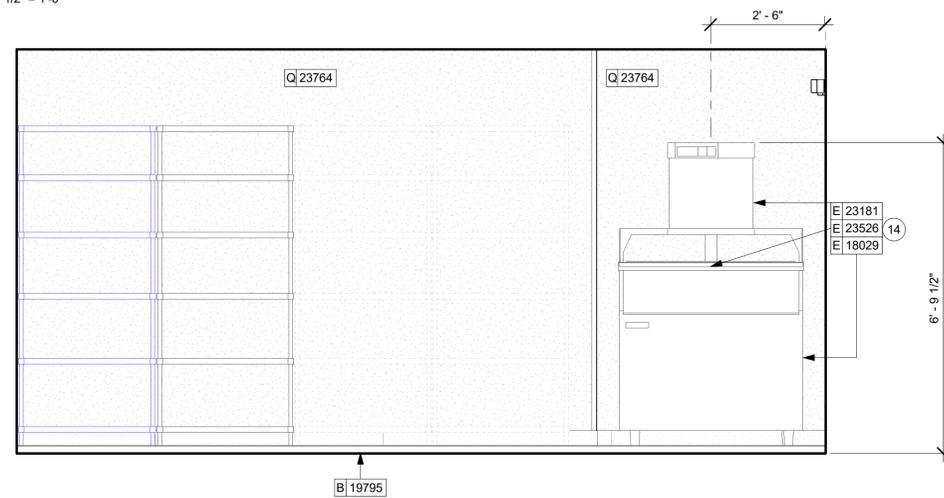
05 ENGINE TOWARDS WRM STATION
Scale: 1/2" = 1'-0"




06 ENGINE TOWARDS DT POS
Scale: 1/2" = 1'-0"

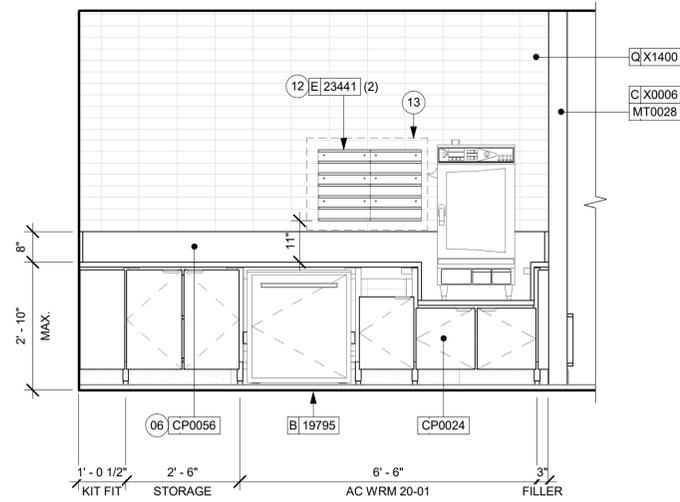


03 DRY STORAGE TOWARDS ICE DIVERTER
Scale: 1/2" = 1'-0"

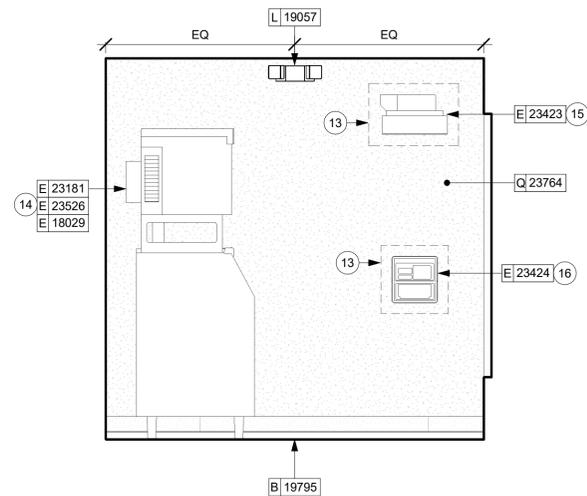

04 DRY STORAGE TOWARDS ICE MACHINE
Scale: 1/2" = 1'-0"

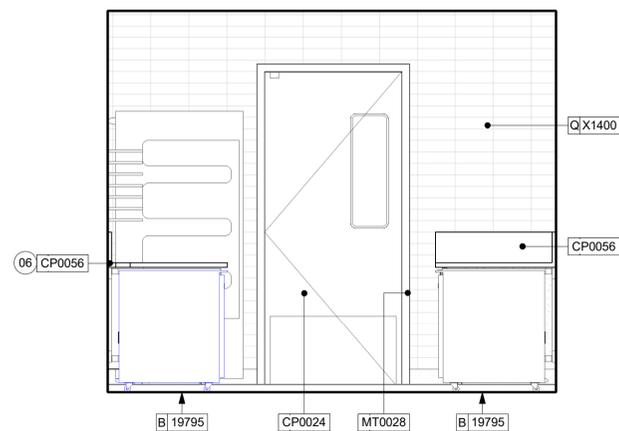

01 ENGINE TOWARDS BOH ENTRANCE
Scale: 1/2" = 1'-0"

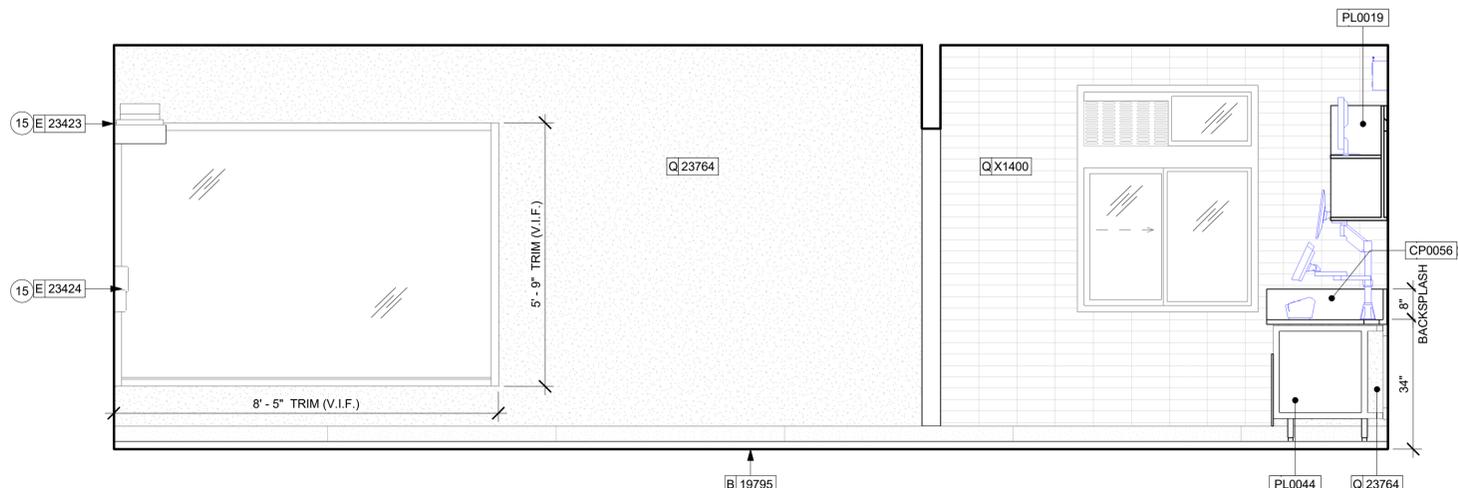

02 DRY STORAGE TOWARDS DT WINDOW
Scale: 1/2" = 1'-0"

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- 08 UNDERCOUNTER LED LIGHTING TO BE INSTALLED AT FRONT BAR AS INDICATED. REFER TO SCHEDULE FOR SPECIFICATIONS AND ELECTRICAL SHEETS FOR ADDITIONAL INFORMATION.
- 09 WALL FINISH BEHIND EXPOSED CABINETRY AND BELOW UNDERSIDE OF COUNTERTOP SUBSTRATE TO BE FRP EXCEPT WARMING WALL TILE TO BE EXTEND FROM WALL BASE TO UNDERSIDE OF COUNTERTOP.
- 10 PROVIDE 6" (150MM) MIN. INTEGRAL SPLASHGUARD AT HAND SINK PER JURISDICTIONAL REQUIREMENTS.
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- 12 INSTALL PASTRY WALL-STORAGE FOR WARMING STATION AS SHOWN. G.C. TO PROVIDE WALL BLOCKING FOR FASTENERS.
- 13 IN-WALL WOOD BLOCKING. VERIFY BLOCKING LOCATION, EXTENTS AND BLOCKING WITH MANUFACTURER'S REQUIREMENTS.
- 14 ICE MACHINE (SEE PLUMBING AND ELECTRICAL DRAWINGS FOR ADDITIONAL INFORMATION).
- 15 ICE DIVERTER.
- 16 WATER MANAGER CONTROL PANEL.
- 17 WATER FILTRATION EQUIPMENT. REFER TO PLUMBING DRAWINGS.
- 18 WATER HEATER. REFER TO PLUMBING DRAWINGS.
- 19 EXISTING WALL FINISHES TO REMAIN. GC TO CLEAN, PATCH AND REPAIR TO ACHIEVE LIKE-NEW CONDITION.
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- 23 BARRIER FREE NEW HARDWARE. REFER TO SHEET A602 FOR MORE INFORMATION. GC WILL BE RESPONSIBLE TO SPECIFY, REPAIR THE AREA, INSTALL IT, AND COORDINATE WITH LANDLORD.
- 24 RECESSED ELECTRICAL PANELS (SEE ELECTRICAL DRAWINGS FOR ADDITIONAL INFORMATION).
- 25 PLACE FIRE EXTINGUISHER PER LOCAL FIRE CODE REQUIREMENTS. COORDINATE TYPE AND SIZE WITH LOCAL INSPECTOR.



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STARBUCKS TEMPLATE VERSION: I2024.01.01

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PROJECT NAME:
A1A & 10TH

PROJECT ADDRESS:
**975 3RD STREET SOUTH
JACKSONVILLE BEACH, FL
32250**


STORE #: 8565
PROJECT #: 18756-108
ISSUE DATE: 03-27-2024
DESIGN MANAGER: ROMINA VIGNOLO
PRODUCTION DESIGNER: GENSLER
CHECKED BY: GENSLER

Revision Schedule			
Rev	Date	By	Description


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**INTERIOR FINISH
ELEVATIONS**
SCALE: AS SHOWN

SHEET NUMBER:
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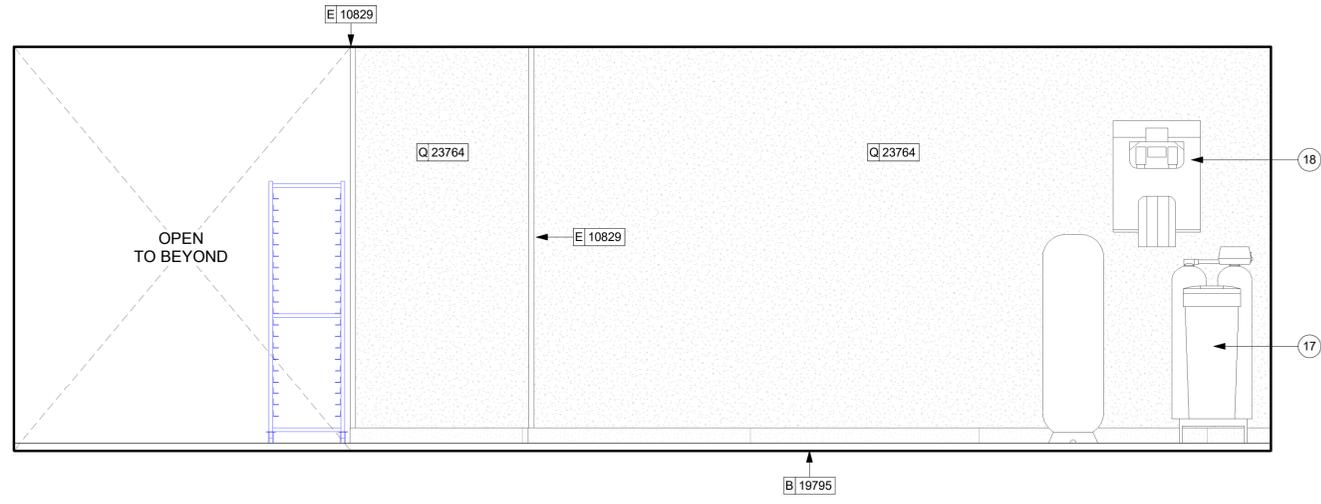
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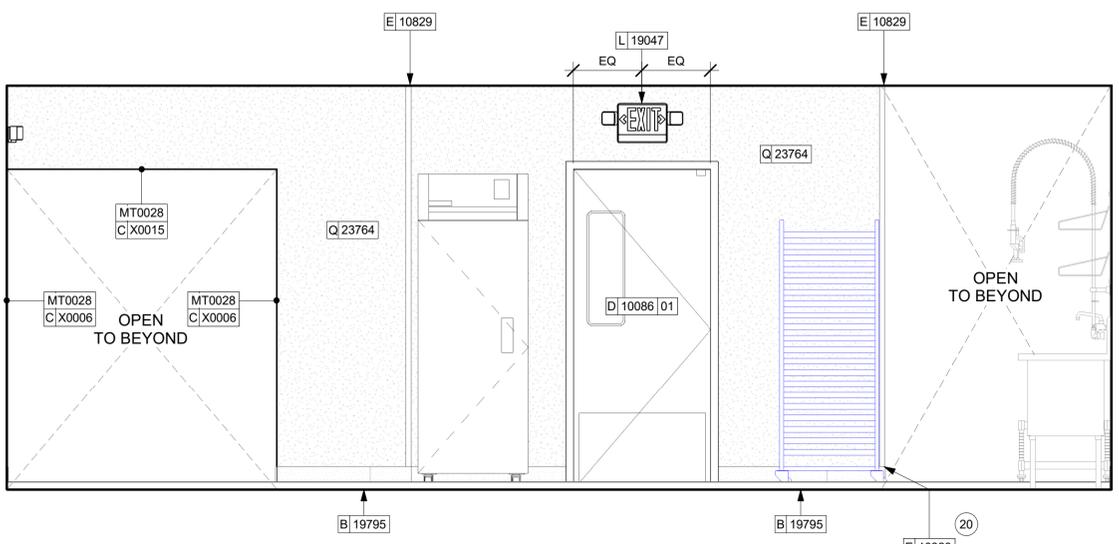
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Scale: 1/2" = 1'-0"

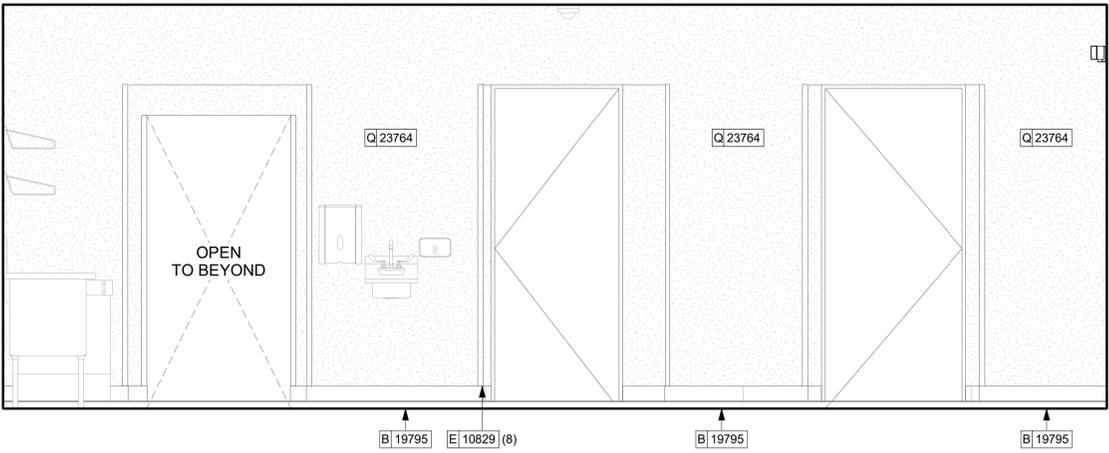


05 BOH TOWARDS MOP SINK
Scale: 1/2" = 1'-0"

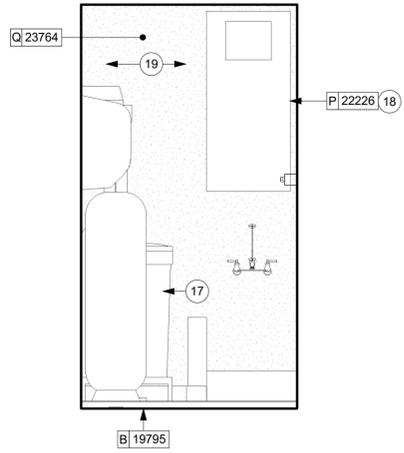

03 BOH TOWARDS WATER FILTRATION SYSTEM
Scale: 1/2" = 1'-0"



01 BOH TOWARDS BOH ENTRANCE
Scale: 1/2" = 1'-0"

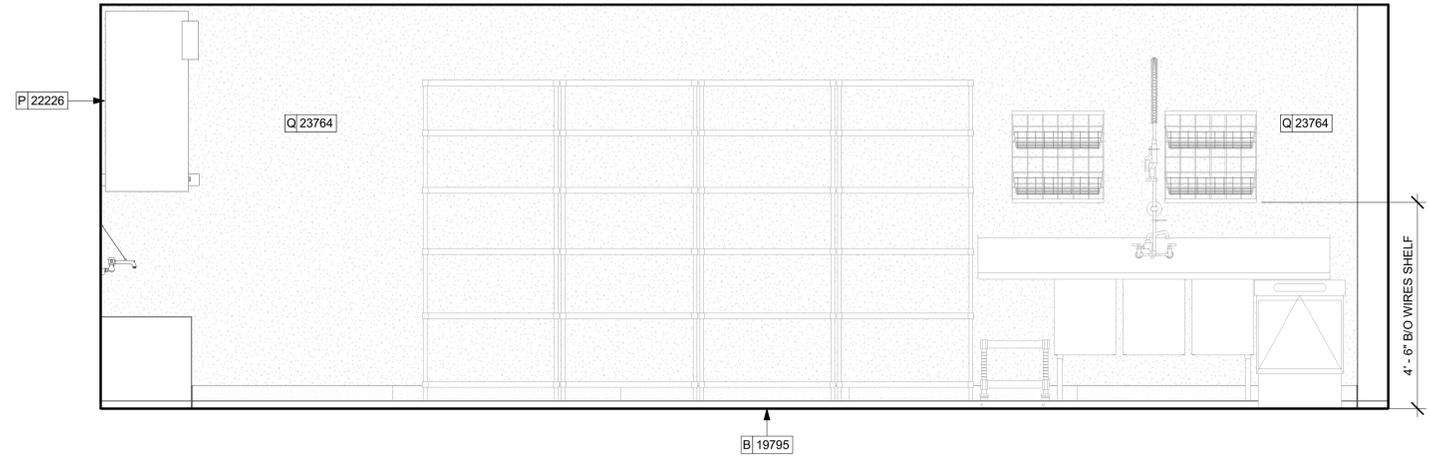

02 BOH TOWARDS 3 COMP-SINK
Scale: 1/2" = 1'-0"

KEYED NOTES

- 01 LIGHT FIXTURE (SEE REFLECTED CEILING PLAN ON SHEET 1103 AND LIGHTING PLAN ON SHEET E102 FOR ADDITIONAL INFORMATION)
- 02 EMERGENCY EXIT/LIGHT SIGNAGE COMBO. CEILING ATTACHMENT. REFER TO 1103 AND ELECTRICAL SHEETS FOR ADDITIONAL INFORMATION. GC TO VERIFY WITH LOCAL FIRE MARSHALL ON PLACEMENT AND QUANTITIES PRIOR TO INSTALLATION. GC TO ATTACH AN SUSPENSION KIT.
- 03 ROLLER SHADE TO BE INSTALLED AS SHOWN.
- 04 INSTALL CEILING MOUNTED SECURITY CAMERA AS INDICATED.
- 05 ATTACH DIGITAL MENU BOARDS PER INSTALLATION DETAIL.
- 06 CORIAN SHROUD.
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- 08 UNDERCOUNTER LED LIGHTING TO BE INSTALLED AT FRONT BAR AS INDICATED. REFER TO SCHEDULE FOR SPECIFICATIONS AND ELECTRICAL SHEETS FOR ADDITIONAL INFORMATION.
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- 15 ICE DIVERTER.
- 16 ICE MANAGER CONTROL PANEL.
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- 18 WATER HEATER. REFER TO PLUMBING DRAWINGS.
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- 24 RECESSED ELECTRICAL PANELS (SEE ELECTRICAL DRAWINGS FOR ADDITIONAL INFORMATION).
- 25 PLACE FIRE EXTINGUISHER PER LOCAL FIRE CODE REQUIREMENTS. COORDINATE TYPE AND SIZE WITH LOCAL INSPECTOR.

GENERAL NOTES

- A. FOR GRAPHICS SCHEDULE, REFER TO THE FURNITURE, FIXTURES, AND EQUIPMENT (FF & E) SCHEDULES ON SHEET 1601.
- B. REFER TO MANUFACTURER'S INSTRUCTIONS INCLUDED WITH ARTWORK/GRAPHICS FOR PROPER INSTALLATION.
- C. CHANGE PAINT COLOR ONLY AT INSIDE CORNERS UNLESS OTHERWISE INDICATED.
- D. PAINT FINISHES SHALL BE APPLIED AS FOLLOWS, UNLESS NOTED OTHERWISE.
 - a. WOODS AND METAL SURFACES SHALL BE SEMI-GLOSS OR EQUAL.
 - b. ACCENT AND TRIM PAINTS TO BE SEMI-GLOSS OR EQUAL.
 - c. WALL AND CEILING PAINTS TO BE EGGSHELL OR EQUAL.
 - d. PAINTS IN BOH, RESTROOM(S) OR CAFE BAR SHALL BE SEMI-GLOSS OR EQUAL.
- E. PAINT SUBSTITUTIONS ARE NOT ALLOWED. USE STARBUCKS NATIONAL ACCOUNT COLOR CODE WHEN ORDERING PAINTS.
- F. FLOORS, WALLS AND CEILING FINISHES IN FOOD PREPARATION AREAS SHALL BE SMOOTH, NON-TOXIC, NON-ABSORBENT, DURABLE AND EASILY CLEANABLE. PAINT SHALL BE WASHABLE; SEMI-GLOSS OR HIGH GLOSS FINISH.
- G. ALL WOOD SURFACES (DOORS, TRIM, SHELVES, CABINETS) SHALL BE SEALED.
- H. REFER TO CASEWORK FINISH SCHEDULE ON THE CASEWORK FINISH PLAN ON SHEET 1102 FOR CASEWORK FINISH MATERIAL INFORMATION.
- I. ALIGN TILE TRANSITIONS ON WHOLE TILES AS SHOWN.
- J. ALL FLOOR AND WALL JUNCTIONS IN STORAGE AND FOOD PREPARATION AREAS SHALL HAVE A 6" COVED BASE.
- K. ALL FOOD STORAGE SHALL BE 6" (150MM) A.F.F.
- L. INSTALL BLOCKING AND HANGERS FOR WALL SHELVING BEFORE INSTALLING BACK BAR TILE.
- M. GENERAL CONTRACTOR TO PROVIDE AND INSTALL WORKROOM WALL FINISHES.
- N. CLASS A FIRE RETARDANT TREATMENT (PER ASTM E 84), OR PASSES NFPA 286 (DID: SPC006). CASEWORK VENDOR TO PROVIDE WOOD CLEAR SHERWIN WILLIAMS "CLASS A VARNISHSYSTEM" FLAMES SPREAD RETARDANT OR SIMILAR. APPLY PER MFR'S RECOMMENDATIONS ON ALL SIDES OF PANELS PRIOR TO SEALER. GC TO TEST PRIOR TO INSTALLATION.



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PROJECT NAME:
A1A & 10TH

PROJECT ADDRESS:
**975 3RD STREET SOUTH
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32250**


STORE #: 8565
PROJECT #: 18756-108
ISSUE DATE: 03-27-2024
DESIGN MANAGER: ROMINA VIGNOLO
PRODUCTION DESIGNER: GENSLER
CHECKED BY: GENSLER

Revision Schedule			
Rev	Date	By	Description

SHEET TITLE:
**INTERIOR FINISH
ELEVATIONS**
SCALE: AS SHOWN


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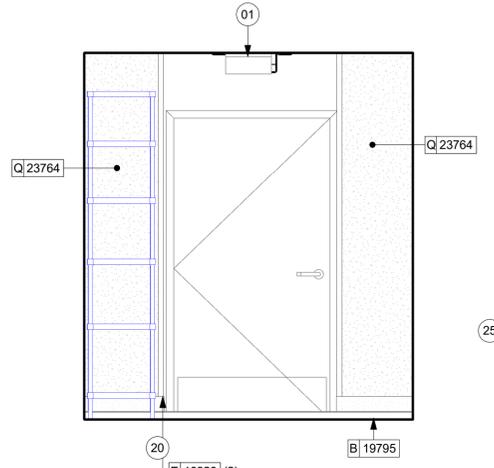
07 BOH TOWARDS ELECTRICAL PANELS

Scale: 1/2" = 1'-0"

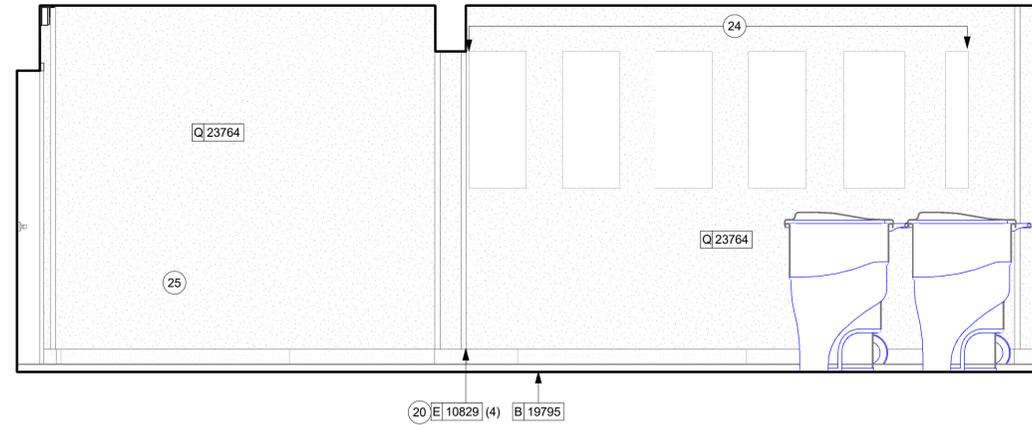

05 BOH TOWARDS IT RACK

Scale: 1/2" = 1'-0"

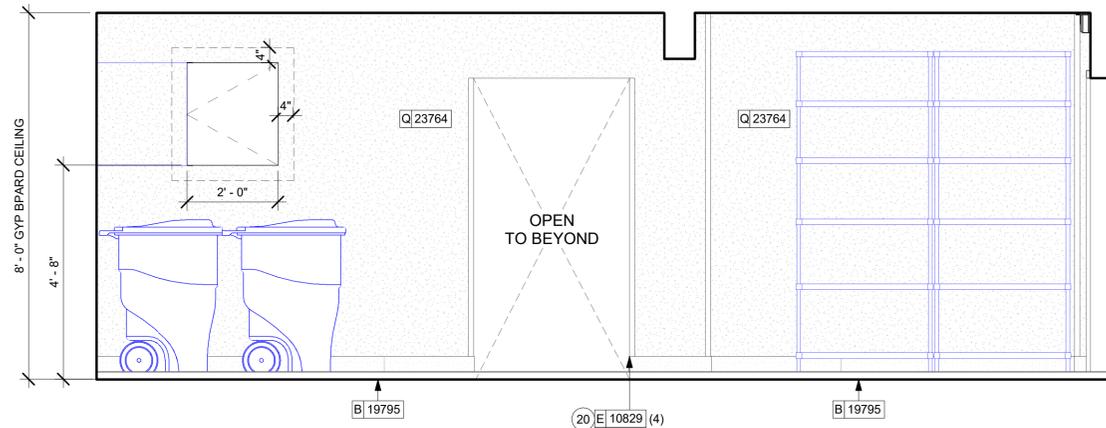

06 BOH TOWARDS BOH EXIT

Scale: 1/2" = 1'-0"

KEYED NOTES

- 01 LIGHT FIXTURE (SEE REFLECTED CEILING PLAN ON SHEET 1103 AND LIGHTING PLAN ON SHEET E102 FOR ADDITIONAL INFORMATION)
- 02 EMERGENCY EXIT/LIGHT SIGNAGE COMBO, CEILING ATTACHMENT, REFER TO 1103 AND ELECTRICAL SHEETS FOR ADDITIONAL INFORMATION. GC TO VERIFY WITH LOCAL FIRE MARSHALL ON PLACEMENT AND QUANTITIES PRIOR TO INSTALLATION. GC TO ATTACH AN SUSPENSION KIT.
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GENERAL NOTES

- A. FOR GRAPHICS SCHEDULE, REFER TO THE FURNITURE, FIXTURES, AND EQUIPMENT (FF & E) SCHEDULES ON SHEET I601.
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- H. REFER TO CASEWORK FINISH SCHEDULE ON THE CASEWORK FINISH PLAN ON SHEET 1102 FOR CASEWORK FINISH MATERIAL INFORMATION.
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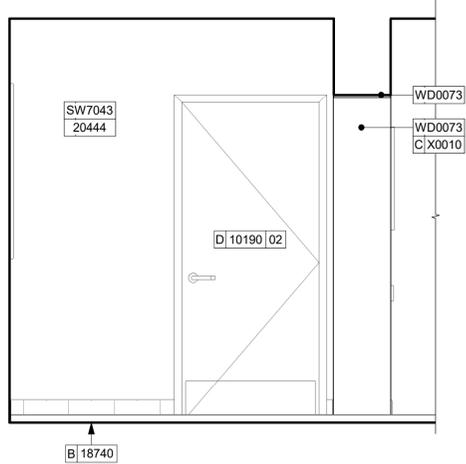
STORE #: 8565
PROJECT #: 18756-108
ISSUE DATE: 03-27-2024
DESIGN MANAGER: ROMINA VIGNOLO
PRODUCTION DESIGNER: GENSLER
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Revision Schedule			
Rev	Date	By	Description


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**INTERIOR FINISH
ELEVATIONS**
SCALE: AS SHOWN

SHEET NUMBER:
1206


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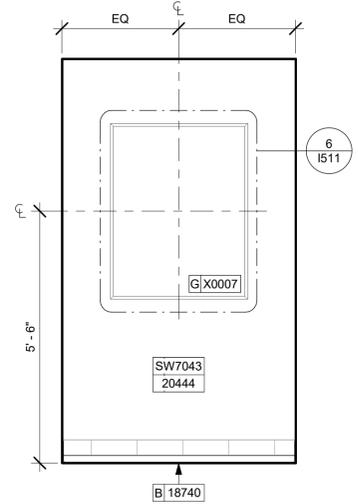
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Scale: 1/2" = 1'-0"




05 RR ELEVATION AT EAST
Scale: 1/2" = 1'-0"

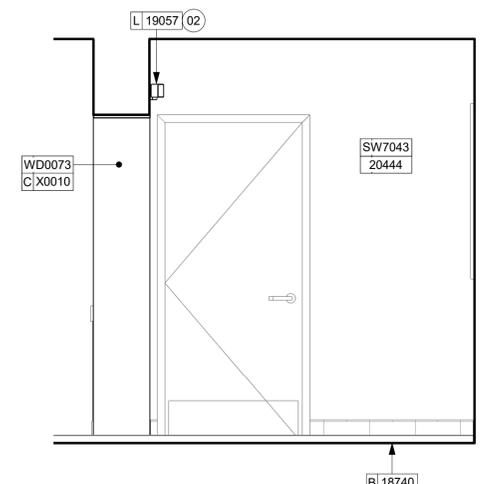


06 RR ELEVATION AT NORTH
Scale: 1/2" = 1'-0"

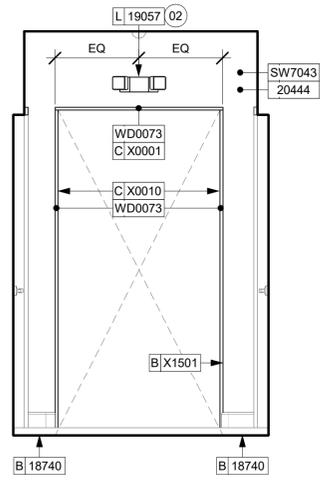


07 RR ELEVATION AT SOUTH
Scale: 1/2" = 1'-0"

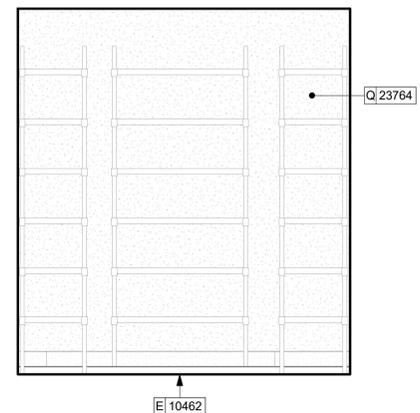


01 DRY STORAGE AT EAST
Scale: 1/2" = 1'-0"

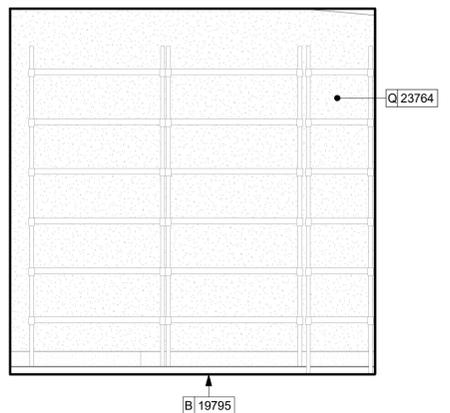

02 DRY STORAGE AT NORTH
Scale: 1/2" = 1'-0"

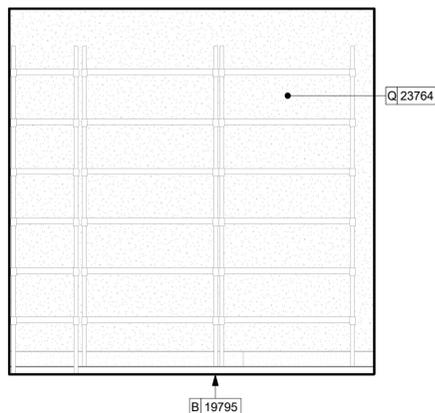

03 DRY STORAGE AT SOUTH
Scale: 1/2" = 1'-0"

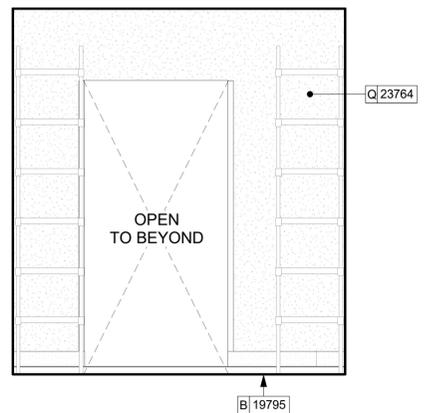

04 DRY STORAGE AT WEST
Scale: 1/2" = 1'-0"

KEYED NOTES

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- 18 WATER HEATER. REFER TO PLUMBING DRAWINGS.
- 19 EXISTING WALL FINISHES TO REMAIN. GC TO CLEAN, PATCH AND REPAIR TO ACHIEVE LIKE-NEW CONDITION.
- 20 INSTALL CORNER GUARD AT OUTSIDE CORNER AS INDICATED. REFER TO DETAIL.
- 21 STARTING POINT FOR TILE INSTALLATION. WALL TILE GROUT LINES TO ALIGN AS INDICATED. EXCESS TILE TO BE CUT TO ALIGN.
- 22 INSTALL SHELVING AS SHOWN. G.C. TO PROVIDE WALL BLOCKING FOR FASTENERS.
- 23 BARRIER FREE NEW HARDWARE. REFER TO SHEET A602 FOR MORE INFORMATION. GC WILL BE RESPONSIBLE TO SPECIFY, REPAIR THE AREA, INSTALL IT, AND COORDINATE WITH LANDLORD.
- 24 RECESSED ELECTRICAL PANELS (SEE ELECTRICAL DRAWINGS FOR ADDITIONAL INFORMATION).
- 25 PLACE FIRE EXTINGUISHER PER LOCAL FIRE CODE REQUIREMENTS. COORDINATE TYPE AND SIZE WITH LOCAL INSPECTOR.

GENERAL NOTES

- A. FOR GRAPHICS SCHEDULE, REFER TO THE FURNITURE, FIXTURES, AND EQUIPMENT (FF & E) SCHEDULES ON SHEET I601.
- B. REFER TO MANUFACTURER'S INSTRUCTIONS INCLUDED WITH ARTWORK/GRAPHICS FOR PROPER INSTALLATION.
- C. CHANGE PAINT COLOR ONLY AT INSIDE CORNERS UNLESS OTHERWISE INDICATED.
- D. PAINT FINISHES SHALL BE APPLIED AS FOLLOWS, UNLESS NOTED OTHERWISE.
 - a. WOODS AND METAL SURFACES SHALL BE SEMI-GLOSS OR EQUAL.
 - b. ACCENT AND TRIM PAINTS TO BE SEMI-GLOSS OR EQUAL.
 - c. WALL AND CEILING PAINTS TO BE EGGSHELL OR EQUAL.
 - d. PAINTS IN BOH, RESTROOM(S) OR CAFE BAR SHALL BE SEMI-GLOSS OR EQUAL.
- E. PAINT SUBSTITUTIONS ARE NOT ALLOWED. USE STARBUCKS NATIONAL ACCOUNT COLOR CODE WHEN ORDERING PAINTS.
- F. FLOORS, WALLS AND CEILING FINISHES IN FOOD PREPARATION AREAS SHALL BE SMOOTH, NON-TOXIC, NON-ABSORBENT, DURABLE AND EASILY CLEANABLE. PAINT SHALL BE WASHABLE; SEMI-GLOSS OR HIGH GLOSS FINISH.
- G. ALL WOOD SURFACES (DOORS, TRIM, SHELVES, CABINERY) SHALL BE SEALED.
- H. REFER TO CASEWORK FINISH SCHEDULE ON THE CASEWORK FINISH PLAN ON SHEET I102 FOR CASEWORK FINISH MATERIAL INFORMATION.
- I. ALIGN TILE TRANSITIONS ON WHOLE TILES AS SHOWN.
- J. ALL FLOOR AND WALL JUNCTIONS IN STORAGE AND FOOD PREPARATION AREAS SHALL HAVE A 6" COVED BASE.
- K. ALL FOOD STORAGE SHALL BE 6" (150MM) A.F.F.
- L. INSTALL BLOCKING AND HANGERS FOR WALL SHELVING BEFORE INSTALLING BACK BAR TILE.
- M. GENERAL CONTRACTOR TO PROVIDE AND INSTALL WORKROOM WALL FINISHES.
- N. CLASS A FIRE RETARDANT TREATMENT (PER ASTM E 84), OR PASSES NFPA 286 (DID: SPC006). CASEWORK VENDOR TO PROVIDE WOOD CLEAR SHERWIN WILLIAMS "CLASS A VARNISHSYSTEM" FLAMES SPREAD RETARDANT OR SIMILAR. APPLY PER MFR'S RECOMMENDATIONS ON ALL SIDES OF PANELS PRIOR TO SEALER. GC TO TEST PRIOR TO INSTALLATION.



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PROJECT NAME:
A1A & 10TH

PROJECT ADDRESS:
**975 3RD STREET SOUTH
JACKSONVILLE BEACH, FL
32250**

STORE #: 8565
PROJECT #: 18756-108
ISSUE DATE: 03-27-2024
DESIGN MANAGER: ROMINA VIGNOLO
PRODUCTION DESIGNER: GENSLER
CHECKED BY: GENSLER

Revision Schedule			
Rev	Date	By	Description

SHEET TITLE:
**INTERIOR FINISH
ELEVATIONS**
SCALE: AS SHOWN

SHEET NUMBER:
1207

PERMIT SET - FOR CONSTRUCTION USE


KEYED NOTES

09 CENTER SCENCE LIGHTING OVER MIRROR (SEE ELECTRICAL).

GENERAL NOTES


- A. GENERAL CONTRACTOR TO VERIFY ALL DIMENSIONS AND NOTIFY STARBUCKS CONSTRUCTION MANAGER OF ANY DISCREPANCIES PRIOR TO CONSTRUCTION.
- B. ALL DIMENSIONS ARE TO BE TAKEN FROM A DESIGNATED DATUM POINT.
- C. DIMENSIONS ARE TO FACE OF FINISHED SURFACE UNLESS OTHERWISE NOTED.
- D. DIAPER CHANGING STATION IS TO BE INSTALLED PER MANUFACTURER'S INSTRUCTIONS. UNIT IS TO BE FASTENED TO STRUCTURE AT ALL SIX CHASSIS ATTACHMENT POINTS.
- E. LOCATE DIAPER CHANGING STATION AS SHOWN TO ALLOW NECESSARY CLEARANCE FOR OPERATION OF ALL RESTROOM FIXTURES. LOCATION SHALL NOT IMPEDE ACCESS, EGRESS, OR DOOR SWING.
- F. ALL RESTROOM ACCESSORY MOUNTING HEIGHTS AND CLEARANCES SHALL COMPLY WITH THE ACCESSIBILITY REQUIREMENTS OF THE LOCAL JURISDICTION.
- G. SEE MECHANICAL AND ELECTRICAL DRAWINGS FOR ALL SENSORS AND CONTROLS.

NOTE:
REFER SHEET G004.1 FOR ALL RESTROOM ACCESSORY MOUNTING HEIGHTS AND CLEARANCES.

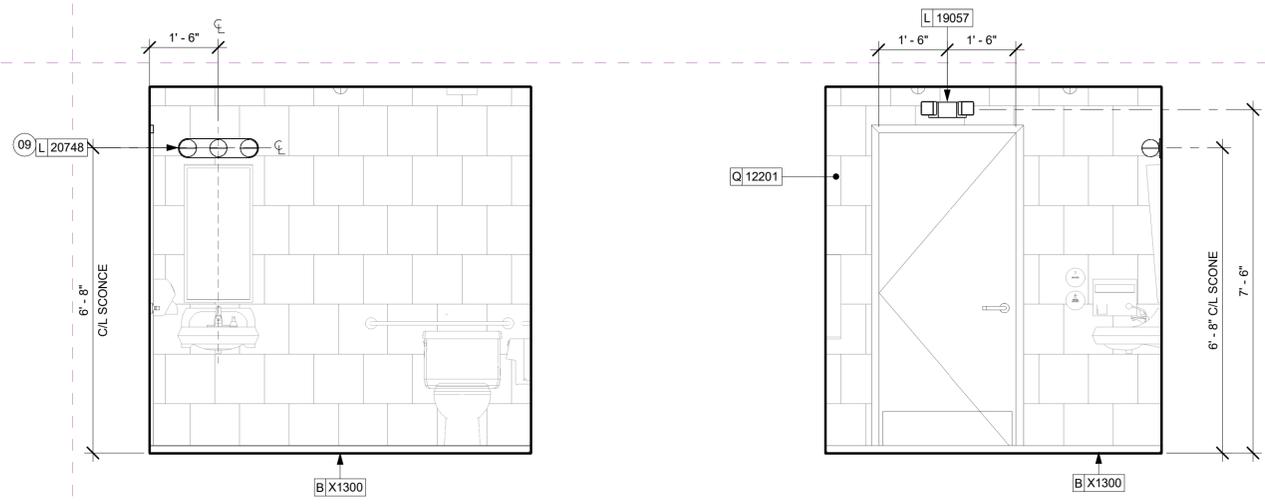

02 RR TOWARDS SCENCE
Scale: 1/2" = 1'-0"

03 RR TOWARDS EXIT DOOR
Scale: 1/2" = 1'-0"

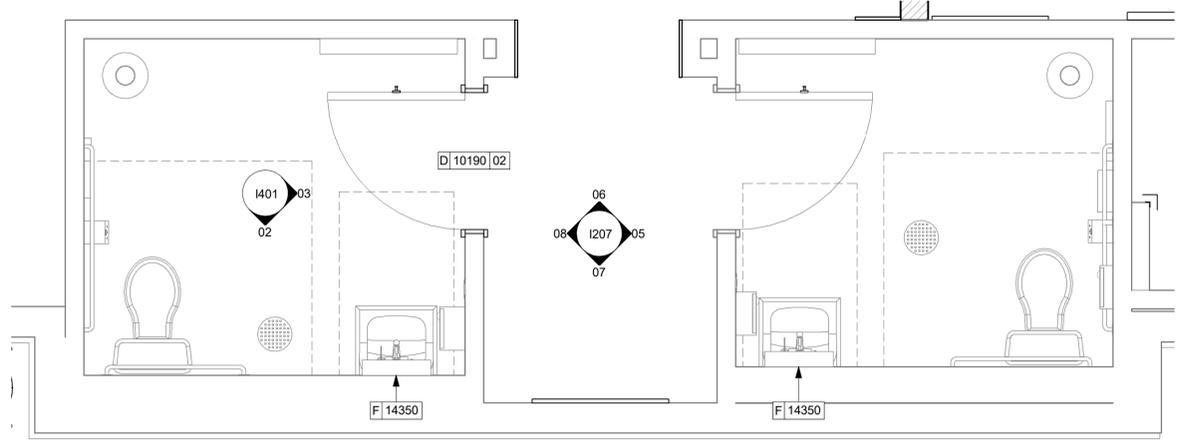

01 ENLARGED RR PLAN
Scale: 1/2" = 1'-0"

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STORE #: 8565
PROJECT #: 18756-108
ISSUE DATE: 03-27-2024
DESIGN MANAGER: ROMINA VIGNOLO
PRODUCTION DESIGNER: GENSLER
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Revision Schedule			
Rev	Date	By	Description

SHEET TITLE:
RESTROOM PLAN & ELEVATIONS
SCALE: AS SHOWN

SHEET NUMBER:
1401



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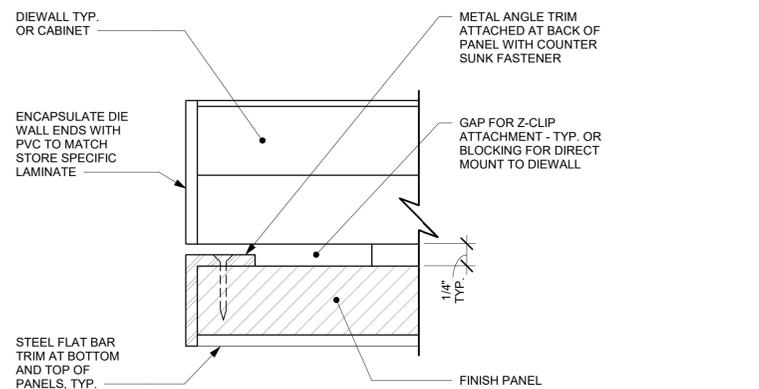
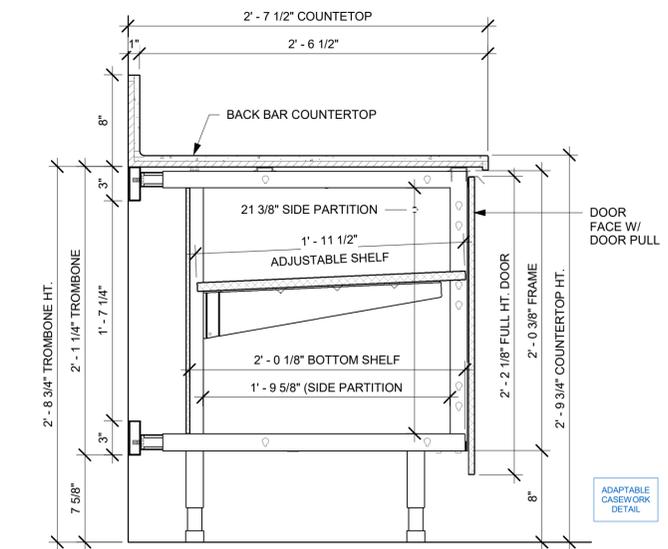
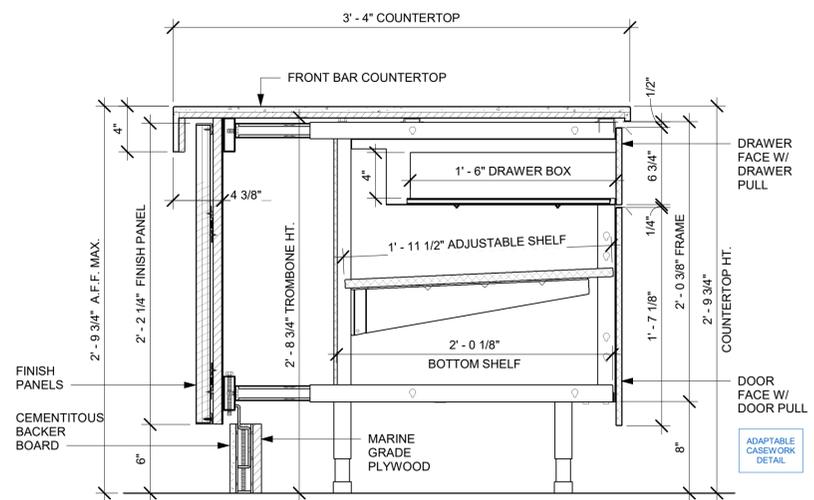
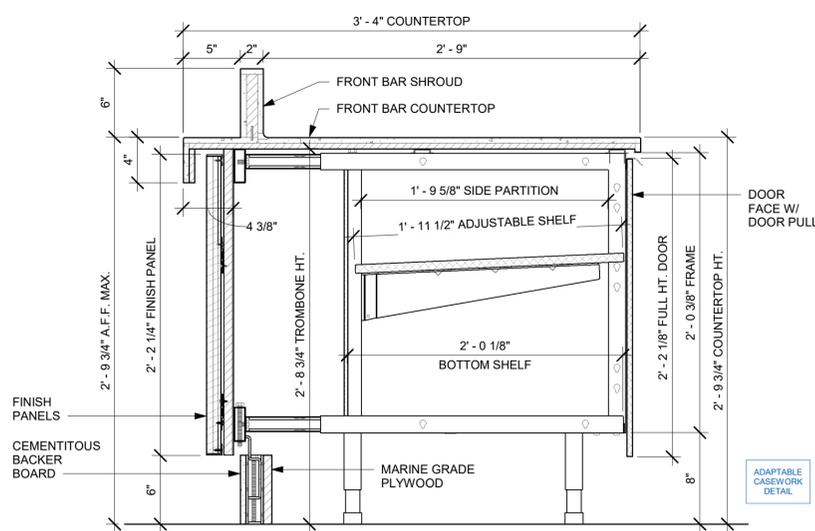
STORE #: 8565
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ISSUE DATE: 03-27-2024
DESIGN MANAGER: ROMINA VIGNOLO
PRODUCTION DESIGNER: GENSLER
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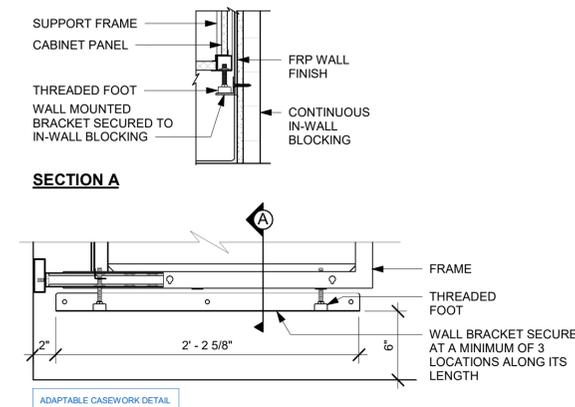
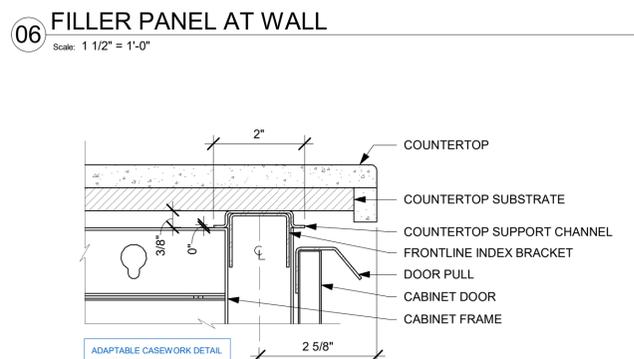
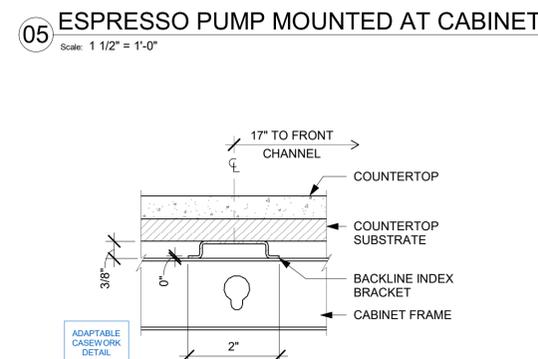
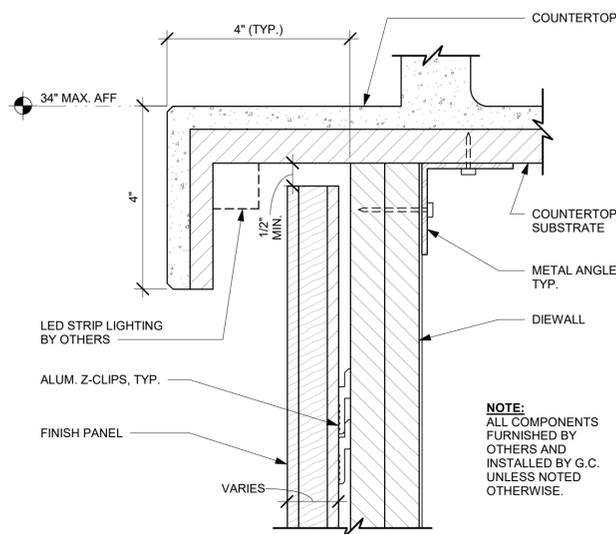
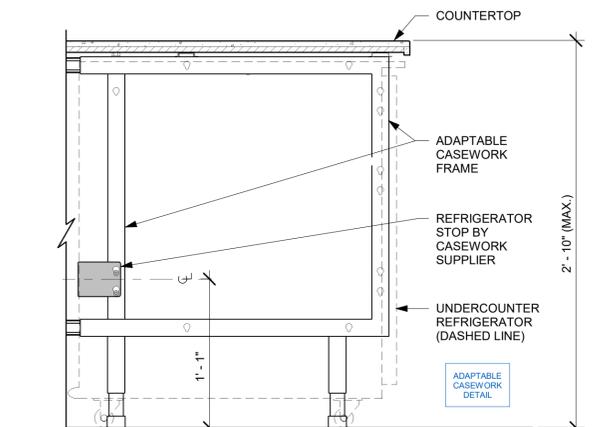
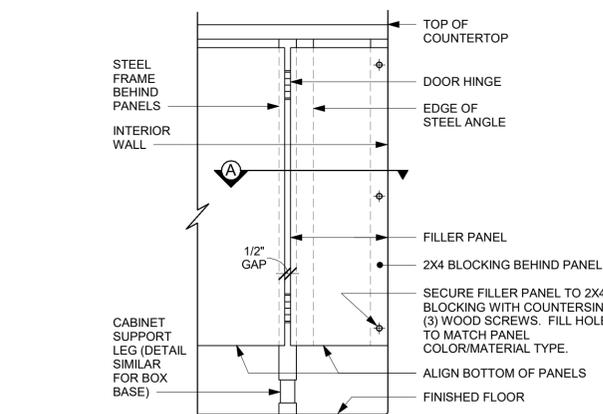
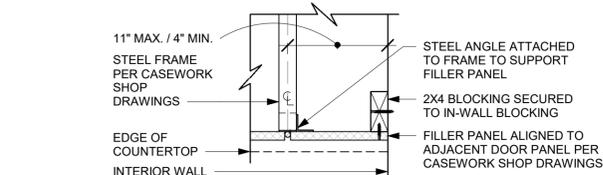
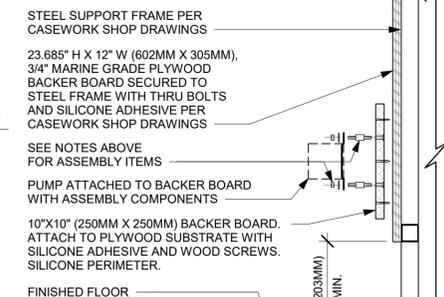
SHEET TITLE:
ADAPTABLE CASEWORK DETAILS
SCALE: AS SHOWN

SHEET NUMBER:
1501

PERMIT SET - FOR CONSTRUCTION USE



- NOTES:**
- LOCATE PUMP WITHIN CORD LENGTH LIMIT. ORIENT WITH PUMP HEAD LEFT, RIGHT AND AT BOTTOM. LOOSEN PUMP HEAD CLAMP, ROTATE AND RE-TIGHTEN AS REQUIRED PER ORIENTATION TO PROVIDE FRONT ACCESS TO FLOW. ADJUSTMENT WITHIN CORD LENGTH LIMIT.
 - USE LOCKTITE ON ISOLATOR THREADS. DO NOT OVER TIGHTEN.
 - LOOSEN PUMP HEAD CLAMP, ROTATE AND RE-TIGHTEN AS REQUIRED FOR PUMP ORIENTATION.
 - EACH BACKER BOARD'S ASSEMBLY COMPONENTS INCLUDE:
 - (1) BACKER BOARDS
 - (4) TENETS, 1/4-20 VENDOR MOUNTED
 - (8) WOOD SCREWS #8 1-1/4" (32MM)
 - (4) NEOPRENE ISOLATORS, KARMAN RUBBER, K84-60 NEOPRENE
 - (4) LOCK NUTS, 1/4-20 NYLON
 - (4) WASHERS, 1/4" (7MM) FLAT





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A1A & 10TH

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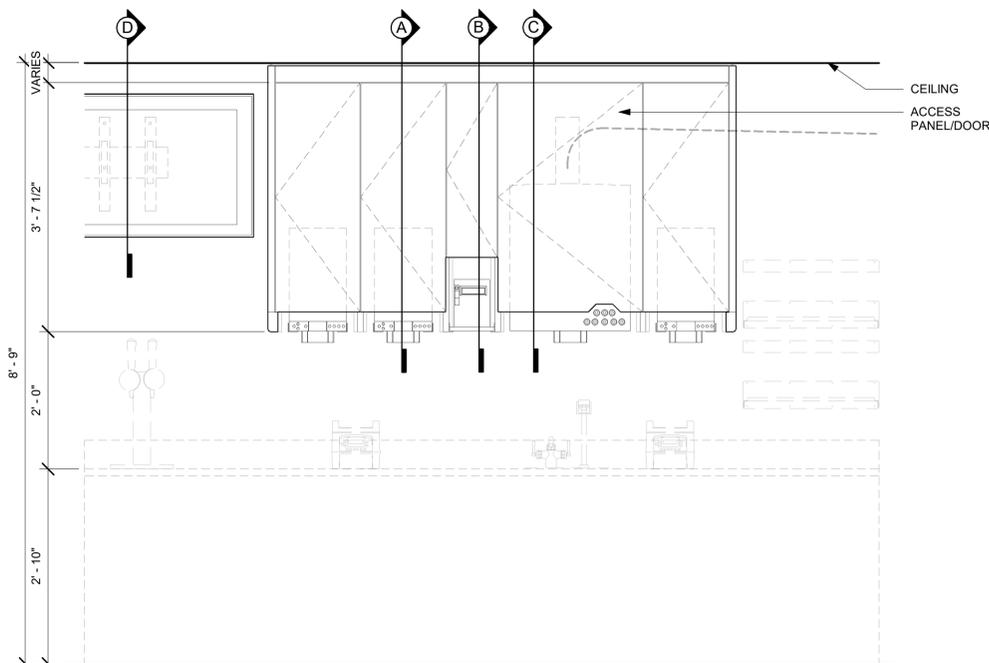
STORE #: 8565
 PROJECT #: 18756-108
 ISSUE DATE: 03-27-2024
 DESIGN MANAGER: ROMINA VIGNOLO
 PRODUCTION DESIGNER: GENSLER
 CHECKED BY: GENSLER

Revision Schedule			
Rev	Date	By	Description

SHEET TITLE:
**ADAPTABLE CASEWORK
 DETAILS**
 SCALE: AS SHOWN


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1501.1

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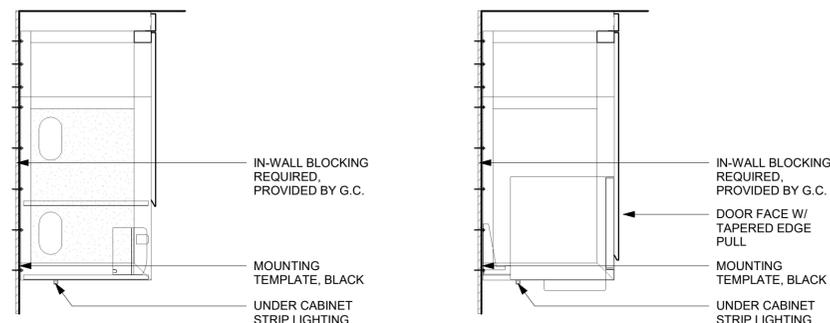
ELEVATION

- NOTE:
- CEILING HEIGHTS <10'-0" NO SOFFIT
 - 1. NUGGET ICE RIDE SYSTEM TO BE RUN IN WALL (8" STUDS MIN.)
 - 2. DMB TO BE MOUNTED ON BACK WALL ACCESS PANEL TO BE SIZED TO AVOID CONFLICT WITH LIGHTING COVE



SECTION D - DMB

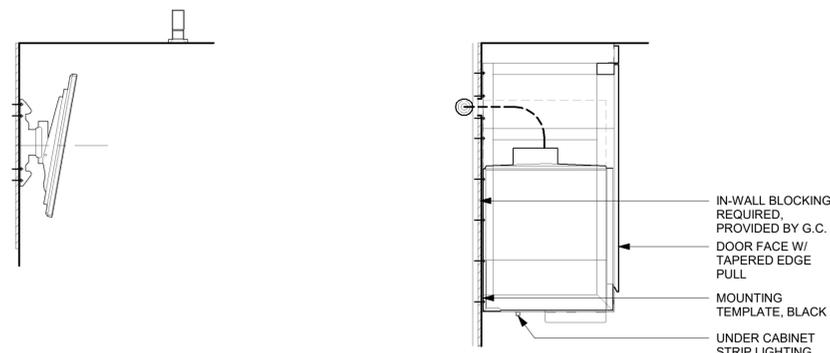SECTION A - NUGGET ICE DISPENSE




SECTION B - CUP LABELER

SECTION A - MILK DISPENSE


01 UPPER CABINET/SOFFIT ASSEMBLY - LOW CEILING

Scale: 3/4" = 1'-0"

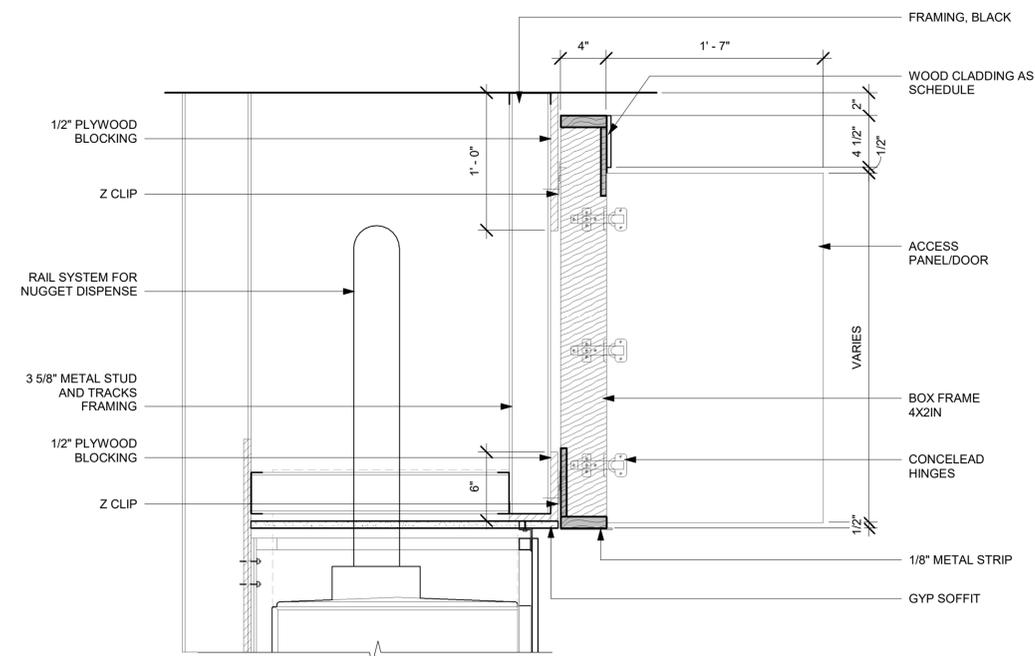


02 CBE DOOR AT SOFFIT


Scale: 1 1/2" = 1'-0"

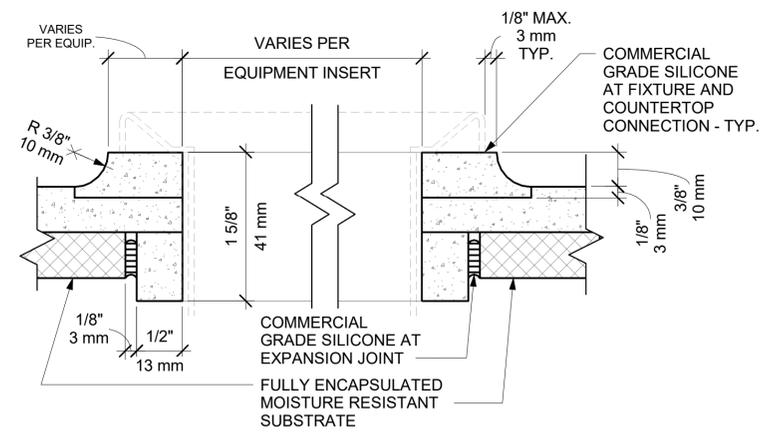


01 CORIAN COUNTERTOP TYP. SINK CUTOUT W/ COVERED EDGE
Scale: 12" = 1'-0"

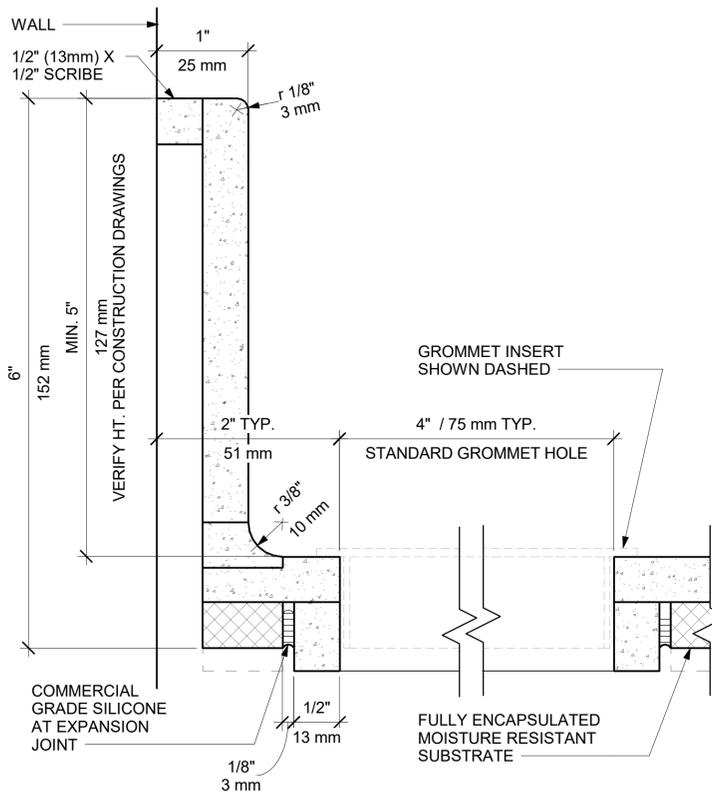


02 CORIAN COUNTERTOP TYP. CUTOUT AT TRASH AND GROMMET
Scale: 12" = 1'-0"

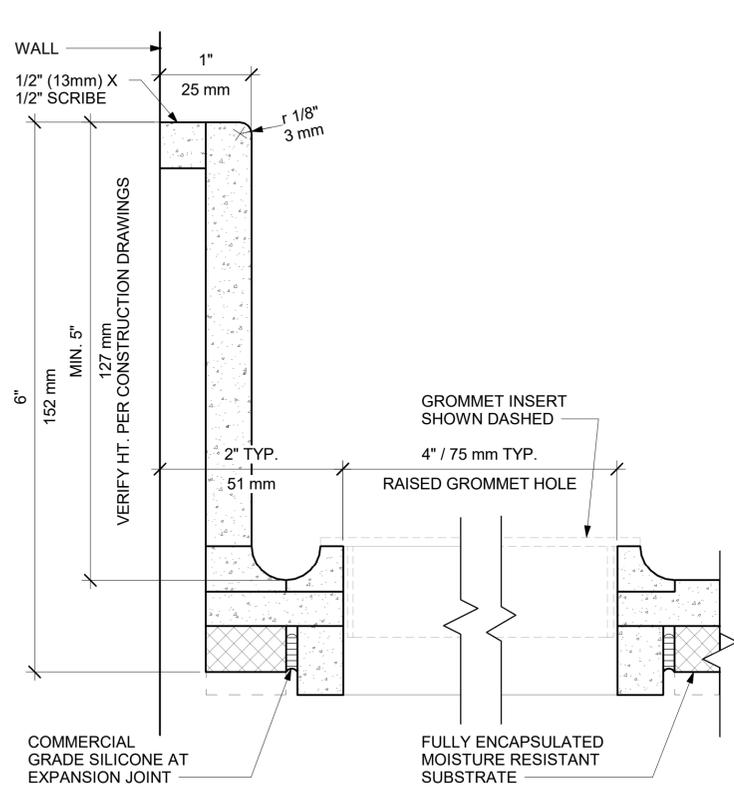

03 CORIAN COUNTERTOP TYP. ICE BIN CUTOUT WITH W/ SQUARED EDGE
Scale: 12" = 1'-0"

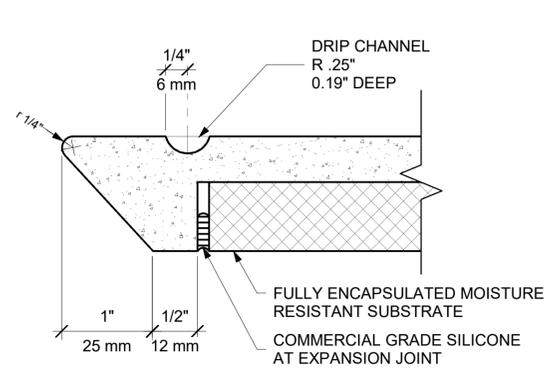


06 CORIAN COUNTERTOP FRONT EDGE AT ICE BIN
Scale: 12" = 1'-0"

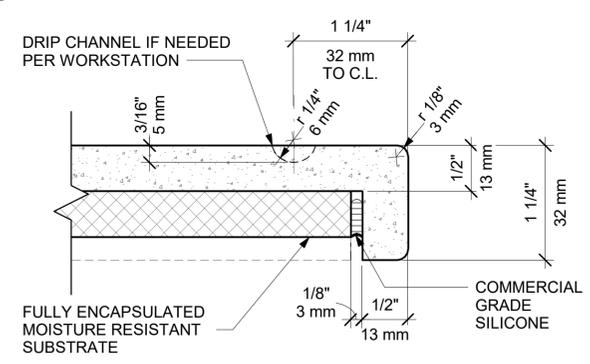


07 CORIAN COUNTERTOP FRONT EDGE
Scale: 12" = 1'-0"

04 CORIAN COUNTERTOP BACKSPLASH AND GROMMET
Scale: 12" = 1'-0"

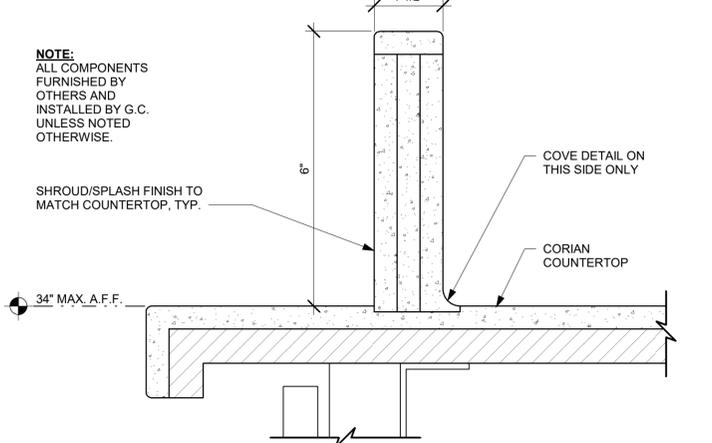


05 CORIAN COUNTERTOP BACKSPLASH AND COVERED GROMMET
Scale: 12" = 1'-0"

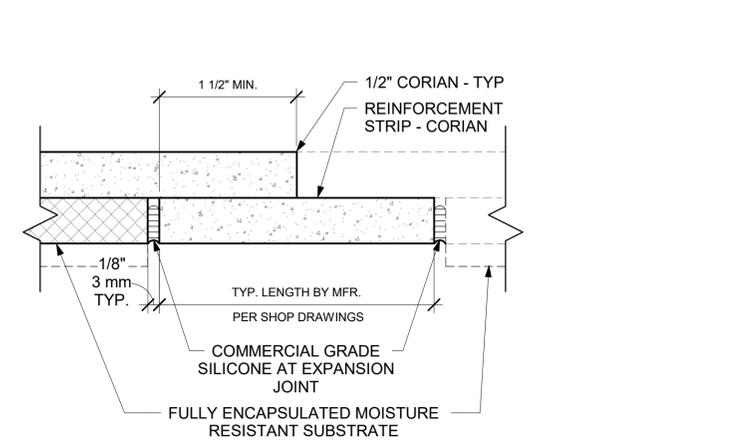

09 CORIAN COUNTERTOP REINFORCEMENT STRIP AT HARD SEAM
Scale: 12" = 1'-0"

08 ESP SHROUD - CORIAN
Scale: 6" = 1'-0"

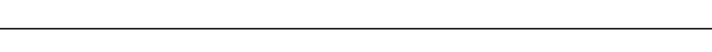

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Revision Schedule			
Rev	Date	By	Description


SHEET TITLE:
CASEWORK DETAILS

SCALE: AS SHOWN

SHEET NUMBER:

1502

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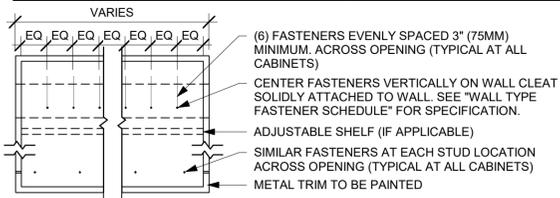


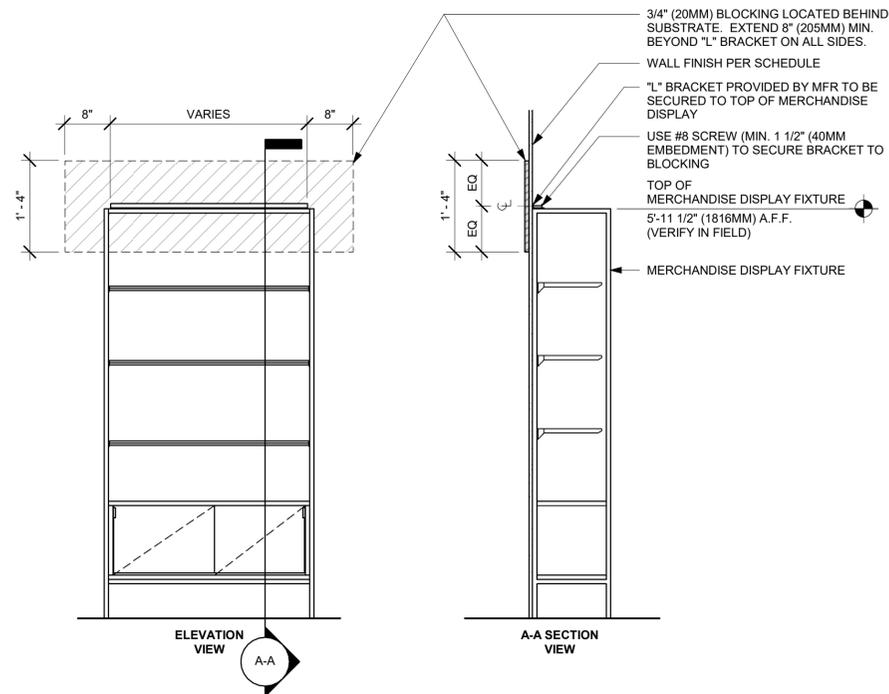01 MERCHANDISE WALL BAY DISPLAY FIXTURE WALL ATTACHMENT
Scale: 3/4" = 1'-0"


WALL TYPE FASTENER SCHEDULE			
WALL TYPE	WALL BLOCKING	FASTENERS	NOTES
WOOD FRAME	X	#8 X3" (75MM) WD OR EQUIVALENT	REFER TO BLOCKING REQUIREMENTS
METAL FRAME	X	#6 CT. X 1 1/4" (30MM) MTLWD OR EQUIVALENT	REFER TO BLOCKING REQUIREMENTS
CMU		MIN. 5/16" X 3" (8MM X 75MM) TAPCON OR EQUIVALENT	SPACE PER DETAIL THIS SHEET
CONCRETE		MIN. 1/4" X 3" (7MM X 75MM) SLEEVE ANCHOR OR EQUIVALENT	SPACE PER DETAIL THIS SHEET
BRICK		MIN. 1/4" X 1" (7MM X 25MM) WEDGE ANCHOR OR EQUIVALENT	SPACE PER DETAIL THIS SHEET AVOID SETTING ANCHORS IN MORTAR JOINTS

STUD WALL BLOCKING REQUIREMENTS:
WOOD STUD WALLS REQUIRE MIN. 2" X 6" (50MM X 150MM) WOOD BLOCKING SECURED FLUSH TO STUD FACE WITH (3) 10D NAILS (OR EQUIVALENT)


METAL STUD WALLS REQUIRE MIN. 2" X 6" (50MM X 150MM) WOOD BLOCKING SECURED FLUSH TO STUD FACE WITH MIN. (3) #6 CT. 1.25" (30MM) SCREWS (OR EQUIVALENT)




04 UPPER CABINET ATTACHMENT
Scale: 1" = 1'-0"

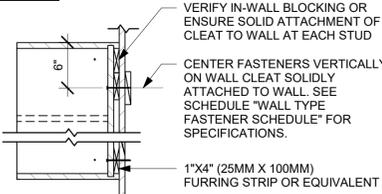


02 METAL TEA AND DRY INCLUSION SHELF WALL ATTACHMENT
Scale: 6" = 1'-0"

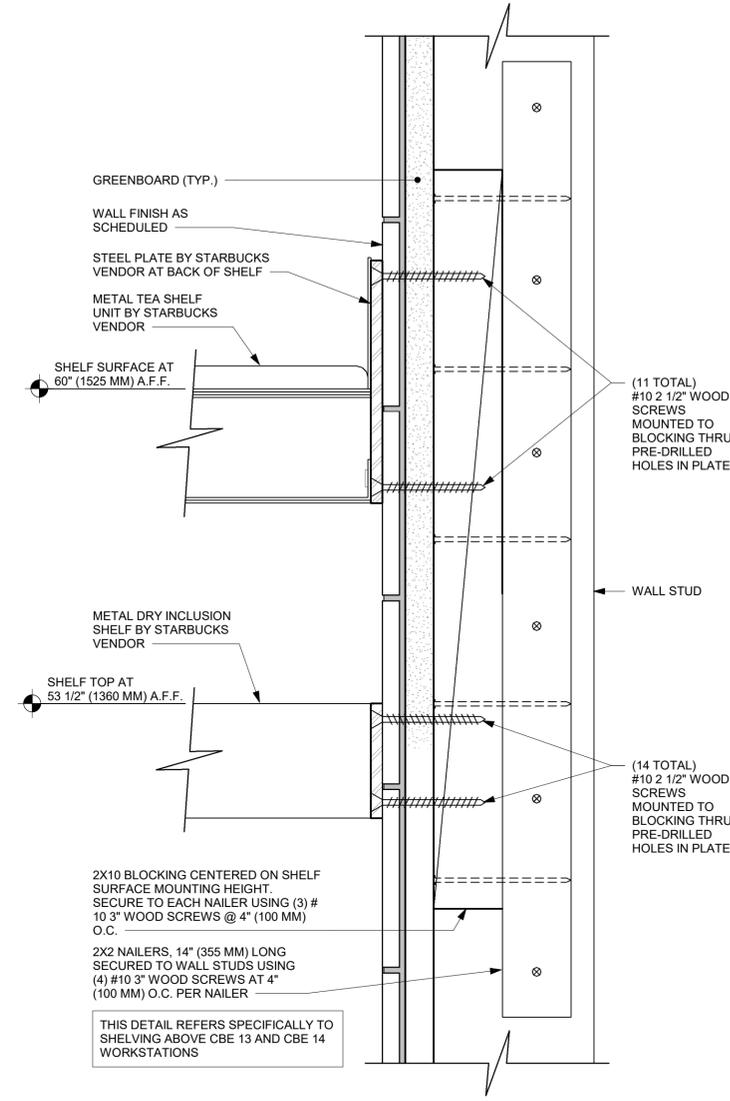


03 FINISH APPLICATION (MAD 200-V) ROUNDED SLAT W/ REVEAL
Scale: 3/4" = 1'-0"

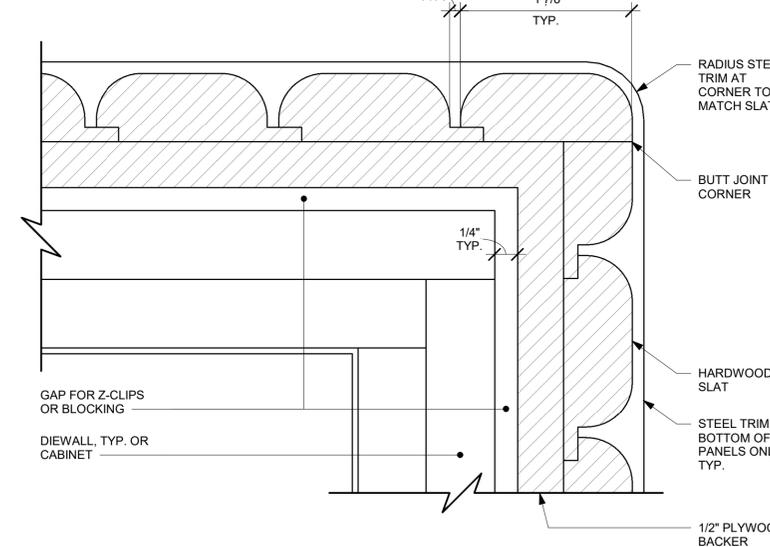



05 ALTERNATE CORNER DETAIL - ROUNDED VERTICAL SLATS
Scale: 12" = 1'-0"

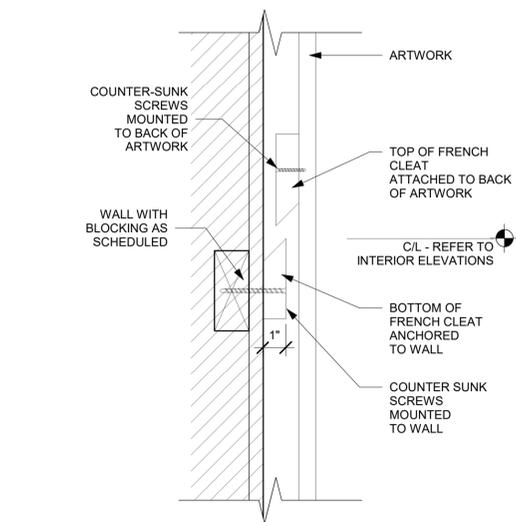

06 FRENCH CLEAT - ARTWORK MOUNT
Scale: 3" = 1'-0"

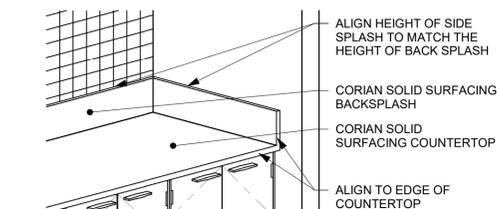

07 CORIAN SIDE SPLASH
Scale: 1/2" = 1'-0"

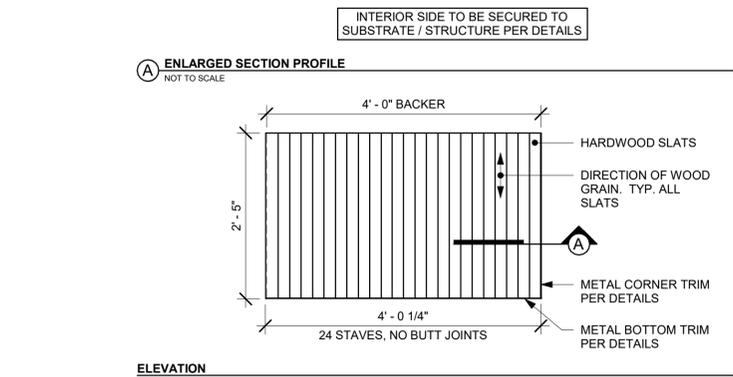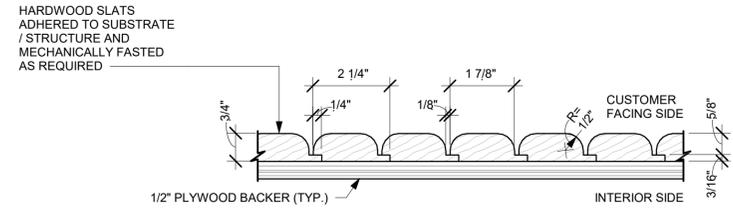

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PROJECT NAME:
A1A & 10TH

PROJECT ADDRESS:
**975 3RD STREET SOUTH
JACKSONVILLE BEACH, FL
32250**

STORE #: 8565
PROJECT #: 18756-108
ISSUE DATE: 03-27-2024
DESIGN MANAGER: ROMINA VIGNOLO
PRODUCTION DESIGNER: GENSLER
CHECKED BY: GENSLER

Revision Schedule			
Rev	Date	By	Description


SHEET TITLE:
CASEWORK DETAILS

SCALE: AS SHOWN


SHEET NUMBER:
1503

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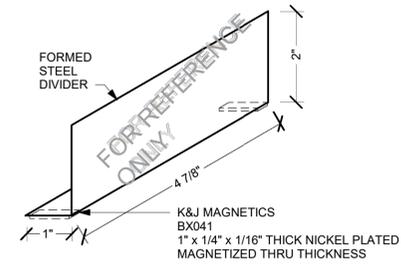
SBUX STANDARD DETAILS
REFER TO I102 FOR PLAN LOCATION

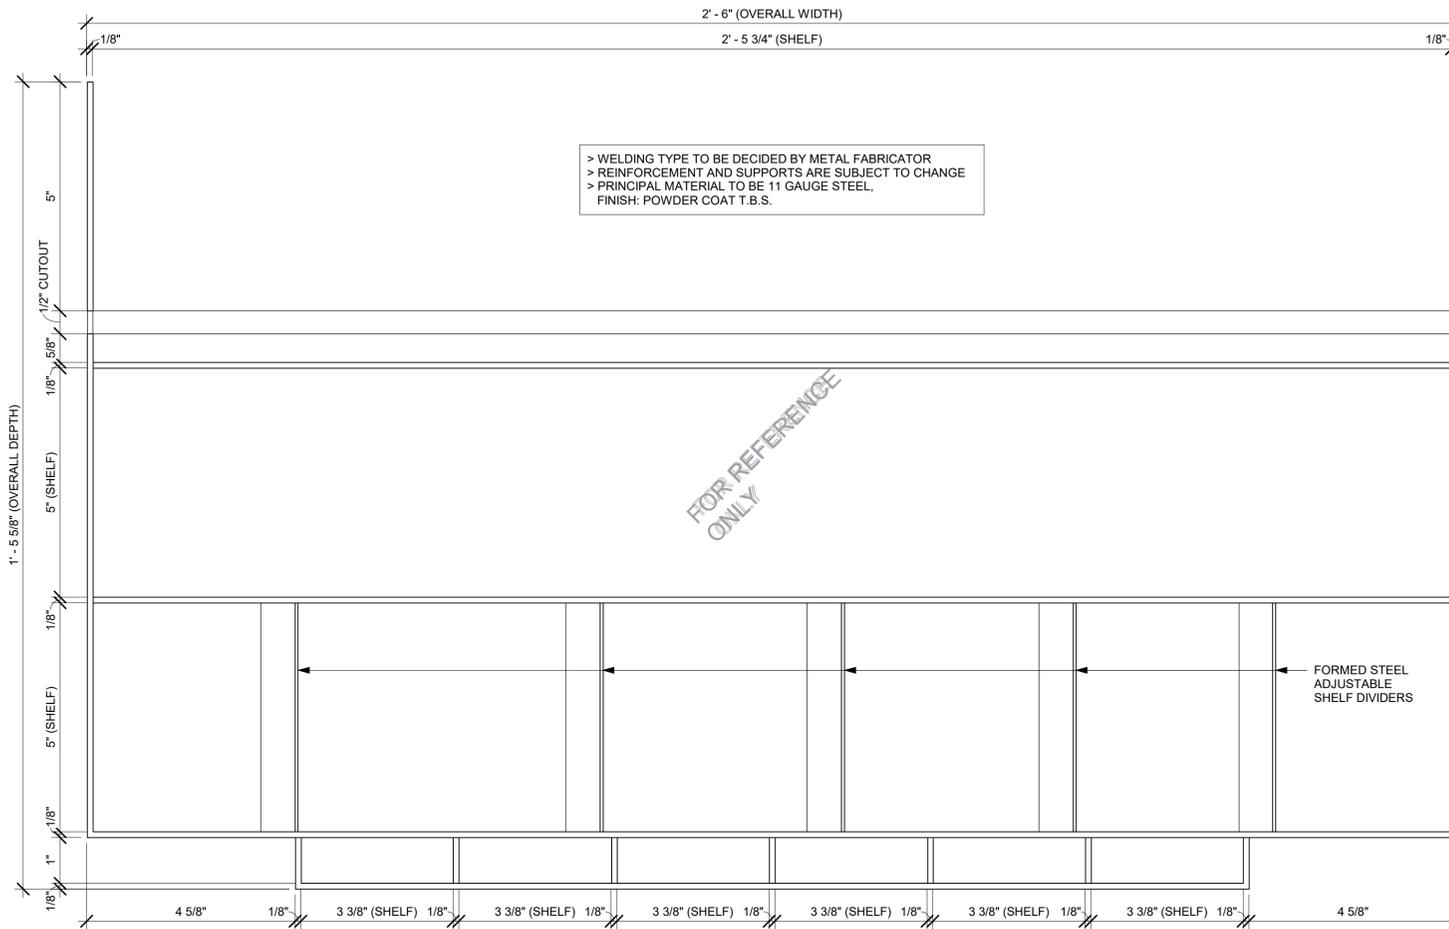


IMPULSE FIXTURE PLAN

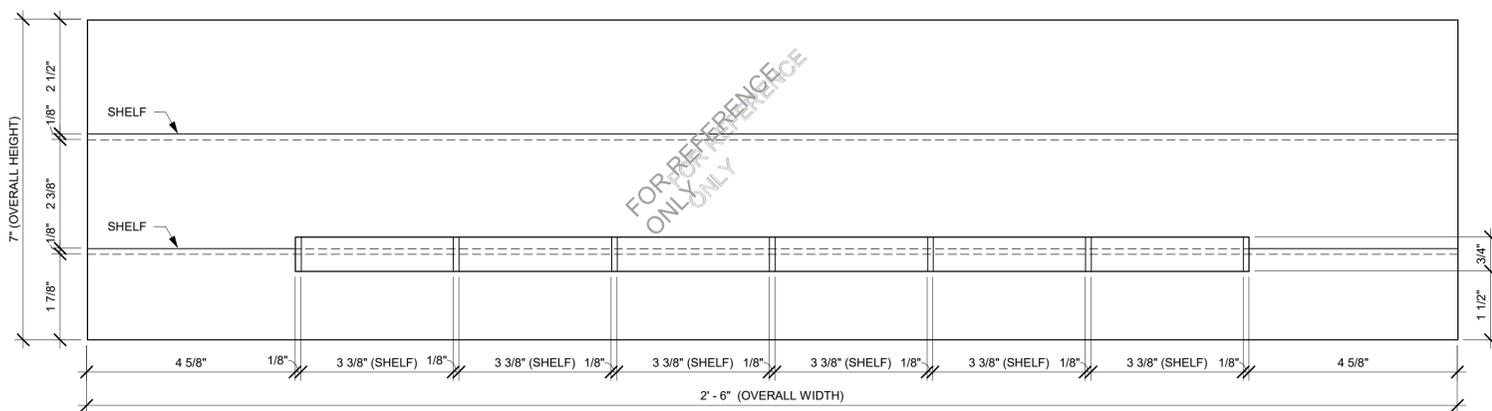


IMPULSE FIXTURE ELEVATION



TYPICAL ADJUSTABLE SHELF DIVIDER ISOMETRIC

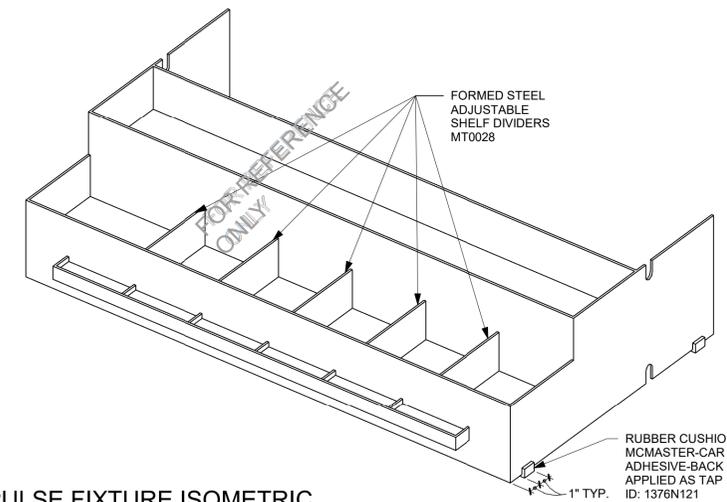

IMPULSE FIXTURE ISOMETRIC

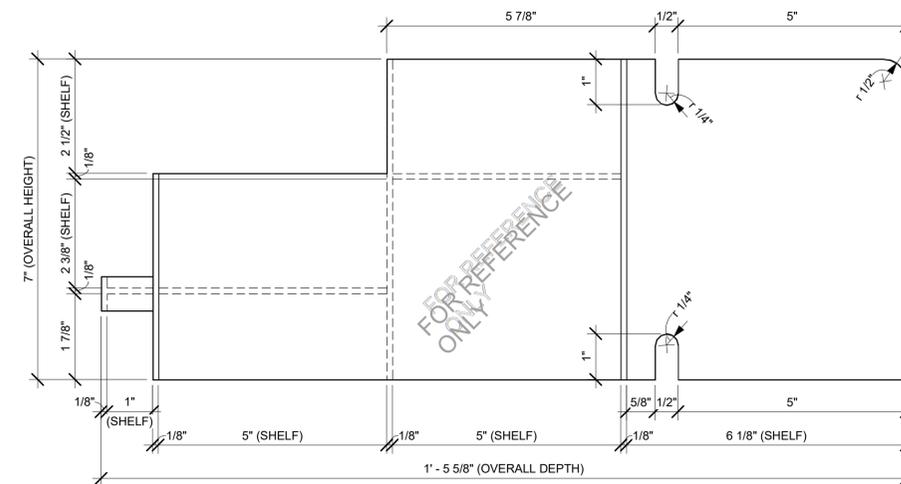

IMPULSE FIXTURE SECTION

01 CUSTOM IMPULSE FIXTURE
Scale: 6" = 1'-0"



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PROJECT #: 18756-108
ISSUE DATE: 03-27-2024
DESIGN MANAGER: ROMINA VIGNOLO
PRODUCTION DESIGNER: GENSLER
CHECKED BY: GENSLER

Revision Schedule			
Rev	Date	By	Description

SHEET TITLE:
**IMPULSE FIXTURE
DETAILS**
SCALE: AS SHOWN

SHEET NUMBER:
1504

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STORE #: 8565
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PRODUCTION DESIGNER: GENSLER
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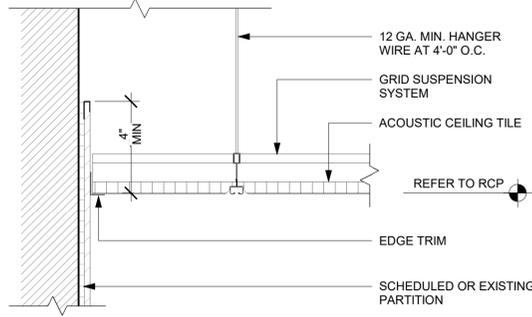
Revision Schedule			
Rev	Date	By	Description

SHEET TITLE:
RCP DETAILS


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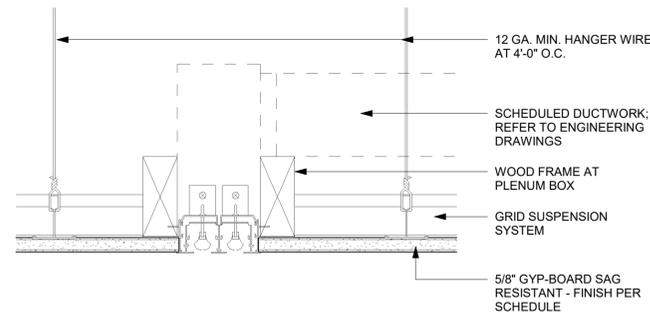
PERMIT SET - FOR CONSTRUCTION USE




01 ACT CEILING AT POLYWALL
Scale: 3" = 1'-0"




02 HEADER AT DT BUMP
Scale: 1 1/2" = 1'-0"

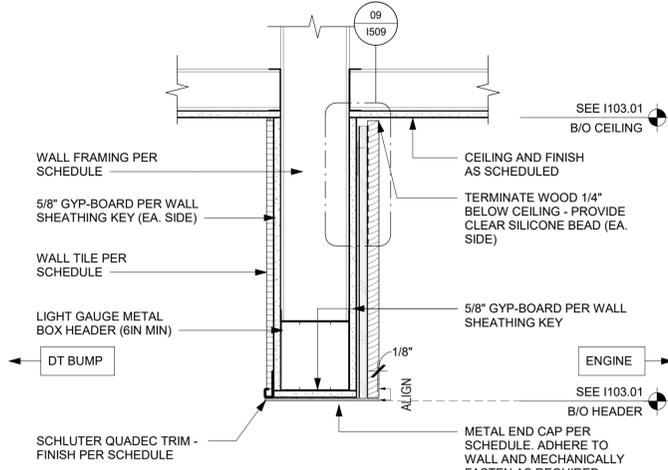


03 LINEAR DIFFUSER @ GYPSUM
Scale: 3" = 1'-0"

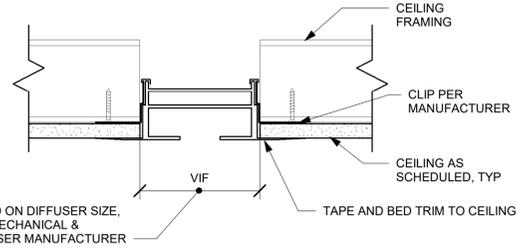


04 ENLARGED LINEAR DIFFUSER SECTION
Scale: 3" = 1'-0"

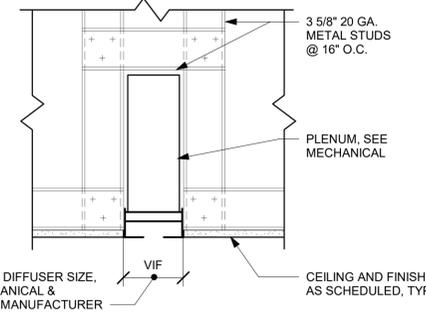


05 LINEAR DIFFUSER SECTION
Scale: 1 1/2" = 1'-0"

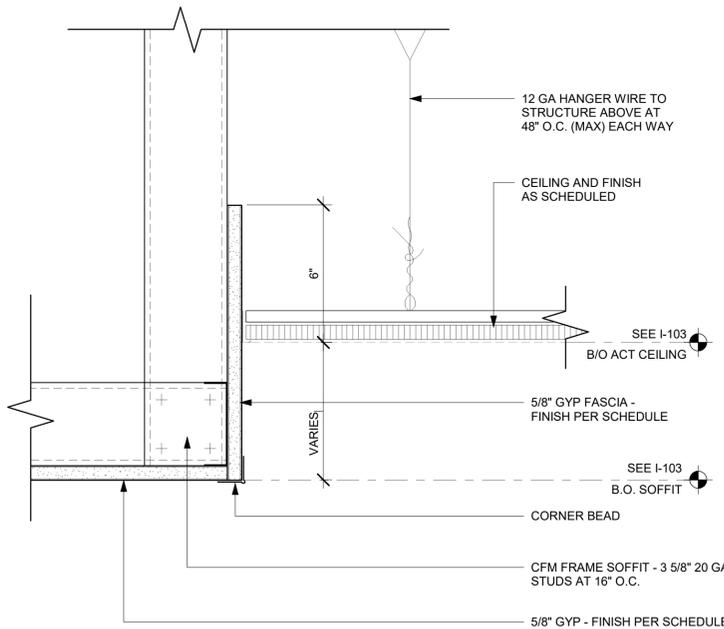


06 ACT CEILING TRANSITION AT CAFE
Scale: 3" = 1'-0"

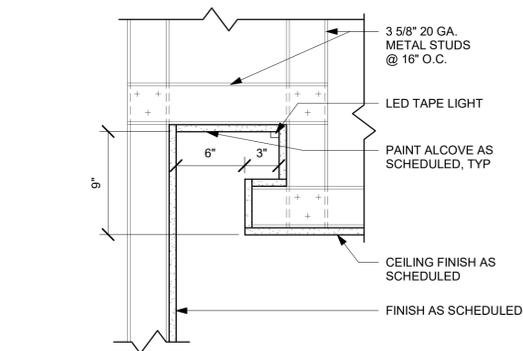


07 LED TAPE LIGHT COVE ABOVE SEATING
Scale: 1 1/2" = 1'-0"

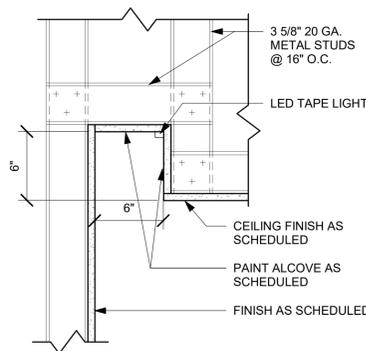

08 LED TAPE LIGHT COVE
Scale: 1 1/2" = 1'-0"

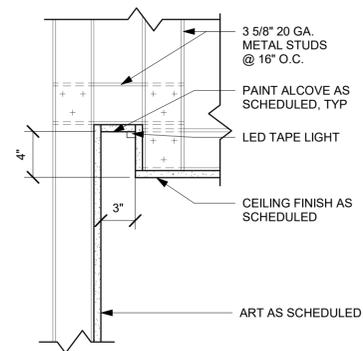


09 LIGHT COVE AT ARTWORK
Scale: 1 1/2" = 1'-0"

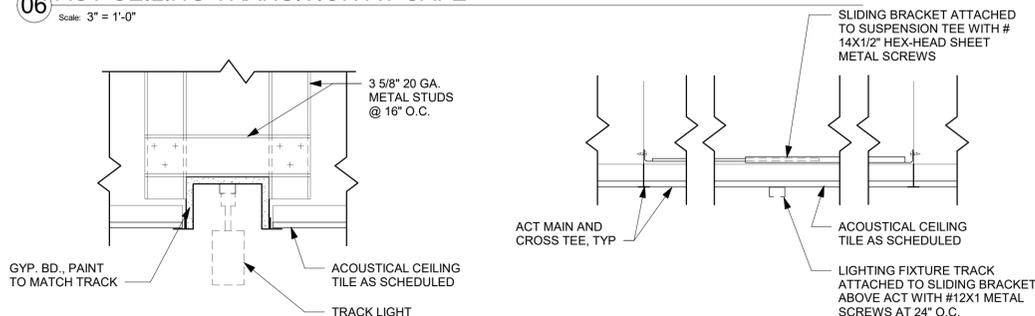


10 TRACK OPTION - COVE
Scale: 1 1/2" = 1'-0"


11 TRACK OPTION - SURFACE MOUNTED
Scale: 1 1/2" = 1'-0"

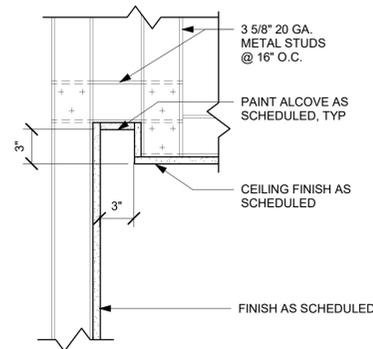

12 SHADOW GAP
Scale: 1 1/2" = 1'-0"

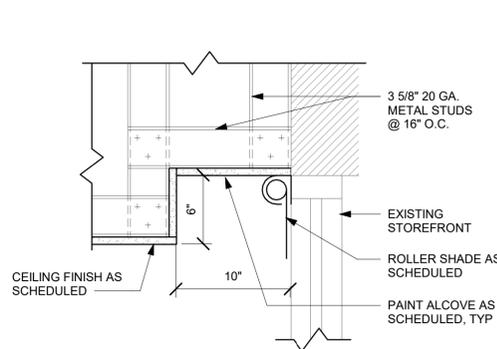

13 ROLLER SHADE COVE
Scale: 1 1/2" = 1'-0"

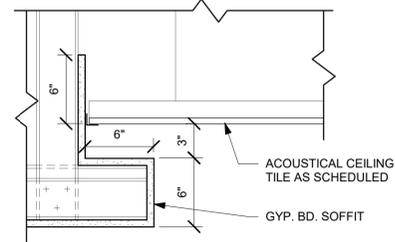

14 ACT OPTION - STRAIGHT EDGE
Scale: 1 1/2" = 1'-0"



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STORE #: 8565
PROJECT #: 18756-108
ISSUE DATE: 03-27-2024
DESIGN MANAGER: ROMINA VIGNOLO
PRODUCTION DESIGNER: GENSLER
CHECKED BY: GENSLER


Revision Schedule			
Rev	Date	By	Description

SHEET TITLE:
RCP DETAILS


SCALE: AS SHOWN

SHEET NUMBER:
1506

PERMIT SET - FOR CONSTRUCTION USE

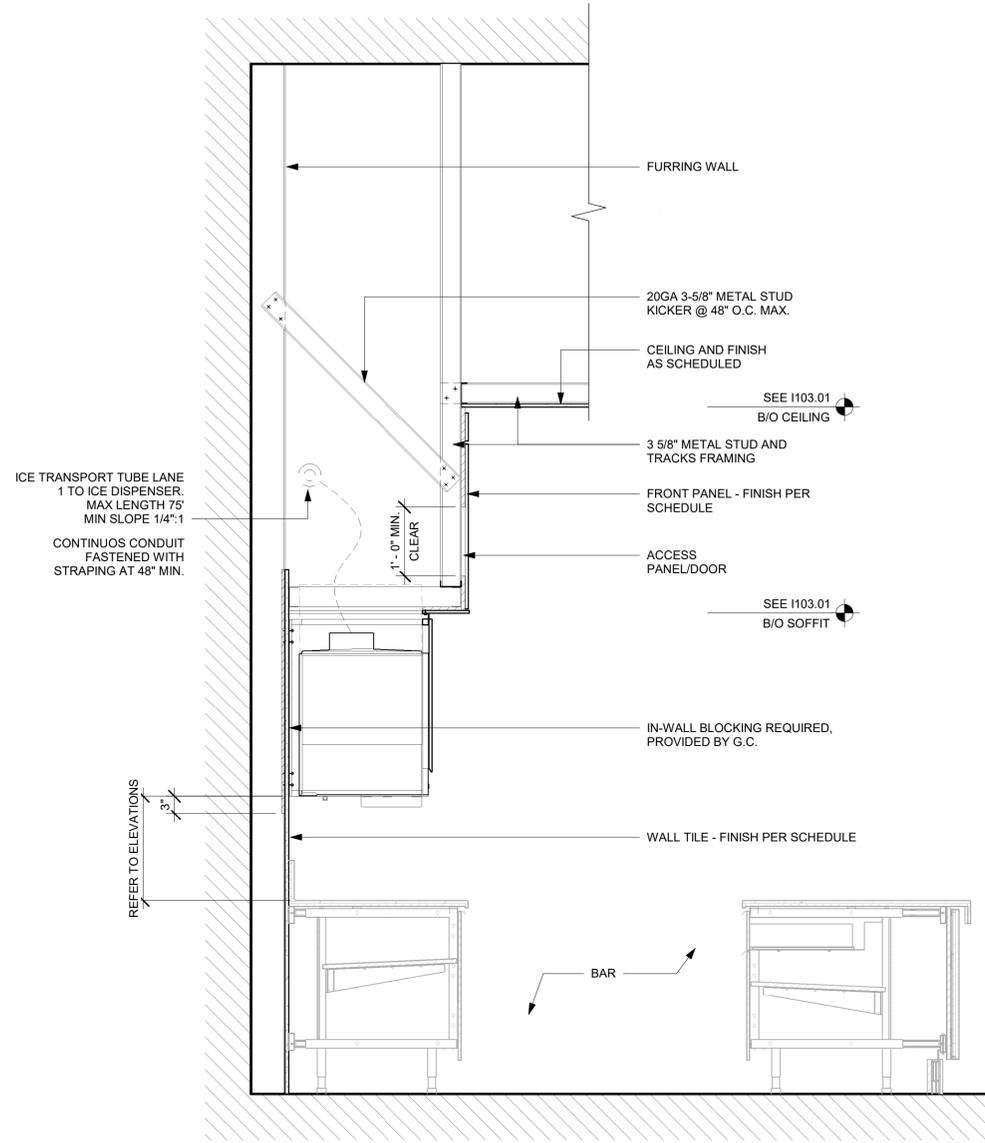

01 SOFFIT AT UPPER CABINET AT CBE
Scale: 3/4" = 1'-0"

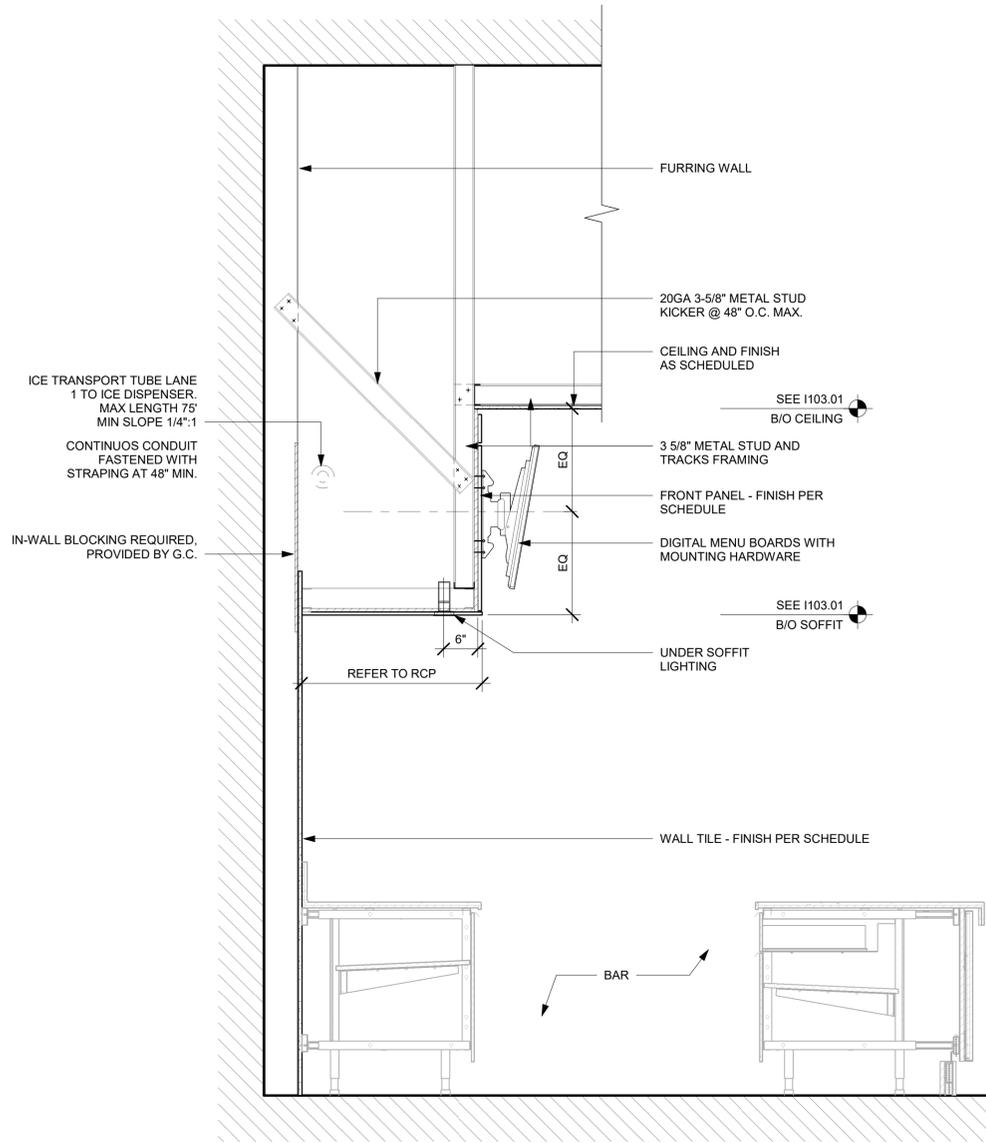

02 SOFFIT AT MENU BOARDS
Scale: 3/4" = 1'-0"



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Revision Schedule			
Rev	Date	By	Description


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FLOOR FINISH DETAILS

SCALE: AS SHOWN

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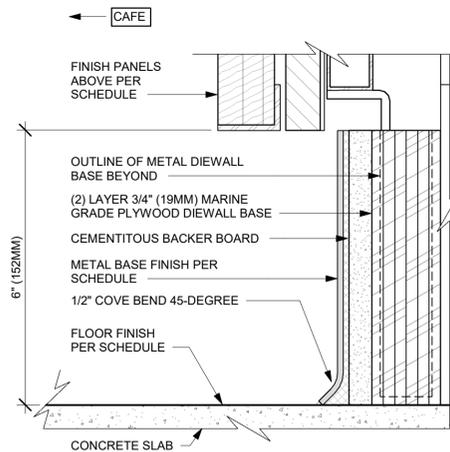
1507

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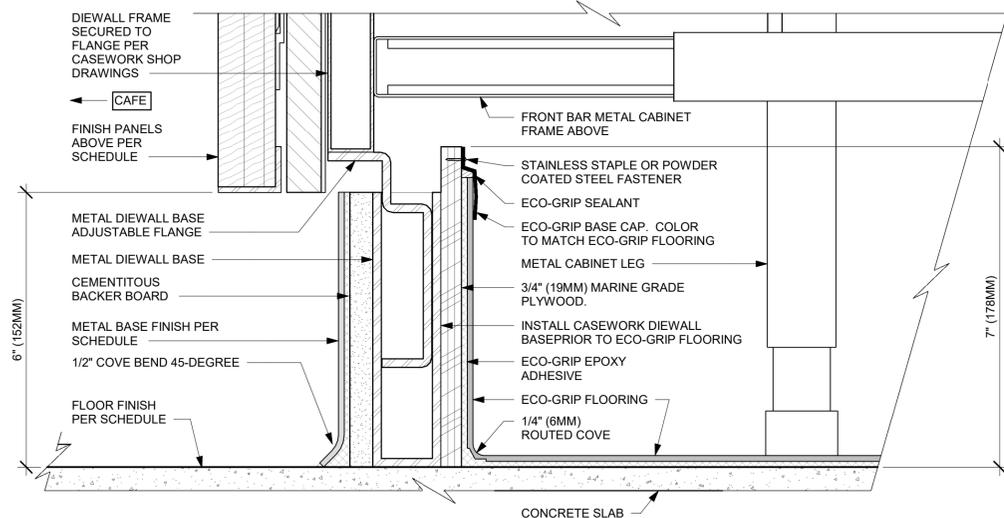
01 AC FRONT BAR DIEWALL METAL TO WOOD BASE TRANSITION

Scale: 1 1/2" = 1'-0"

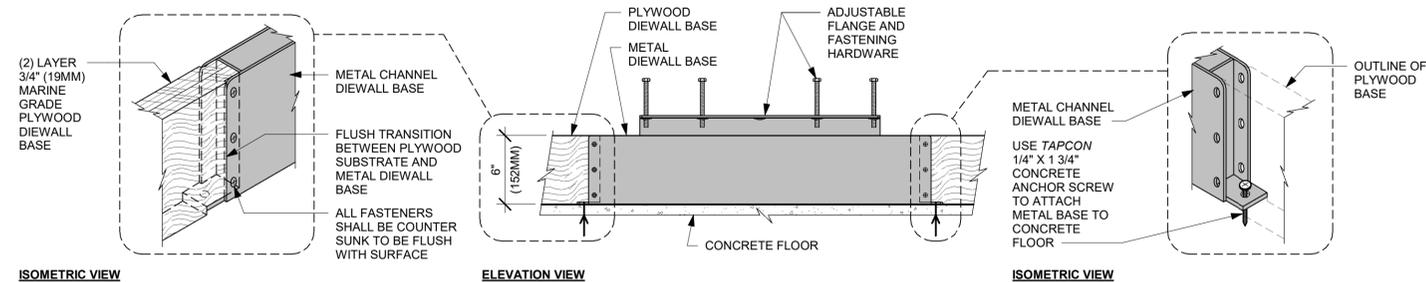


02 AC FRONT BAR CABINET PLYWOOD DIEWALL BASE

Scale: 6" = 1'-0"




03 ECO-GRIP AC FRONT BAR CABINET ON LEGS

Scale: 6" = 1'-0"

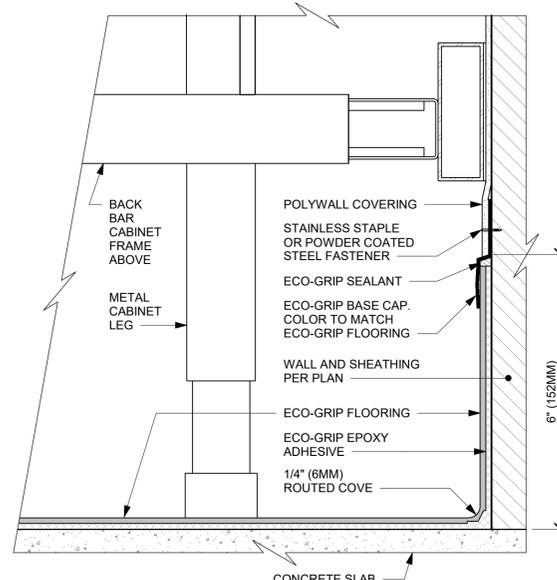


04 ECO-GRIP AC BACK BAR CABINET ON LEGS

Scale: 6" = 1'-0"

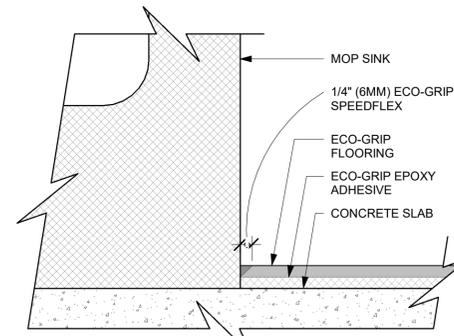


05 ECO-GRIP AT MOP SINK

Scale: 12" = 1'-0"

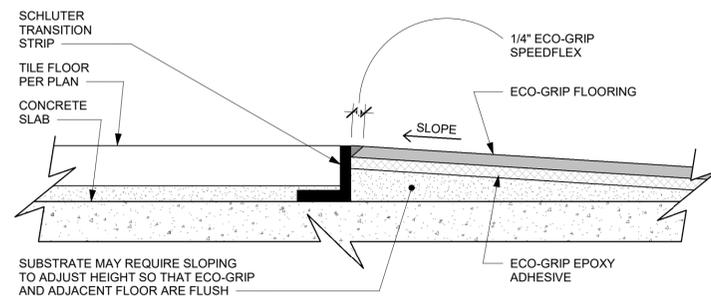


06 ECO-GRIP TO TILE TRANSITION (FIXTURES & EQUIPMENT)

Scale: 12" = 1'-0"

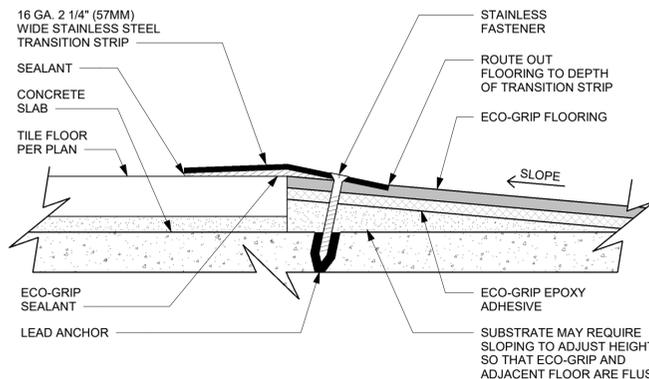


07 ECO-GRIP TO TILE TRANSITION AT FOOT TRAFFIC AREA

Scale: 12" = 1'-0"

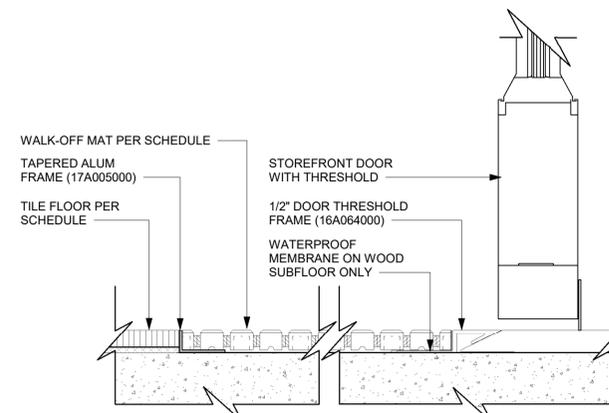


08 TRANSITION - TILE TO WALK OFF MAT - HELIX


Scale: 6" = 1'-0"

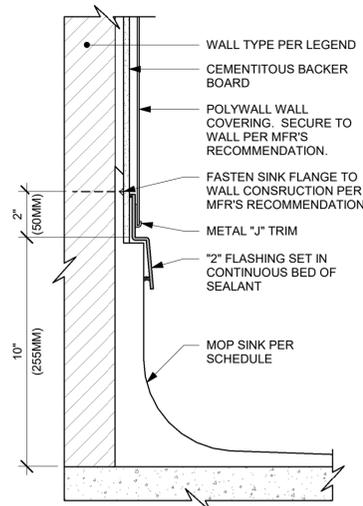


01 MOP SINK WITH FLANGE
Scale: 3" = 1'-0"

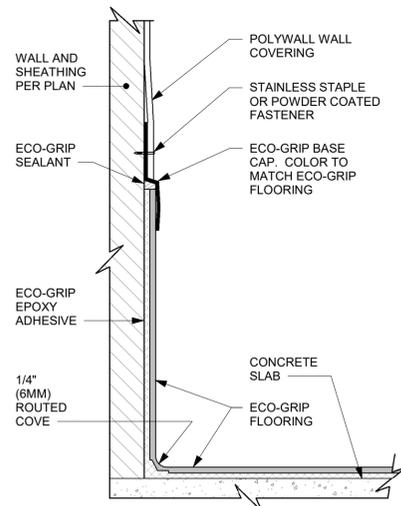


02 ECO-GRIP BASE CAP WITH POLYWALL
Scale: 6" = 1'-0"

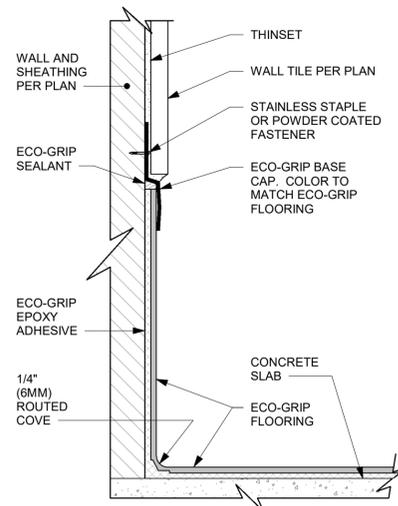


03 ECO-GRIP BASE CAP WITH TILED WALL
Scale: 6" = 1'-0"

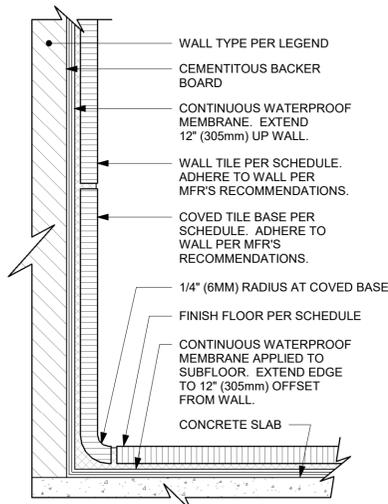


09 INTEGRAL TILE BASE AT TILED WALL
Scale: 6" = 1'-0"

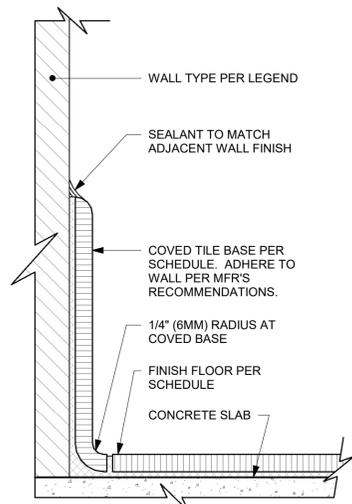


10 INTEGRAL TILE BASE AT WALL
Scale: 6" = 1'-0"

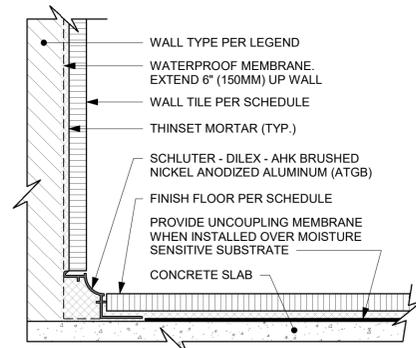

11 WALL TILE TO FLOOR TILE TRANSITION
Scale: 6" = 1'-0"

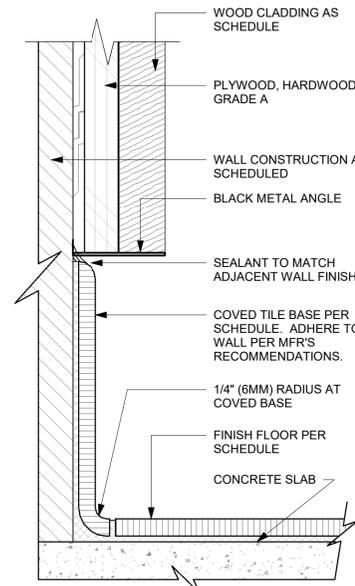

12 TOP SET - TILE BASE AT WOOD WALL
Scale: 6" = 1'-0"

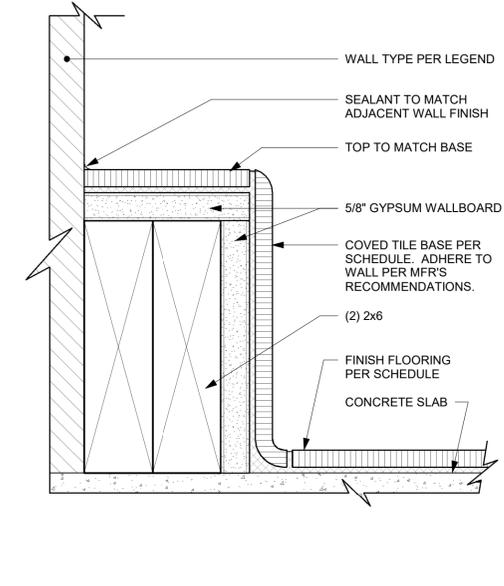

13 WALL PROTECTION AT ARTWALL
Scale: 6" = 1'-0"



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STARBUCKS TEMPLATE VERSION: i2024.01.01

PABLO GARCIA, AIA, REG. FL. NO. AR99297

Gensler

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PROJECT NAME:
A1A & 10TH

PROJECT ADDRESS:
**975 3RD STREET SOUTH
JACKSONVILLE BEACH, FL
32250**

STORE #: 8565
PROJECT #: 18756-108
ISSUE DATE: 03-27-2024
DESIGN MANAGER: ROMINA VIGNOLO
PRODUCTION DESIGNER: GENSLER
CHECKED BY: GENSLER

Revision Schedule			
Rev	Date	By	Description


SHEET TITLE:
FLOOR FINISH DETAILS

SCALE: AS SHOWN


SHEET NUMBER:

1508


PERMIT SET - FOR CONSTRUCTION USE

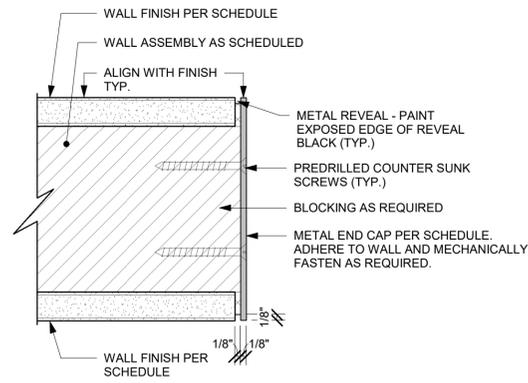


01 METAL TRIM AT BOH & ENGINE OPENING
Scale: 6" = 1'-0"

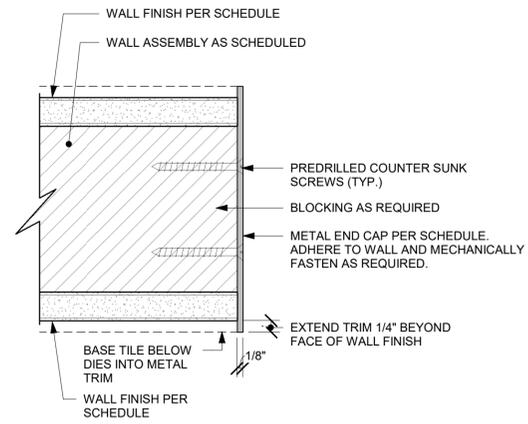


02 METAL TRIM AT RESTROOM VESTIBULE OPENING
Scale: 6" = 1'-0"

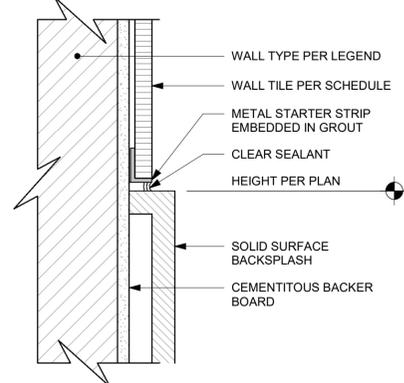


03 SS BACKSPLASH TO TILE TRANSITION
Scale: 6" = 1'-0"

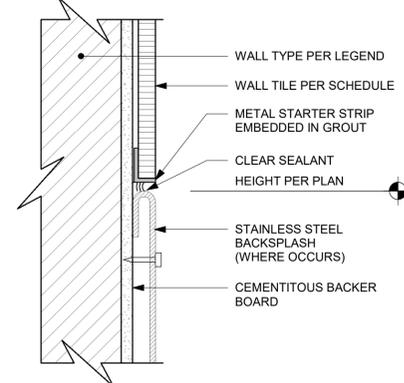


04 SS BACKSPLASH TO TILE TRANSITION
Scale: 6" = 1'-0"

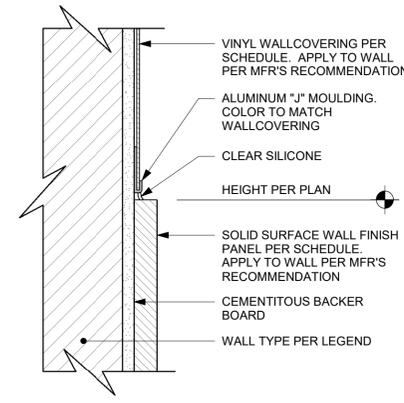


05 SS PANEL TO VINYL TRANSITION
Scale: 6" = 1'-0"

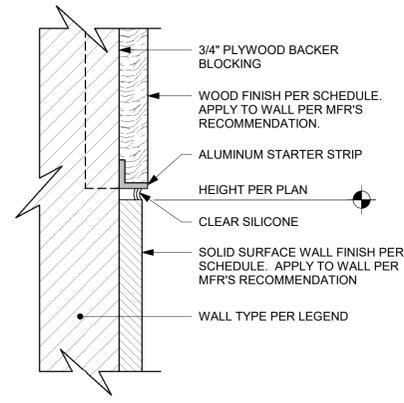


06 SS WALL TO WOOD TRANSITION
Scale: 6" = 1'-0"

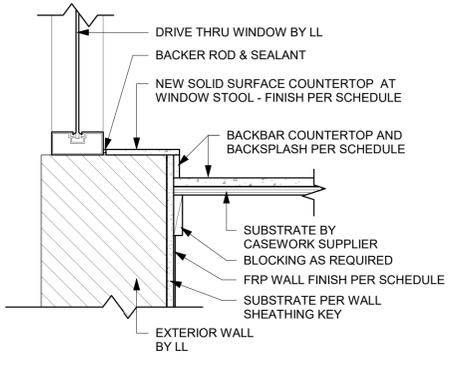


07 FINISH DETAIL AT BACKBAR SILL
Scale: 1 1/2" = 1'-0"

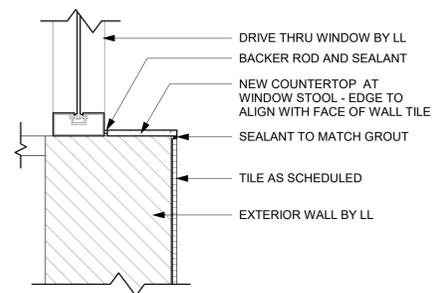


08 FINISH DETAIL AT DT SILL
Scale: 1 1/2" = 1'-0"

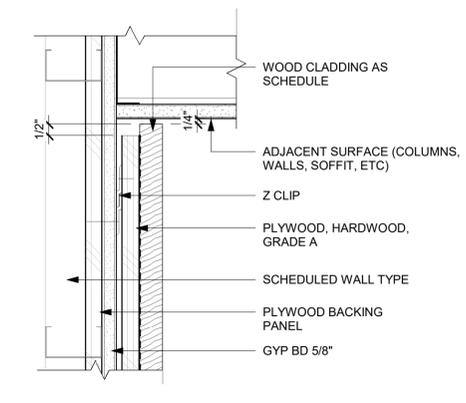


09 WOOD CLADDING WALL - SECTION
Scale: 3" = 1'-0"

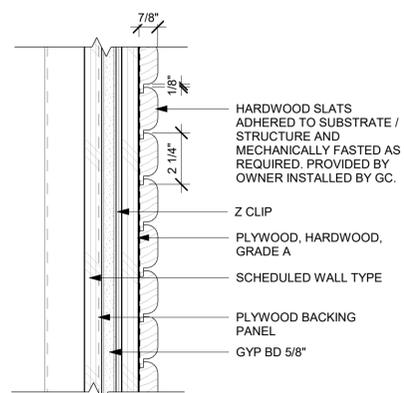


10 WOOD CLADDING WALL - TOP VIEW
Scale: 3" = 1'-0"

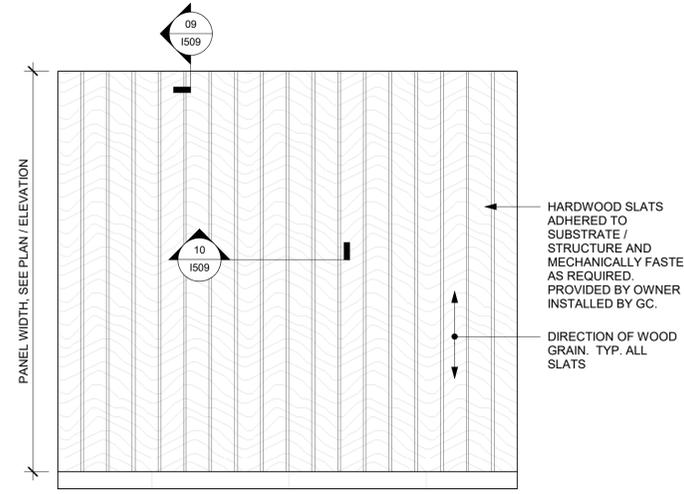

11 WOOD CLADDING WALL ELEVATION
Scale: 1 1/2" = 1'-0"

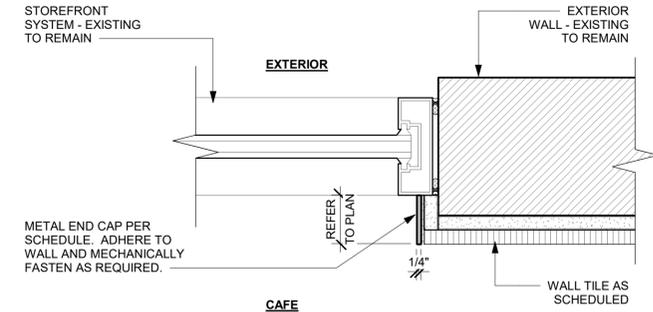

12 WINDOW JAMB WITH METAL TRIM AT TILE
Scale: 3" = 1'-0"

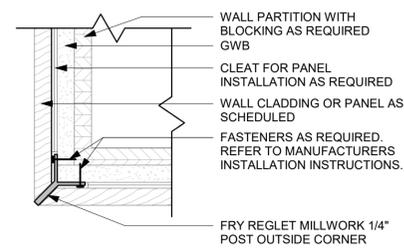

13 Y-TRIM DETAIL - WOOD
Scale: 3" = 1'-0"



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PRODUCTION DESIGNER: GENSLER
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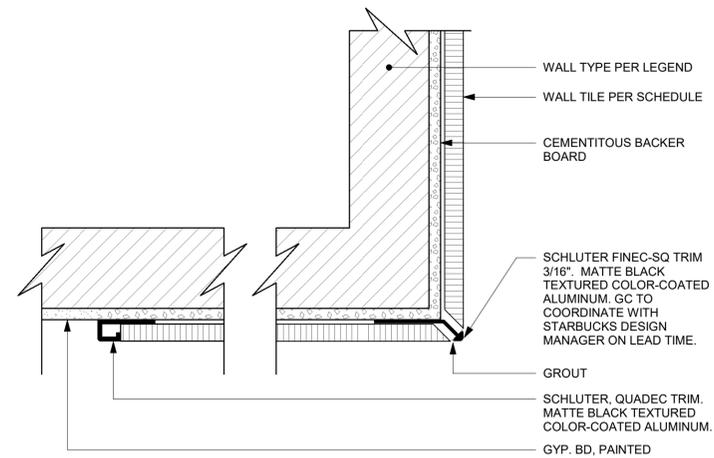
Revision Schedule			
Rev	Date	By	Description

SHEET TITLE:
WALL FINISH DETAILS


SCALE: AS SHOWN

SHEET NUMBER:
1509


PERMIT SET - FOR CONSTRUCTION USE




01 SCHLUTER DETAIL AT TILE CORNER & EDGE
Scale: 6" = 1'-0"

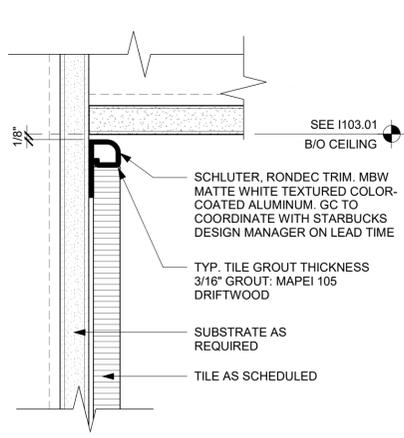


02 TILE TOP TRIM AT CEILING TRANSITION
Scale: 6" = 1'-0"

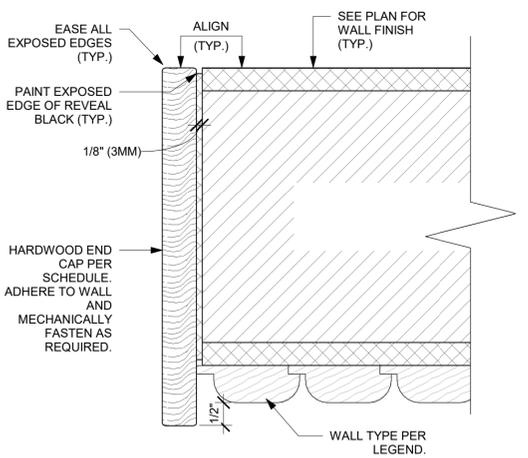


03 WALL WOOD END CAP AT WOOD WALL
Scale: 6" = 1'-0"

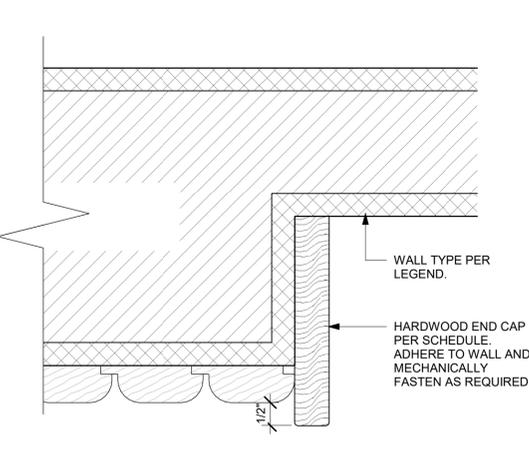


04 TILE TO PAINT TRANSITION
Scale: 6" = 1'-0"

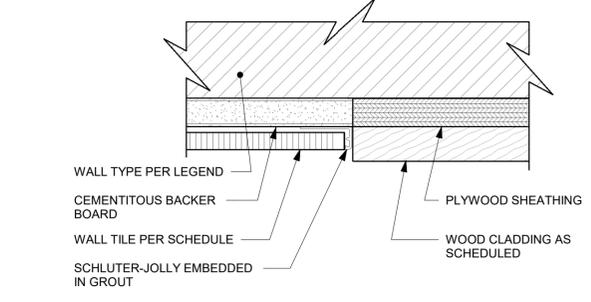


05 TILE TO WOOD TRANSITION
Scale: 6" = 1'-0"

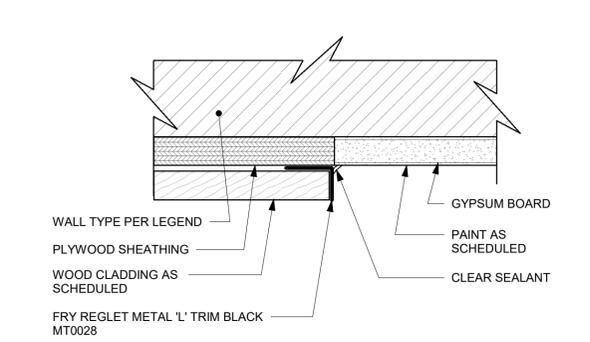


06 WOOD TO PAINT TRANSITION
Scale: 6" = 1'-0"

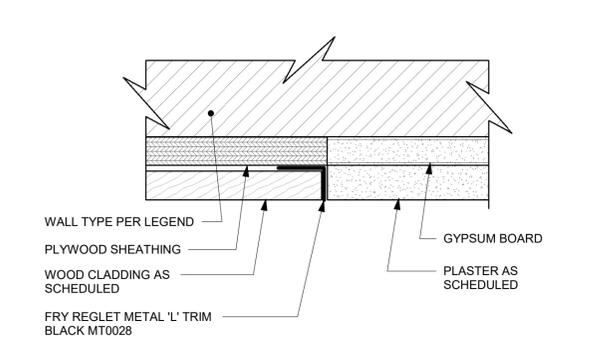


07 WOOD TO PLASTER TRANSITION
Scale: 6" = 1'-0"

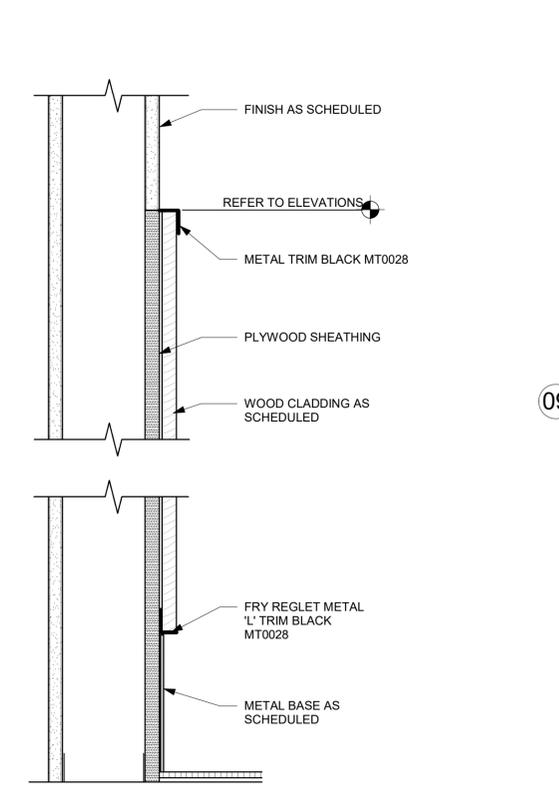


08 WOOD WAINSCOT TRIM SECTION
Scale: 3" = 1'-0"

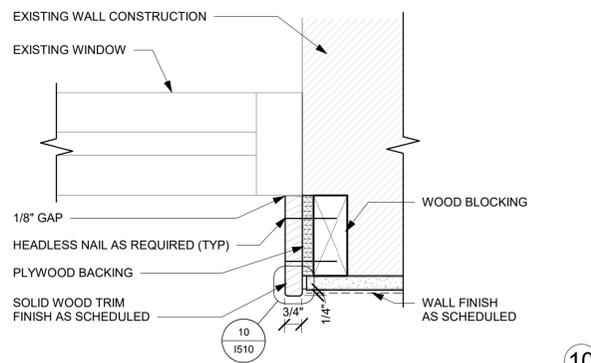


09 WOOD TRIM AT WINDOW
Scale: 3" = 1'-0"

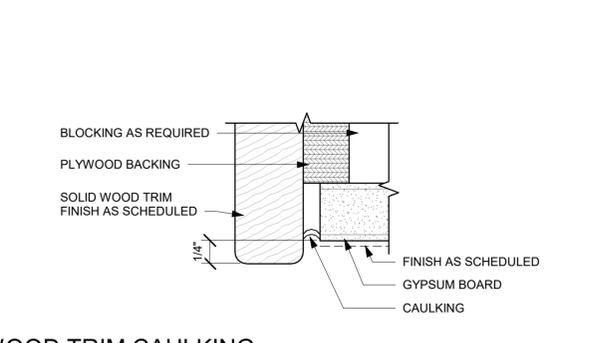


10 WOOD TRIM CAULKING
Scale: 12" = 1'-0"

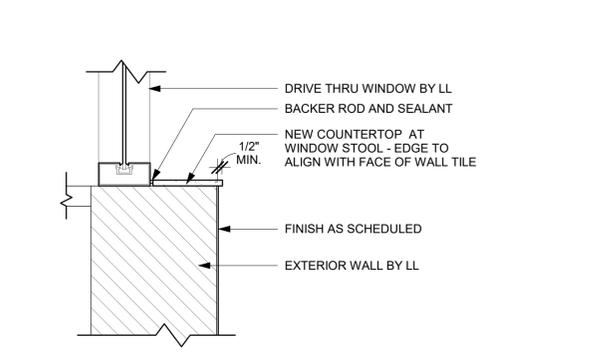


11 FINISH DETAIL AT CAFE SILL
Scale: 1 1/2" = 1'-0"

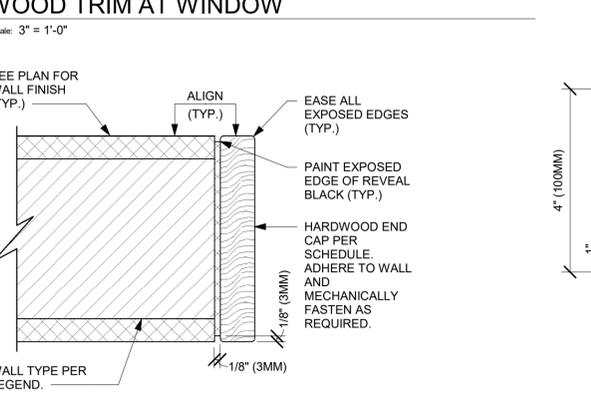

12 WALL WOOD END CAP
Scale: 6" = 1'-0"

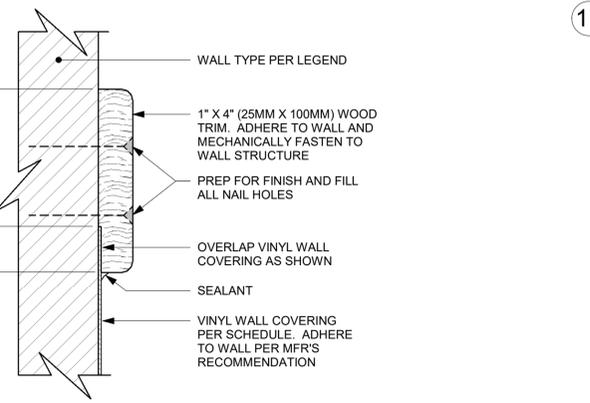

13 VINYL TO WOOD SLAT TRANSITION
Scale: 6" = 1'-0"

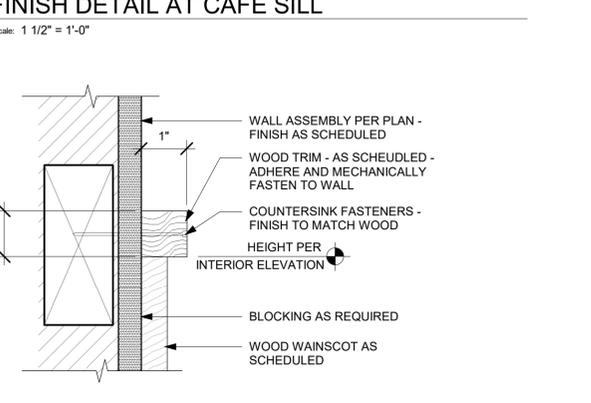

14 CHAIR RAIL
Scale: 6" = 1'-0"



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PRODUCTION DESIGNER: GENSLER
CHECKED BY: GENSLER

Revision Schedule			
Rev	Date	By	Description

SHEET TITLE:
WALL FINISH DETAILS

SCALE: AS SHOWN

SHEET NUMBER:
1510

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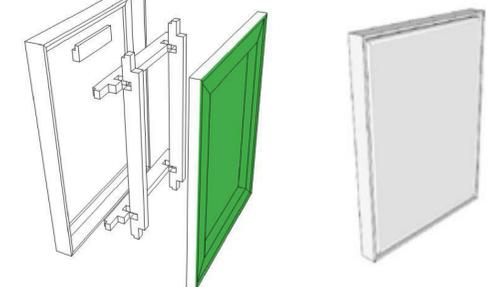
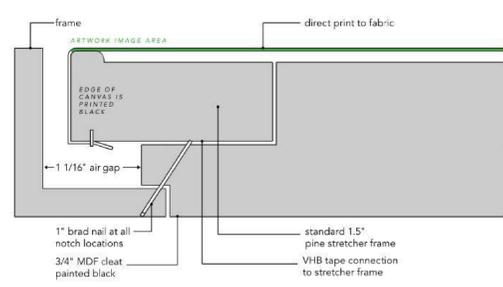
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ARTWORK

SCALE: AS SHOWN

SHEET NUMBER:
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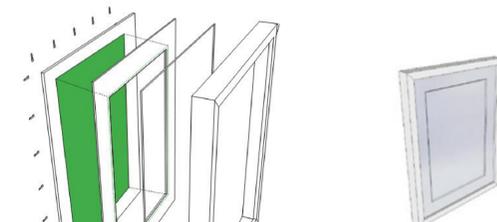
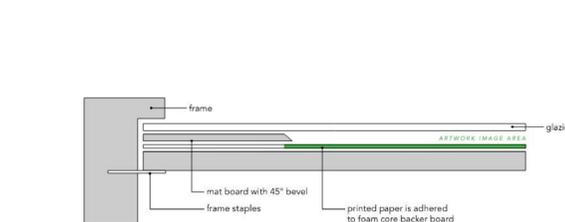
PERMIT SET - FOR CONSTRUCTION USE

GRAPHICS AND ARTWORK SCHEDULE - "G"					
DESIGN ID	COUNT	DESCRIPTION	FURN. BY	INST. BY	COMMENTS
GRAPHICS - ARTWORK					
X0001	1	ARTWORK DID: 23246 - RIPENING COFFEE STILL LIFE - ART SIZE: 3' - 11"W X 3' - 11"H - OVERALL SIZE 4' - 0"W X 4' - 0"H.	SB	GC	WRAPPED CANVAS IN FLOAT FRAME WITH 1/4" SPACER PRINTED ON: CANVAS 1: FISHER TEXTILES GF 4394 ART CANVAS FRAME FINISH: FRAME 4A LARSON-JUHL GALLERY ONE 220940 BLACK
X0002	1	ARTWORK DID: 16969 - COLOMBIA 9-BW - ART SIZE 1' - 2"W X 1' - 5 1/2"H - OVERALL SIZE 1' - 7 1/2"W X 2' - 3"H.	SB	GC	WRAPPED CANVAS IN FLOAT FRAME WITH 1/4" SPACER PRINTED ON: CANVAS 1: FISHER TEXTILES GF 4394 ART CANVAS FRAME FINISH: FRAME 4A LARSON-JUHL GALLERY ONE 220940 BLACK
X0003	1	ARTWORK DID: 19830 - CHIAPAS 4-BW - ART SIZE 1' - 2"W X 1' - 5 1/2"H - OVERALL SIZE 1' - 7 1/2"W X 2' - 3"H.	SB	GC	WRAPPED CANVAS IN FLOAT FRAME WITH 1/4" SPACER PRINTED ON: CANVAS 1: FISHER TEXTILES GF 4394 ART CANVAS FRAME FINISH: FRAME 4A LARSON-JUHL GALLERY ONE 220940 BLACK
X0004	1	ARTWORK DID: 22089 - COSTA RICA 11 - ART SIZE 1' - 2"W X 1' - 5 1/2"H - OVERALL SIZE 1' - 7 1/2"W X 2' - 3"H.	SB	GC	WRAPPED CANVAS IN FLOAT FRAME WITH 1/4" SPACER PRINTED ON: CANVAS 1: FISHER TEXTILES GF 4394 ART CANVAS FRAME FINISH: FRAME 4A LARSON-JUHL GALLERY ONE 220940 BLACK
X0005	1	ARTWORK DID: 16965 - COLOMBIA7-BW - ART SIZE 1' - 2"W X 1' - 5 1/2"H - OVERALL SIZE 1' - 7 1/2"W X 2' - 3"H.	SB	GC	WRAPPED CANVAS IN FLOAT FRAME WITH 1/4" SPACER PRINTED ON: CANVAS 1: FISHER TEXTILES GF 4394 ART CANVAS FRAME FINISH: FRAME 4A LARSON-JUHL GALLERY ONE 220940 BLACK
X0006	1	ARTWORK DID: 22135 - GUATEMALA 1-BW - ART SIZE 1' - 2"W X 1' - 5 1/2"H - OVERALL SIZE 1' - 7 1/2"W X 2' - 3"H.	SB	GC	WRAPPED CANVAS IN FLOAT FRAME WITH 1/4" SPACER PRINTED ON: CANVAS 1: FISHER TEXTILES GF 4394 ART CANVAS FRAME FINISH: FRAME 4A LARSON-JUHL GALLERY ONE 220940 BLACK
X0007	1	COMMUNITY BOARD WITH 3" FRAME MAGNETIC MEDIUM WARM BROWN; OVERALL SIZE: 3' - 10" W X 3' - 0" H	SB	GC	WRAPPED CANVAS IN FLOAT FRAME WITH 1/4" SPACER PRINTED ON: CANVAS 1: FISHER TEXTILES GF 4394 ART CANVAS FRAME FINISH: FRAME 4A LARSON-JUHL GALLERY ONE 220940 BLACK
X0008	1	ARTWORK DID: 16780 - GRAPHITE COFFEE SEEDINGS - ART SIZE 0' - 12 1/2"W X 0' - 12 1/2"H - OVERALL SIZE 1' - 10"W X 1' - 10"H.	SB	GC	WRAPPED CANVAS IN FLOAT FRAME WITH 1/4" SPACER PRINTED ON: CANVAS 1: FISHER TEXTILES GF 4394 ART CANVAS FRAME FINISH: FRAME 4A LARSON-JUHL GALLERY ONE 220940 BLACK
X0009	1	ARTWORK DID: 16785 - GRAPHITE STUDY FLOWER - ART SIZE 0' - 12 1/2"W X 0' - 12 1/2"H - OVERALL SIZE 1' - 10"W X 1' - 10"H.	SB	GC	WRAPPED CANVAS IN FLOAT FRAME WITH 1/4" SPACER PRINTED ON: CANVAS 1: FISHER TEXTILES GF 4394 ART CANVAS FRAME FINISH: FRAME 4A LARSON-JUHL GALLERY ONE 220940 BLACK
X0010	1	ARTWORK DID: 16784 - GRAPHITE STUDY CHERRY - ART SIZE 0' - 12 1/2"W X 0' - 12 1/2"H - OVERALL SIZE 1' - 10"W X 1' - 10"H.	SB	GC	WRAPPED CANVAS IN FLOAT FRAME WITH 1/4" SPACER PRINTED ON: CANVAS 1: FISHER TEXTILES GF 4394 ART CANVAS FRAME FINISH: FRAME 4A LARSON-JUHL GALLERY ONE 220940 BLACK
GRAPHICS - OTHER					
23136	1	AUTOMATIC DOOR CAUTION SIGNAGE			




WRAPPED CANVAS IN FLOAT FRAME

Scale: 1" = 1'-0"



FRAMED & MATTED

Scale: 1" = 1'-0"

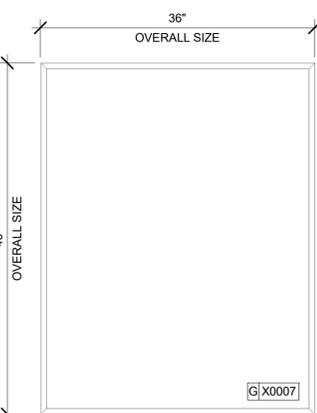


DID: X0007
COMMUNITY BOARD
STARBUCKS ART: VENDOR = COLORCHROME

OVERALL SIZE: 36"W X 46"H
FRAME TYPE: 1A - LARSON - JUHL - CRANBOOK 1 & 2
613677 EBONIZED WALNUT

COMMUNITY BOARD

Scale: 1" = 1'-0"

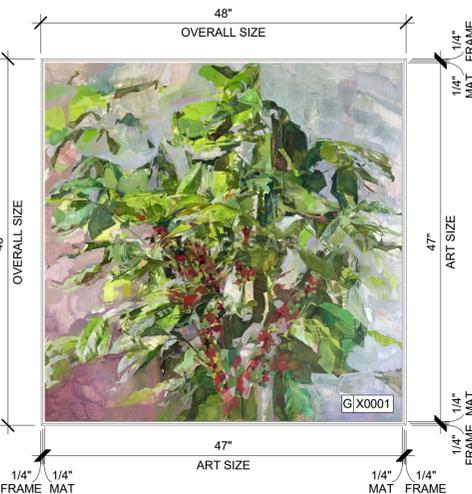


DID: 23246
ARTIST: CHRISTINA WEAVER
TITLE: RIPENING COFFEE STILL LIFE

WRAPPED CANVAS IN FLOAT FRAME
ART SIZE: 47"W X 47"H
REVEAL BETWEEN CANVAS & FRAME: 1/4"
PRINT TO EDGES
OVERALL SIZE: 48"W X 48"H
PRINT EDGES BLACK
CANVAS: 1 - FISHER TEXTILES GF 4394 ART CANVAS
FRAME TYPE: 3C - LARSON-JUHL -CRANBROOK 1 & 2 - 623674 EBONIZED WALNUT

ARTWORK AT WOODCLADDING

Scale: 1" = 1'-0"

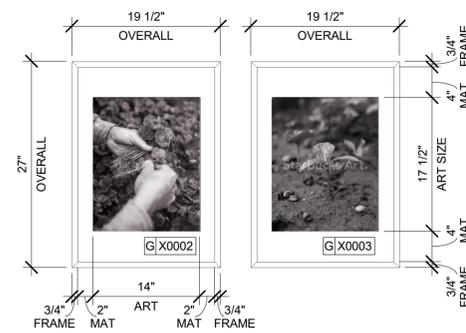

DID: X0002 - 16969
ARTIST: MICHAEL HANSON
TITLE: COLOMBIA 9 - BW

FRAMED WITH MAT
ART SIZE: 14"W X 17 1/2"H
REVEAL BETWEEN MAT SIZE: 4" T/B - 2" L/R
OVERALL SIZE: 19 1/2"W X 27"H
PAPER: 1 LEXJET - PREMIUM ARCHIVAL MATTE PAPER
MAT: CRESCENT RAGMAT - VERY WHITE 1613 81613
FRAME TYPE: 1C - LARSON-JUHL -CRANBROOK 1 & 2 - 613677 NATURAL MAPLE

DID: X0003 - 19830
ARTIST: JOSHUA TRUJILLO
TITLE: CHIAPAS 4 - BW


FRAMED WITH MAT
ART SIZE: 14"W X 17 1/2"H
REVEAL BETWEEN MAT SIZE: 4" T/B - 2" L/R
OVERALL SIZE: 19 1/2"W X 27"H
PAPER: 1 LEXJET - PREMIUM ARCHIVAL MATTE PAPER
MAT: CRESCENT RAGMAT - VERY WHITE 1613 81613
FRAME TYPE: 1C - LARSON-JUHL -CRANBROOK 1 & 2 - 613677 NATURAL MAPLE

DID: X0004 - 22089
ARTIST: JOSHUA TRUJILLO
TITLE: COSTA RICA 11 - BW

FRAMED WITH MAT
ART SIZE: 14"W X 17 1/2"H
REVEAL BETWEEN MAT SIZE: 4" T/B - 2" L/R
OVERALL SIZE: 19 1/2"W X 27"H
PAPER: 1 LEXJET - PREMIUM ARCHIVAL MATTE PAPER
MAT: CRESCENT RAGMAT - VERY WHITE 1613 81613
FRAME TYPE: 1C - LARSON-JUHL -CRANBROOK 1 & 2 - 613677 NATURAL MAPLE

DID: X0005 - 16965
ARTIST: MICHEL HANSON
TITLE: COLOMBIA 7 - BW

FRAMED WITH MAT
ART SIZE: 14"W X 17 1/2"H
REVEAL BETWEEN MAT SIZE: 4" T/B - 2" L/R
OVERALL SIZE: 19 1/2"W X 27"H
PAPER: 1 LEXJET - PREMIUM ARCHIVAL MATTE PAPER
MAT: CRESCENT RAGMAT - VERY WHITE 1613 81613
FRAME TYPE: 1C - LARSON-JUHL -CRANBROOK 1 & 2 - 613677 NATURAL MAPLE

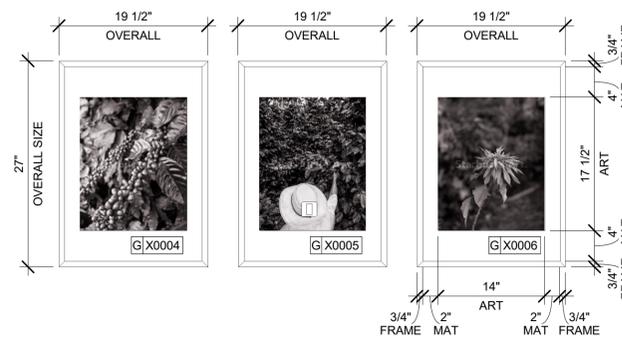


DID: X0006 - 22135
ARTIST: JOSHUA TRUJILLO
TITLE: GUATEMALA 1 - BW

FRAMED WITH MAT
ART SIZE: 14"W X 17 1/2"H
REVEAL BETWEEN MAT SIZE: 4" T/B - 2" L/R
OVERALL SIZE: 19 1/2"W X 27"H
PAPER: 1 LEXJET - PREMIUM ARCHIVAL MATTE PAPER
MAT: CRESCENT RAGMAT - VERY WHITE 1613 81613
FRAME TYPE: 1C - LARSON-JUHL -CRANBROOK 1 & 2 - 613677 NATURAL MAPLE

CAFE TOWARDS ENTRANCE - Callout 1

Scale: 1" = 1'-0"

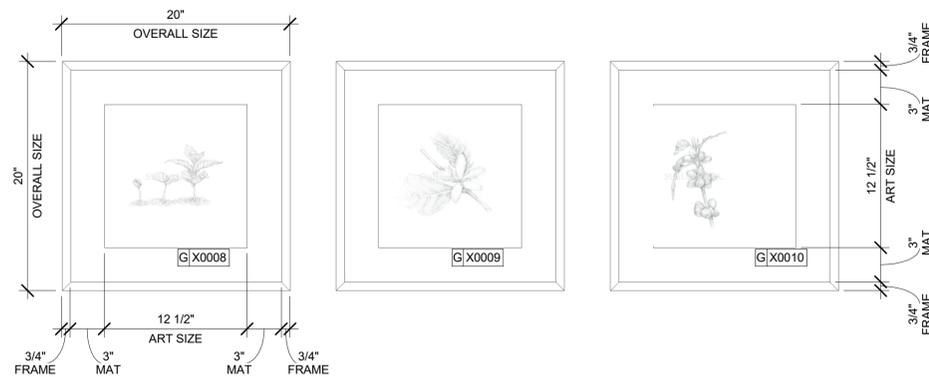

DID: X0008 - 16780
 ARTIST: BEN BLATT
 TITLE: GRAPHITE COFFEE SEEDINGS

FRAMED WITH MAT
ART SIZE: 12 1/2"W X 12 1/2"H
REVEAL BETWEEN
MAT SIZE: 3" T/B - 3" L/R
OVERALL SIZE: 20"W X 20"H
PAPER: 1 LEXJET - PREMIUM ARCHIVAL MATTE PAPER
MAT: CRESCENT RAGMAT - VERY WHITE 1613 81613
FRAME TYPE: 1C -LARSON-JUHL -CRANBROOK
 1 & 2 - 613677 NATURAL MAPLE

DID: X0009 - 16785
 ARTIST: BEN BLATT
 TITLE: GRAPHITE STUDY FLOWER

FRAMED WITH MAT
ART SIZE: 12 1/2"W X 12 1/2"H
REVEAL BETWEEN
MAT SIZE: 3" T/B - 3" L/R
OVERALL SIZE: 20"W X 20"H
PAPER: 1 LEXJET - PREMIUM ARCHIVAL MATTE PAPER
MAT: CRESCENT RAGMAT - VERY WHITE 1613 81613
FRAME TYPE: 1C -LARSON-JUHL -CRANBROOK
 1 & 2 - 613677 NATURAL MAPLE

DID: X0010 - 16784
 ARTIST: BEN BLATT
 TITLE: GRAPHITE STUDY CHERRY BRANCH

FRAMED WITH MAT
ART SIZE: 12 1/2"W X 12 1/2"H
REVEAL BETWEEN
MAT SIZE: 3" T/B - 3" L/R
OVERALL SIZE: 20"W X 20"H
PAPER: 1 LEXJET - PREMIUM ARCHIVAL MATTE PAPER
MAT: CRESCENT RAGMAT - VERY WHITE 1613 81613
FRAME TYPE: 1C -LARSON-JUHL -CRANBROOK
 1 & 2 - 613677 NATURAL MAPLE

ARTWORK AT PARTNER'S

Scale: 1 1/2" = 1'-0"

GRAPHICS AND ARTWORK SCHEDULE - "G"					
DESIGN ID	COUNT	DESCRIPTION	FURN. BY	INST. BY	COMMENTS
GRAPHICS - ARTWORK					
X0001	1	ARTWORK DID: 23246 - RIPENING COFFEE STILL LIFE - ART SIZE: 3' - 11"W X 3' - 11"H - OVERALL SIZE 4' - 0"W X 4' - 0"H.	SB	GC	WRAPPED CANVAS IN FLOAT FRAME WITH 1/4" SPACER PRINTED ON: CANVAS 1: FISHER TEXTILES GF 4394 ART CANVAS FRAME FINISH: FRAME 4A LARSON-JUHL GALLERY ONE 220940 BLACK
X0002	1	ARTWORK DID: 16969 - COLOMBIA 9-BW - ART SIZE 1' - 2"W X 1' - 5 1/2"H - OVERALL SIZE 1' - 7 1/2"W X 2' - 3"H.	SB	GC	WRAPPED CANVAS IN FLOAT FRAME WITH 1/4" SPACER PRINTED ON: CANVAS 1: FISHER TEXTILES GF 4394 ART CANVAS FRAME FINISH: FRAME 4A LARSON-JUHL GALLERY ONE 220940 BLACK
X0003	1	ARTWORK DID: 19830 - CHIAPAS 4-BW - ART SIZE 1' - 2"W X 1' - 5 1/2"H - OVERALL SIZE 1' - 7 1/2"W X 2' - 3"H.	SB	GC	WRAPPED CANVAS IN FLOAT FRAME WITH 1/4" SPACER PRINTED ON: CANVAS 1: FISHER TEXTILES GF 4394 ART CANVAS FRAME FINISH: FRAME 4A LARSON-JUHL GALLERY ONE 220940 BLACK
X0004	1	ARTWORK DID: 22089 - COSTA RICA 11 - ART SIZE 1' - 2"W X 1' - 5 1/2"H - OVERALL SIZE 1' - 7 1/2"W X 2' - 3"H.	SB	GC	WRAPPED CANVAS IN FLOAT FRAME WITH 1/4" SPACER PRINTED ON: CANVAS 1: FISHER TEXTILES GF 4394 ART CANVAS FRAME FINISH: FRAME 4A LARSON-JUHL GALLERY ONE 220940 BLACK
X0005	1	ARTWORK DID: 16965 - COLOMBIA7-BW - ART SIZE 1' - 2"W X 1' - 5 1/2"H - OVERALL SIZE 1' - 7 1/2"W X 2' - 3"H.	SB	GC	WRAPPED CANVAS IN FLOAT FRAME WITH 1/4" SPACER PRINTED ON: CANVAS 1: FISHER TEXTILES GF 4394 ART CANVAS FRAME FINISH: FRAME 4A LARSON-JUHL GALLERY ONE 220940 BLACK
X0006	1	ARTWORK DID: 22135 - GUATEMALA 1-BW - ART SIZE 1' - 2"W X 1' - 5 1/2"H - OVERALL SIZE 1' - 7 1/2"W X 2' - 3"H.	SB	GC	WRAPPED CANVAS IN FLOAT FRAME WITH 1/4" SPACER PRINTED ON: CANVAS 1: FISHER TEXTILES GF 4394 ART CANVAS FRAME FINISH: FRAME 4A LARSON-JUHL GALLERY ONE 220940 BLACK
X0007	1	COMMUNITY BOARD WITH 3" FRAME MAGNETIC MEDIUM WARM BROWN; OVERALL SIZE: 3' - 10" W X 3' - 0" H	SB	GC	WRAPPED CANVAS IN FLOAT FRAME WITH 1/4" SPACER PRINTED ON: CANVAS 1: FISHER TEXTILES GF 4394 ART CANVAS FRAME FINISH: FRAME 4A LARSON-JUHL GALLERY ONE 220940 BLACK
X0008	1	ARTWORK DID: 16780 - GRAPHITE COFFEE SEEDINGS - ART SIZE 0' - 12 1/2"W X 0' - 12 1/2"H - OVERALL SIZE 1' - 10"W X 1' - 10"H.	SB	GC	WRAPPED CANVAS IN FLOAT FRAME WITH 1/4" SPACER PRINTED ON: CANVAS 1: FISHER TEXTILES GF 4394 ART CANVAS FRAME FINISH: FRAME 4A LARSON-JUHL GALLERY ONE 220940 BLACK
X0009	1	ARTWORK DID: 16785 - GRAPHITE STUDY FLOWER - ART SIZE 0' - 12 1/2"W X 0' - 12 1/2"H - OVERALL SIZE 1' - 10"W X 1' - 10"H.	SB	GC	WRAPPED CANVAS IN FLOAT FRAME WITH 1/4" SPACER PRINTED ON: CANVAS 1: FISHER TEXTILES GF 4394 ART CANVAS FRAME FINISH: FRAME 4A LARSON-JUHL GALLERY ONE 220940 BLACK
X0010	1	ARTWORK DID: 16784 - GRAPHITE STUDY CHERRY - ART SIZE 0' - 12 1/2"W X 0' - 12 1/2"H - OVERALL SIZE 1' - 10"W X 1' - 10"H.	SB	GC	WRAPPED CANVAS IN FLOAT FRAME WITH 1/4" SPACER PRINTED ON: CANVAS 1: FISHER TEXTILES GF 4394 ART CANVAS FRAME FINISH: FRAME 4A LARSON-JUHL GALLERY ONE 220940 BLACK
GRAPHICS - OTHER					
23136	1	AUTOMATIC DOOR CAUTION SIGNAGE			



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STARBUCKS TEMPLATE VERSION: i2024.01.01

PABLO GARCIA, AIA, REG. FL NO. AR99297

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PROJECT NAME:
A1A & 10TH

PROJECT ADDRESS:
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 32250**

STORE #: 8565
 PROJECT #: 18756-108
 ISSUE DATE: 03-27-2024
 DESIGN MANAGER: ROMINA VIGNOLO
 PRODUCTION DESIGNER: GENSLER
 CHECKED BY: GENSLER



Revision Schedule			
Rev	Date	By	Description

SHEET TITLE:
ARTWORK

SCALE: AS SHOWN


SHEET NUMBER:
1511.1

PERMIT SET - FOR CONSTRUCTION USE

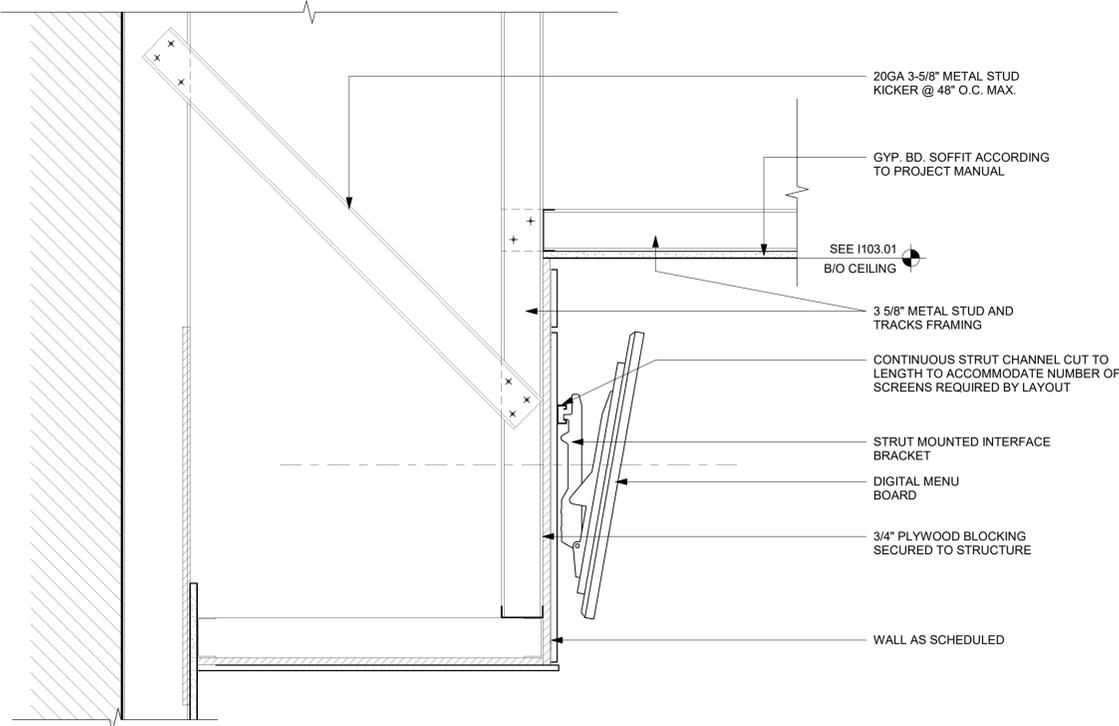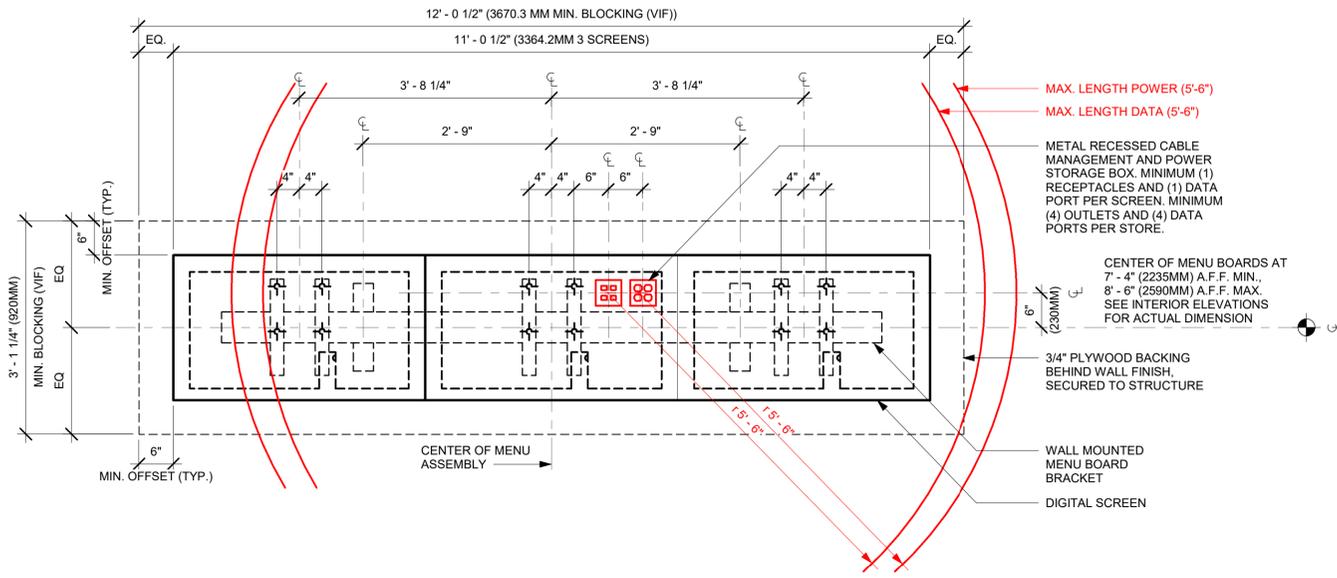


01 DIGITAL MENU BOARDS - STANDARD MOUNT
 Scale: 3/4" = 1'-0"

02 MENU BOARDS - SECTION
 Scale: 1 1/2" = 1'-0"

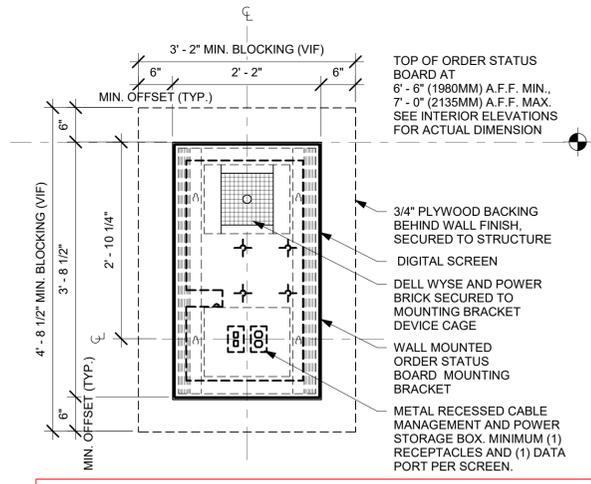

DESIGNER/CONSULTANT TO ADAPT DETAIL BASED ON STORE SPECIFIC ORDER STATUS BOARD EQUIPMENT PER SDRC GUIDELINES FOR DIGITAL ORDER STATUS BOARDS.

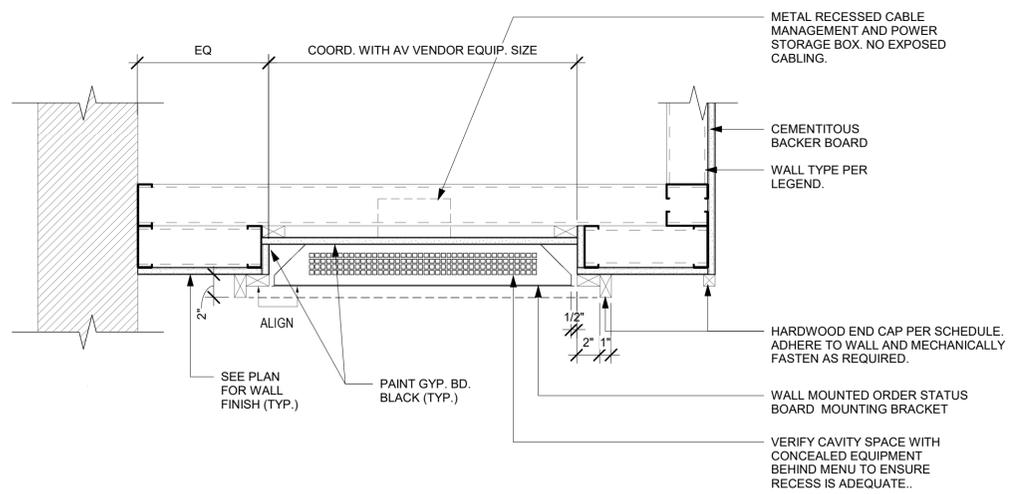

03 ORDER STATUS BOARD INFRASTRUCTURE
 Scale: 3/4" = 1'-0"

04 RECESSED OSB PLAN VIEW DETAIL
 Scale: 1 1/2" = 1'-0"



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STARBUCKS TEMPLATE VERSION: i2024.01.01

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 32250**

STORE #: 8565
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 ISSUE DATE: 03-27-2024
 DESIGN MANAGER: ROMINA VIGNOLO
 PRODUCTION DESIGNER: GENSLER
 CHECKED BY: GENSLER

Revision Schedule			
Rev	Date	By	Description

SHEET TITLE:
MENU DETAILS

SCALE: AS SHOWN

SHEET NUMBER:
1512

PERMIT SET - FOR CONSTRUCTION USE

CASEWORK SCHEDULE - "C"						
DESIGN ID	COUNT	DESCRIPTION	FURN. BY	INST. BY	COMMENTS	
X0001	17	WOOD TRIM - 6 1/2X1 1/2IN 152X38MM - WHITE OAK WD0073.	SB	GC	TO BE PROVIDED BY CASEWORK VENDOR. REQUIRED (V.I.F.): (1)3'-10", (2) 7'-6"	
X0010	20	WOOD TRIM - "X" IN "X" MM (VIF) X 3/4IN 20MM - "X"	SB	GC	GC TO VERIFY ALL DIMENSIONS AND NOTIFY SB/VD ANY DISCREPANCIES. TO BE PROVIDED BY CASEWORK VENDOR.	
X0015	1	DECORATIVE METAL TRIM - 5X1/8IN 127X3MM	SB	GC	MATERIAL: ALUMINIUM FINISH; POWDERCOATED FLAT BLACK MT0028. GC TO VERIFY ALL DIMENSIONS AND NOTIFY SB/VD ANY DISCREPANCIES. TO BE PROVIDED BY CASEWORK VENDOR	
CABINET						
19281	2	CABINET - ESPRESSO ICE BIN STAINLESS - 20IN 510MM	SB	GC		
21890	39	CABINET - SIDE PANEL	SB	GC		
21891	11	CABINET - BOTTOM SHELF - 15IN 380MM	SB	GC		
21892	8	CABINET - BACK PANEL - 15IN 380MM	SB	GC		
21893	5	CABINET - ADJUSTABLE SHELF - 15IN 380MM	SB	GC		
21894	6	CABINET - DOOR - 15IN 380MM	SB	GC		
21895	9	CABINET - DOOR TRASH - 15IN 380MM	SB	GC		
21896	2	CABINET - DRAWER - 15IN 380MM	SB	GC		
21898	3	CABINET - BOTTOM SHELF - 18IN 455MM	SB	GC		
21899	3	CABINET - BACK PANEL - 18IN 455MM	SB	GC		
21900	2	CABINET - ADJUSTABLE SHELF - 18IN 455MM	SB	GC		
21901	3	CABINET - DOOR - 18IN 455MM	SB	GC		
21902	6	CABINET - BOTTOM SHELF - 30IN 760MM	SB	GC		
21903	3	CABINET - BACK PANEL - 30IN 760MM	SB	GC		
21904	9	CABINET - ADJUSTABLE SHELF - 30IN 760MM	SB	GC		
21905	3	CABINET - DOOR - 30IN 760MM	SB	GC		
21906	1	CABINET - END CAP FRONTBAR	SB	GC		
21907	4	CABINET - END CAP BACKBAR	SB	GC		
21908	7	CABINET - FILLER PANEL - VARIABLE LENGTH	SB	GC		
21909	1	CABINET - DT POS UPPER CUBBY - 32IN 815MM	SB	GC		
21910	1	CABINET - FRENCH CLEAT - VARIABLE LENGTH	SB	GC	DESIGNER TO VERIFY QUANTITY. PROVIDE OVERALL LENGTH REQUIRED.	
21912	3	CABINET - BACK PANEL FOR POS - 30IN 760MM	SB	GC		
21913	2	CABINET - EQUIPMENT MOUNTING PANEL	SB	GC		
22749	1	CABINET - ESPRESSO PUMP MOUNT PANEL	SB	GC		
22986	2	CABINET - DELIVERY DRAWER - 15IN 380MM	SB	GC		
23425	2	CABINET - WRM DOOR LOWERED COUNTER - 15IN 380MM	SB	GC		
CABINETS						
23712	1	CABINET - CBE UPPER CASEWORK TALL IN-LINE - RF - 82IN	SB	GC		
CAFE						
20117	2	CABINET - 36IN 915MM - WHITE OAK WD0073	SB	GC		
20118	1	CABINET - 18IN 455MM - WHITE OAK WD0073	SB	GC		
20377	1	WALL BAY ON STANDARD 3 UNIT - 90IN 2285MM - WHITE OAK WD0073	SB	GC		
23964	1	WASTE AND RECYCLE STATION THREE DROP - GOLDEN BLONDE AND WHITE PL0027 CP0002	SB	GC		
COUNTERTOP						
21918	1	COUNTERTOP - FILLER FRONTBAR - VARIABLE LENGTH	SB	GC		
21919	6	COUNTERTOP - FILLER BACKBAR - VARIABLE LENGTH	SB	GC		
21922	2	COUNTERTOP - FRONTBAR - 30IN 760MM	SB	GC		
21923	1	COUNTERTOP - END CAP FRONTBAR	SB	GC		
21926	2	COUNTERTOP - BACKBAR - 18IN 455MM	SB	GC		
21927	1	COUNTERTOP - BACKBAR - 30IN 760MM	SB	GC		
21928	4	COUNTERTOP - END CAP BACKBAR	SB	GC		
22328	1	COUNTERTOP - BREW - LF - 90IN 2285MM	SB	GC		
22352	1	COUNTERTOP - ESPRESSO FRONTBAR - LF - 141IN 3580MM	SB	GC		
22354	1	COUNTERTOP - ESPRESSO SHROUD - 141IN 3580MM	SB	GC		
22361	1	COUNTERTOP - POS - 84IN 2135MM	SB	GC		
22362	1	COUNTERTOP - DT POS - LF - 76IN 1930MM	SB	GC		
22377	1	COUNTERTOP - WARMING - RF - 92IN 2335MM	SB	GC		
22388	1	COUNTERTOP - CONSOLIDATED HANDOFF - 30IN 760MM	SB	GC		
22394	10	COUNTERTOP - BACKSPLASH - VARIABLE LENGTH	SB	GC		
22395	2	COUNTERTOP - HAND SINK LOW SPLASH - 15IN 380MM	SB	GC		
22404	1	COUNTERTOP - END CAP FRONTBAR ROUNDED	SB	GC		
23151	1	COUNTERTOP - PARTNER AMENITY - 67IN 1700MM	SB	GC		
23403	1	COUNTERTOP - CBE IN-LINE RF - 139IN 3530MM	SB	GC		
23430	1	COUNTERTOP - WRM RF - 78IN 1980MM	SB	GC		
DIEWALL						
21885	18	DIEWALL - FRAMING - VARIABLE LENGTH	SB	GC		
21886	7	DIEWALL - BASE - VARIABLE LENGTH	SB	GC		
21887	7	DIEWALL - SUBSTRATE PANEL - VARIABLE LENGTH	SB	GC		
21888	54	DIEWALL - SUPPORT LEG	SB	GC		
22405	1	DIEWALL - END CAP ROUNDED	SB	GC		
23439	1	DIEWALL - WRM STRUCTURE LOWERED COUNTER	SB	GC		
OTHER						
11155	2	ESPRESSO MACHINE PUMP MOUNT - 10X10IN 25X255MM	SB	GC		
21914	9	FRIDGE STOP BRACKET SET	SB	GC		
PANEL						
21933	7	FINISH PANEL - VARIABLE LENGTH	SB	GC		
22406	1	FINISH PANEL - END CAP ROUNDED	SB	GC		
TRIM						
X0006	6	METAL TRIM - 5X1/8IN 127X3MM	SB	GC	FINISH: POWDERCOATED FLAT BLACK MT0028. MATERIAL: ALUMINIUM. GC TO VERIFY ALL DIMENSIONS AND NOTIFY SB/VD ANY DISCREPANCIES.	

CASEWORK FINISH SCHEDULE				
ENGINE ZONE	MATERIAL DESCRIPTION	FINISH CODE	COMMENTS	
COMPOSITE - BRUSHED WARM GREY				
COUNTERTOPS - BACKBAR	COMPOSITE - BRUSHED WARM GREY	CP0056		
COUNTERTOPS - ESPRESSO	COMPOSITE - BRUSHED WARM GREY	CP0056		
COUNTERTOPS - SHROUD	COMPOSITE - BRUSHED WARM GREY	CP0056		
COUNTERTOPS - FRONTBAR	COMPOSITE - BRUSHED WARM GREY	CP0056		
COMPOSITE - MATTE BLACK MOTTLED PAPER				
CABINETS - EXTERIOR	COMPOSITE - MATTE BLACK MOTTLED PAPER	CP0024		
CUSTOM PLAM - WILSONART	KHAKI BROWN D50-60 - MATTE FINISH			
CABINETS - UPPER	CUSTOM PLAM - WILSONART - KHAKI BROWN D50-60 - MATTE FINISH	X0600		
METAL - FLAT BLACK POWDERCOAT				
FRAMING AND HARDWARE	METAL - FLAT BLACK POWDERCOAT	MT0028		
METAL - STAINLESS STEEL - BRUSHED				
CABINETS - UNDERCOUNTER ICE BIN	METAL - STAINLESS STEEL - BRUSHED	#4 BRUSHED 16GA		
COUNTERTOPS - HAND SINK	METAL - STAINLESS STEEL - BRUSHED	#4 BRUSHED 16GA		
FRAMING AND HARDWARE	METAL - STAINLESS STEEL - BRUSHED	#4 BRUSHED 16GA		
PLAM - MOTTLED BLACK				
CABINETS - DT POS CUBBY	PLAM - MOTTLED BLACK	PL0019		
PLASTIC - BLACK				
CABINETS - EXTERIOR	PLASTIC - BLACK	PL0044		
CABINETS - INTERIOR	PLASTIC - BLACK	PL0044		
CABINETS - UPPER	PLASTIC - BLACK	PL0044		
FRAMING AND HARDWARE	PLASTIC - BLACK	PL0044		
PLASTIC - BLACK HDPE				
CABINETS - INTERIOR	PLASTIC - BLACK HDPE	PL0044		
WOOD - WHITE OAK - PLANK - VERTICAL				
FINISH PANELS	WOOD - WHITE OAK - PLANK - VERTICAL	WD0073		
FINISH PANELS - FRONTBAR	WOOD - WHITE OAK - PLANK - VERTICAL	WD0073		

SPECIALTY EQUIPMENT SCHEDULE - "E"						
DESIGN ID	COUNT	DESCRIPTION	FURN. BY	INST. BY	COMMENTS	
COOLING						
10267	4	FRIDGE UNDERCOUNTER 1 DOOR - 27IN 685MM	SB	GC		
10970	1	FRIDGE REACH IN 1 DOOR LH - 29IN 735MM	SB	GC		
12618	1	FRIDGE UNDERCOUNTER 1 DOOR WITH SHELF - 27IN 685MM	SB	GC		
EQUIPMENT						
17564	1	BLENDER PITCHER RINSER WITH SENSOR	SB	GC		
22885	1	BREWER CLOVER VERTICA DOUBLE	SB	GC		
23380	1	BREWER CLOVER VERTICA INSTALL KIT	SB	GC		
23381	1	BREWER CLOVER VERTICA CORD	SB	GC		
23393	3	EQUIPMENT - CBE MILK DISPENSE BRACKET SLIDE	SB	GC		
23419	3	MILK DISPENSER	SB	GC		
23443	1	OVEN COMBI	SB	GC		
TK0052	1	BOH PARTNER AREA MICROWAVE OVEN - BLACK	GC	GC		
FOOD CASE						
16239	1	FOOD CASE - ZEPHYR MINI - 54IN 1370MM	SB	GC		
23440	1	FOOD CASE - WARMING WALL - 1000 SQUARE	SB	GC		
ICE						
18029	1	ICE - BIN B110	SB	GC	BPF-1 ADAPTER KIT (011076103) REQUIRED WHEN PAIRING WITH 30" (760MM) ICE MACHINES	
19278	2	ICE - BIN DROP IN 45LB 20KG HORIZONTAL	SB	GC		
23181	1	ICE - MACHINE HMD2110RBT REMOTE COOLED	SB	GC		
23421	1	ICE - NUGGET ICE DISPENSER - SINGLE ICE MACHINE	SB	GC		
23423	1	ICE - NUGGET ICE DIVERTER	SB	GC		
23424	1	ICE - NUGGET ICE DIVERTER CONTROL PANEL	SB	GC		
23526	1	ICE - BIN ADAPTOR FOLLETT B110H22H30DV PEDESTAL FOR B110	SB	GC		
OTHER						
10091	1	CUP DISPENSER TALL HOT VERTICAL	SB	GC		
10396	1	CUP DISPENSER SHORT HOT VERTICAL	SB	GC		
10791	2	CUP DISPENSER GRANDE VENTI COLD VERTICAL	SB	GC		
10829	24	CORNER GUARD - 1.25IN 30MM - PEWTER	SB	GC	@ BOH	
10855	2	CUP DISPENSER GRANDE VENTI HOT VERTICAL	SB	GC		
10858	1	CUP DISPENSER TALL COLD VERTICAL	SB	GC		
10992	2	PAPER TOWEL DISPENSER HALF SIZE - TRANSLUCENT GRAY	SB	GC		
11115	2	SOAP DISPENSER SINK MOUNTED	SB	GC		
13330	1	MOBILE CUP DISPENSER CADDY	SB	GC		
13584	1	CUP DISPENSER TRENTA COLD VERTICAL	SB	GC		
21554	6	POWER EXTENSION DUAL RECEPTACLE AND USB SURFACE MOUNT - BLACK	SB	GC		
22627	1	NITRO 2 TAP HANDLE WITH BADGE AND MOUNT KIT			JOE TAP, FOR USE AT BACKBAR NITRO FONT	
23420	2	REFRESHER DISPENSE SMALL	SB	GC		
X1000	2	CORNER GUARD - MILLWORK 1/4" POST OUTSIDE CORNER	SB	GC	FINISH: BLACK. GC TO ORDER FROM FRY REGLET.	
STORAGE						
10416	3	WORKROOM SHELIVING - 36IN 915MM	SB	GC		
10462	3	WORKROOM SHELIVING POSTS	SB	GC		
10698	1	MOP RACK WITH 3 HOLDERS	SB	GC		
13834	1	BASE - 24X18IN 610X455MM	SB	GC		
17255	1	PASTRY TRAY CART - 60IN 1525MM	SB	GC		
		PASTRY TRAY CART - 60IN 1525MM	SB	GC		
23441	3	PASTRY COOLING RACK WALL MOUNTED	SB	GC		
TK0048	2	5 COMP LOCKER - 15IN 380MM	SB	GC		

FURNITURE SCHEDULE - "F"						
DESIGN ID	COUNT	DESCRIPTION	FURN. BY	INST. BY	COMMENTS	
BANQUETTE						
22502	3	BANQUETTE - SAN JUAN - 6FT 183CM - WHITE OAK WD0073	SB	GC		
23017	3	BANQUETTE - SAN JUAN CUSHION SEAT AND BACK EDGE - 6FT 183CM - CARAMEL BROWN NATURAL F0008	SB	GC		
CHAIR						
21367	13	CHAIR - CAFE PEGGY UPHOLSTERED - WHITE OAK AND CARAMEL BROWN NATURAL WD0073 F0008	SB	GC		
21456	8	CHAIR - CAFE ASHER UPHOLSTERED BACK - WHITE OAK AND CARAMEL BROWN NATURAL WD0073 F0008	SB	GC		
22569	4	CHAIR - LOUNGE LAIDBACK - WHITE OAK AND CARAMEL BROWN NATURAL WD0073 F0008	SB	GC		
23447	20	CHAIR - CAFE HANS 2.0 - MOTTLED GREY	SB	GC		
23449	10	CHAIR - LOUNGE HANS 2.0 - MOTTLED GREY	SB	GC		
TK0077	1	CHAIR - MANAGERS WORKSTATION	SB	GC	STEELCASE SERIES ONE ARMLESS	
DESK						
TK0053	1	DESK - MANAGERS WORKSTATION SHELVES - 48IN 1220MM	SB	GC		
TK0076	1	DESK - MANAGERS WORKSTATION - 48X24X27IN 1220X610X885MM	SB	GC		
MIRROR						
TK0050	1	MIRROR - BOH - 16X51IN 405X1295MM	SB	GC		
OTHER						
10756	2	COAT HOOK 1 PRONG SQUARE - 2IN 50MM - SST				
TK0051	1	COAT HOOK STRIP - 30IN 760MM	SB	GC	BLACK FINISH	
STORAGE						
TK0078	1	FILE MOBILE PEDESTAL WITH CUSHION AND LOCK	SB	GC		
TK0079	1	MANAGERS DESK CART - 24X20IN 610X510MM	SB	GC		
TABLE						
17340	8	TABLE - CAFE METAL PEDESTAL BASE SQUARE - 24IN 610MM - BLACK MT0028	SB	GC		
17341	2	TABLE - ACCESSIBLE METAL WITH TAPERED LEGS - 36X24IN 915X610MM - BLACK MT0028	SB	GC		
18400	1	TABLE - COMMUNITY CAFE HEIGHT ANGLE BASE - 8 SEAT WIDE - WITH POWER WHITE OAK WD0073	SB	GC		
20127	5	TABLE - OCCASIONAL SIDE CAMERON - FLAT BLACK MT0028	SB	GC		
21449	8	TABLE - BASE CAFE HEIGHT BOTTLE - FLAT BLACK MT0028	SB	GC		
21453	1	TABLE - BASE ACCESSIBLE BOTTLE - FLAT BLACK MT0028	SB	GC		
21713	1	TABLE - TOP ACCESSIBLE ROUND EDGE OBLONG - 48X24IN 1220X610MM - WHITE WITH VEINING CP0002	SB	GC		
21842	4	TABLE - TOP ROUND EDGE ROUND - 24IN 610MM - WHITE OAK WD0073	SB	GC		
21845	3	TABLE - TOP ROUND EDGE ROUND - 30IN 760MM - WHITE OAK WD0073	SB	GC		
21848	1	TABLE - TOP ROUND EDGE SQUARE - 24IN 610MM - WHITE OAK WD0073	SB	GC		
21979	2	TABLE - OCCASIONAL SIDE WING - WHITE OAK WD0073	SB	GC		
22553	2	TABLE - OCCASIONAL COFFEE WING - WHITE OAK WD0073	SB	GC		
WINDOW TREATMENT						
22486	12	ROLLER SHADE - DARK BROWN - 5PC OPEN			PROVIDED BY: BLIND EXPRESS (LEAD TIMES: 2 WEEKS). CONTACT ALBERT YU ATAYU@BLINDEXPRESS.COM, PH: (770) 664-1688. OR ROLL A SHADE (LEAD TIMES: 4 WEEKS). ORDERING CONTACT KRISTEN FANNIN AT KRISTEN.FANNIN@ROLLASHADE.COM, PH: (951) 245-5077 X 114.	
GRAPHICS AND ARTWORK SCHEDULE - "G"						
DESIGN ID	COUNT	DESCRIPTION	FURN. BY	INST. BY	COMMENTS	
GRAPHICS - ARTWORK						
X0001	1	ARTWORK DID: 23246 - RIPENING COFFEE STILL LIFE - ART SIZE: 3' - 11"W X 3' - 11"H - OVERALL SIZE 4' - 0"W X 4' - 0"H.	SB	GC	WRAPPED CANVAS IN FLOAT FRAME WITH 1/4" SPACER PRINTED ON; CANVAS 1: FISHER TEXTILES GF 4394 ART CANVAS FRAME FINISH: FRAME 4A LARSON-JUHL GALLERY ONE 220940 BLACK	
X0002	1	ARTWORK DID: 16969 - COLOMBIA 9-BW - ART SIZE 1' - 2"W X 1' - 5 1/2"H - OVERALL SIZE 1' - 7 1/2"W X 2' - 3"H.	SB	GC	WRAPPED CANVAS IN FLOAT FRAME WITH 1/4	

WALL TREATMENT (AREA) SCHEDULE - "Q"						
DESIGN ID	AREA	DESCRIPTION	FURN. BY	INST. BY	COMMENTS	
23764	2960 SF	POLYWALL WALL COVERING - MATTE WHITE	GC	GC		
OTHER						
X1100	413 SF	GYP CEILING - GWB CEILING WITH LEVEL 4 FINISH - PAINT AS SCHEDULED	GC	GC	FINISH: REFER TO RCP PLAN AT I103 FOR TONE TAG; INSTALLATION SHALL BE IN STRICT ACCORDANCE W/ MANUFACTURER'S INSTRUCTIONS.	
TILE						
12201	528 SF	TILE - HAMMERED WARM TAUPE - 13X13IN 330X330MM	SB	GC	GROUT GR0007; MAPEI - 47 CHARCOAL; LATICRETE - 35 MOCHA	
X1400	689 SF	TILE - ALTAMIRA - VANILLA - GLOSSY	SB	GC	GROUT: MAPEI - 105 DRIFTWOOD, OR EQUAL	
WALL COVERING						
20623	1396 SF	WALL COVERING - BURLAP - RETREAT	SB	GC		
WOOD						
X1401	251 SF	WOOD - WHITE OAK - PLANK - VERTICAL	SB	GC	CLASS A FIRE RETARDANT TREATMENT (PER ASTM E 94) OR PASSES NFPA 286 (DID: SPC006) SELECTED GRAIN, FULL PLANK. LENGTH REQUIRED (V.I.F.): (1) 10'-1" W X 9'-4" H	

WALL BASE SCHEDULE - "B"						
DESIGN ID	LENGTH	DESCRIPTION	FURN. BY	INST. BY	COMMENTS	
COVE BASE						
X1300	55' - 6 1/2"	SCHLUTER - DILEX - AHK 100 ATGB	GC	GC	W/ SANITARY 3/8IN COVE BASE MOLDING. FINISH: DARK ANTHRACITE	
METAL BASE						
X1301	33' - 9 1/4"	METAL BASE - BLACK MT0028 - 6IN 150MM	GC	GC	W/ SANITARY 1/2IN COVE BEND 45-DEGREE. PROVIDED BY CASEWORK VENDOR.	
TILE BASE						
18740	173' - 7 3/4"	TILE BASE - PLAZA NOVA - BLACK SHADOW - 6X12IN 150X300MM	SB	GC	W/ BULLNOSE SANITARY 3/8IN COVE BASE MOLDING. GROUT: MAPEI - 10 BLACK, OR EQUAL.	
19795	321' - 5 1/2"	POLYVINYL FLOOR TILE - ECOGRIP - PEWTER	GC	GC		
TRANSITION BASE						
X1301	25' - 0"	TAPERED ALUMINIUM FRAME - 16 GA	GC	GC	FINISH: TEXTURED COLOR-COATED BLACK (DID: MT0028).	

CEILING TREATMENT SCHEDULE - "U"						
DESIGN ID	AREA	DESCRIPTION	FURN. BY	INST. BY	COMMENTS	
OTHER						
19734	151 SF	ACT - ULTIMA - 2X2FT 61X61CM	GC	GC	DESIGN TO SPECIFY WHITE, OR CUSTOM COLOR; FOR ORDERING CONTACT DEB PICKENS AT DLPICKENS@ARMSTRONGCEILING.COM , PH: 480-695-9053	
22764	203 SF	ACT - CIRRUS BEVELED SUPRAFINE - FACTORY FINISH - 2X4FT 61X122CM	GC	GC	FINISH: REFER TO RCP PLAN AT I103 FOR TONE TAG; FOR ORDERING CONTACT DEB PICKENS AT DLPICKENS@ARMSTRONGCEILING.COM , PH: 480-695-9053. CANNOT BE PAINTED IN FIELD. DOING SO WILL VOID ITS WARRANTY.	
22764	1854 SF	ACT - CIRRUS BEVELED SUPRAFINE - FACTORY FINISH - 2X4FT 61X122CM	GC	GC	FINISH: REFER TO RCP PLAN AT I103 FOR TONE TAG; FOR ORDERING CONTACT DEB PICKENS AT DLPICKENS@ARMSTRONGCEILING.COM , PH: 480-695-9053. CANNOT BE PAINTED IN FIELD. DOING SO WILL VOID ITS WARRANTY.	
X1100	633 SF	GYP CEILING - GWB CEILING WITH LEVEL 4 FINISH - PAINT AS SCHEDULED	GC	GC	FINISH: REFER TO RCP PLAN AT I103 FOR TONE TAG; INSTALLATION SHALL BE IN STRICT ACCORDANCE W/ MANUFACTURER'S INSTRUCTIONS.	

LIGHTING FIXTURE SCHEDULE - "L"						
DESIGN ID	COUNT	DESCRIPTION	FURN. BY	INST. BY	BULB	COMMENTS
EXIT						
19047	4	LED EXIT SIGN WITH EMERGENCY LIGHT - BLACK AND GREEN	SB	GC	LED 5W LOW ENERGY OR EQUAL	
19057	6	LED EMERGENCY LIGHT DOUBLE - BLACK	SB	GC	<varies>	
PENDANT						
20683	3	PENDANT - FEISS NODES - MIDNIGHT BLACK	SB	GC	AS PACKAGED: 1X LED T4 FROSTED 5W G9 BASE	
X0602	1	PENDANT - MATTEO ASTRO C80701AGOP - BLACK	SB	GC	(1) 25W E12 BASE	
RECESSED CAN						
X0601	60	CAN - LED ADJUSTABLE RECESSED - 3IN 75MM - BLACK - 1155LM FLOOD	SB	GC	INTEGRATED LED	WITH DIMMER.
SCONCE						
20748	2	SCONCE - KUZZO PLUTO TRIPLE - CHROME	SB	GC	INTEGRATED LED	
STRIP						
22215	2	STRIP - LED TAPE IN HOUSING - VARIABLE LENGTH - BLACK - 350LM PER FT	SB	SB	INTEGRATED LED	FIELD TRIMMABLE TO 0.9IN LENGTHS
TRACK						
12946	1	TRACK - WITH CONNECTORS - 4FT 122CM - BLACK	SB	GC		
19410	3	TRACK - WITH CONNECTORS - 6FT 183CM - BLACK - 2 CIRCUIT	SB	GC		
19411	1	TRACK - WITH CONNECTORS - 8FT 244CM - BLACK - 2 CIRCUIT	SB	GC		
19413	2	TRACK - WITH CONNECTORS - 16FT 488CM - BLACK - 2 CIRCUIT				
21779	35	TRACK - LED FIXTURE WITH SNOOT - 3IN 75MM - BLACK - 1100LM FLOOD	SB	GC	INTEGRATED LED	

BARRIER FREE DOOR HARDWARE SCHEDULE - "D"						
DESIGN ID	COUNT	MARK	DESCRIPTION	FURN. BY	INST. BY	COMMENTS
23130	1	05	DOOR - BARRIER FREE HARDWARE ACTUATOR BOLLARD	SB	GC	
23129	1	08	DOOR - BARRIER FREE HARDWARE KEY SWITCH	SB	GC	
23134	1	07	DOOR - BARRIER FREE HARDWARE OPERATOR - SILVER	SB	GC	

WALL TREATMENT (LENGTH) SCHEDULE - "R"						
DESIGN ID	LENGTH	DESCRIPTION	FURN. BY	INST. BY	COMMENTS	
CHAIR RAIL						
X0006	3' - 10"	CHAIR RAIL - 4IN 100MM - WALNUT WD0077	SB	GC	MOUNTED AT 36IN (915MM) AFF. PROVIDED BY CASEWORK VENDOR	
X1500	19' - 10 1/2"	CHAIR RAIL	SB	GC	SEE CASEWORK FINISH SCHEDULE FOR MATERIAL. SUPPLIED BY CASWORK VENDOR	
WAINSCOT						
X1501	19' - 10 1/2"	VINYL - WAINSCOT - BLACK STRIPE TEXTURE AT 36IN 915MM AFF	GC	GC		

FLOOR TREATMENT SCHEDULE - "T"						
DESIGN ID	AREA	DESCRIPTION	FURN. BY	INST. BY	COMMENTS	
PLASTIC						
19795	1282 SF	POLYVINYL FLOOR TILE - ECO-GRIP - PEWTER	SB	GC	GC TO PROCURE FROM ALLIED INDUSTRIES	
TILE						
20228	1247 SF	TILE - I COCCI - CEMENTO - 24X24IN 600X600MM	SB	GC	GROUT: MAPEI - 47 CHARCOAL, OR EQUAL	
WALK OFF MAT						
19288	36 SF	WALK OFF MAT - HELIX Z1 - BLACK - 12X9IN 305X230MM	SB	GC		

PLUMBING FIXTURE SCHEDULE - "P"						
DESIGN ID	COUNT	DESCRIPTION	FURN. BY	INST. BY	COMMENTS	
DRAIN						
10294	8	DRAIN - FLOOR SINK SQUARE - 5IN 125MM	SB	GC		
10726	8	DRAIN - GRATE HALF SQUARE - 12IN 305MM	SB	GC		
FAUCET						
10152	2	FAUCET - DOUBLE LABORATORY WITH BENT RISER SPOUT	SB	GC		
10153	3	FAUCET - WATER TOWER - 12IN 305MM	SB	GC		
10215	1	FAUCET - DOUBLE LABORATORY WITH SWING SPOUT	SB	GC		
10597	2	FAUCET - SINGLE HANDLE	SB	GC		
10922	1	FAUCET - MOP SINK WALL MOUNTED	SB	GC		
11003	2	FAUCET - METERED	SB	GC		
22642	2	FAUCET - INSTANTHOT SYSTEM 2 BUTTON WITH BOILER AND BRACKET	SB	GC	KIT INCLUDES FONT, UNDERCOUNTER BOILER AND BOILER BRACKET FOR SIDE PANEL MOUNTING. BRACKET CAN BE FLOOR MOUNTED USING SET OF (4) STAINLESS STEEL LEGS, ORDERED SEPARATELY THROUGH VENDOR.	
FILTER						
12501	1	FILTER - RO SYSTEM 600GPD	SB	GC		
12507	1	FILTER - RO SYSTEM 40GAL STORAGE TANK	SB	GC		
12896	1	FILTER - BRINE TANK	SB	GC		
12899	2	FILTER - POLY GLASS VESSEL	SB	GC		
13082	1	FILTER - WATER SOFTENER TWIN	SB	GC		
OTHER						
22226	1	WATER HEATER TANK ELECTRIC - 18KW	SB	GC		
SINK						
10549	2	SINK - RINSE DROP IN SST - 12X20IN 305X510MM	SB	GC		
10995	1	SINK - MOP - 24X24IN 610X610MM	SB	GC		
17565	1	SINK - RINSE WITH DRAINBOARD - 15X27IN 380X855MM	SB	GC		
22768	2	SINK - COUNTERTOP RINSER WITH WATER TOWER - 26X9IN 660X235MM	SB	GC		

DOOR SCHEDULE - "D"									
DESIGN ID	MARK	DESCRIPTION	WIDTH	HEIGHT	HARDWARE SET	FURN. BY	INST. BY	COMMENTS	
Exterior									
10449	E01	Door - Double Storefront Metal Frame	6' - 0"	6' - 10"	EXIST			EXISTING DOOR TO REMAIN.	
10190	E02	Door - Single Flush - 36in 915mm	3' - 5"	6' - 7"	EXIST			EXISTING DOOR TO REMAIN.	
10205	03	DOOR - STOREFRONT METAL FRAME SINGLE - TYPE B	3' - 0"	7' - 0"	3-A-BRFR	LL	GC	MATCH EXISTING MANUFACTURER AND EXTERIOR DESIGN PRESSURES. PROVIDE 32" MIN CLEAR OPENING. BUTTOM RAIL MIN. 10 IN. ACCORDING TO ADA.	
Interior									
10190	02	DOOR - SINGLE FLUSH - 36IN 915MM	3' - 0"	7' - 0"	7	SB	GC	DOOR FINISH BLACK STAIN TO MATCH WD0035. FRAME FINISH: PAINT BLACK MAGIC SW6991	
10190	E03	DOOR - SINGLE FLUSH - 36IN 915MM	3' - 0"	7' - 0"	EXIST	SB	GC	DOOR FINISH BLACK STAIN TO MATCH WD0035. FRAME FINISH: PAINT BLACK MAGIC SW6991	
10086	01	DOOR - SINGLE IMPACT DOUBLE ACTING - 36IN 915MM	3' - 0"	7' - 0"	11	SB	GC	HM, U, NR HM4, DOOR TYPE B. FINISHES: DOOR PANEL: X0302 WILSONART LAMINATE PAPERDUST D327 60 MATTE FINISH. FRAME: MATCH SW7029 AGREEABLE GREY.	


PAINT SCHEDULE						
DESIGN ID	DESCRIPTION	LRV	FURN. BY	INST. BY	COMMENTS	
20444	SW7043 WORLDLY GRAY, OR EQUIVALENT	57	GC	GC		
20446	SW7045 INTELLECTUAL GRAY, OR EQUIVALENT	36	GC	GC	SW USE PRIMER CP-1; NCS - S 3005-Y20R; AKZO NOBEL - 40YY 44/095	
20456	SW7631 CITY LOFT, OR EQUIVALENT	70	GC	GC	SW USE PRIMER CP-1; NCS - S 7502-Y; AKZO NOBEL - 30YY 10/038	



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STARBUCKS TEMPLATE VERSION: i2024.01.01



PABLO GARCIA, AIA, REG. FL NO. AR99297
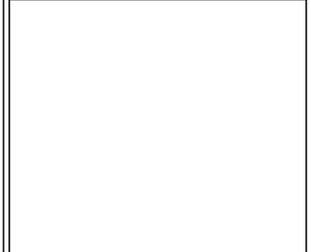
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PROJECT NAME:
A1A & 10TH
PROJECT ADDRESS:
**975 3RD STREET SOUTH
JACKSONVILLE BEACH, FL
32250**

STORE #: 8565
PROJECT #: 18756-108
ISSUE DATE: 03-27-2024
DESIGN MANAGER: ROMINA VIGNOLO
PRODUCTION DESIGNER: GENSLER
CHECKED BY: GENSLER

Revision Schedule			
Rev	Date	By	Description

SHEET TITLE:
**INTERIOR FINISHES
SCHEDULES**
SCALE: AS SHOWN

SHEET NUMBER:
1602

PERMIT SET - FOR CONSTRUCTION USE



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STARBUCKS TEMPLATE VERSION: i2024.01.01

PABLO **SPACE RESERVED FOR ARCHITECT OF RECORD STAMP** R99297

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Revision Schedule			
Rev	Date	By	Description

SHEET TITLE:
**STRUCTURAL GENERAL
NOTES**
SCALE: AS SHOWN

SHEET NUMBER:
S001

PERMIT SET - FOR CONSTRUCTION USE

ARCHITECT OF RECORD TO ADD
STRUCTURAL SPECIFICATION
INFORMATION AS REQUIRED

STRUCTURAL NOTES

GENERAL NOTES

- GN-1 The governing Code for this Project is the Florida Building Code, 8th Edition (2023). This Code prescribes which edition of each referenced standard applies to this Project.
- GN-2 To the best of our knowledge, the Structural Drawings and Specifications comply with the applicable requirements of the governing Building Code.
- GN-3 Construction is to comply with the requirements of the governing Building Code and all other applicable Federal, State, and Local Codes, Standards, Regulations and Laws.
- GN-4 Use these Notes in conjunction with the Plan Specifications or Project Specifications. If a conflict exists, the more stringent governs.
- GN-5 See Plan Specifications for testing.
- GENERAL NOTES - CONTRACTOR REQUIREMENTS
- GN-6 Contractor refers to the General Contractor, Construction Manager, or the organization that is assigned to have overall responsibility and supervision of the Project.
- GN-7 The Contractor shall be solely responsible for, and have control over, the means, methods, supervision, techniques, sequences, procedures of construction, quality, and correctness of the work. The Contractor is solely responsible for jobsite safety including all OSHA requirements.
- GN-8 The Contractor shall coordinate all Contract Documents with field conditions and dimensions and Project Shop Drawings prior to construction. Do not scale drawings; use only printed dimensions. Report any discrepancies in writing to the Architect prior to proceeding with work. Do not change size or location of structural members without written instructions from the Structural Engineer of Record.
- GN-9 Contractors who discover discrepancies, omissions or variations in the Contract Documents during bidding shall immediately notify the Architect. The Architect will resolve the condition and issue a written clarification.
- GN-10 The Contractor shall protect adjacent property, his own work and the public from harm. The Contractor is advised to document the condition of adjacent property with a photographic survey and other documentation, including crack monitoring, prior to and during construction.

GENERAL NOTES - DRAWINGS

- GN-11 The Structural drawings shall be used in conjunction with the architectural drawings and all other drawings and documents, including shop drawings prepared by equipment suppliers and delegated engineers.
- GN-12 Openings shown on Structural Drawings are only pictorial. See the Architectural for complete information such as slab depressions, slopes, curbs, finishes, and opening locations in structural members as required by MEP systems and architectural elements.
- GN-13 Details labeled "typical" apply to all situations that are the same or similar to those specifically referenced, whether or not they are keyed in at each location. Questions regard-ing the applicability of typical details shall be resolved by the Architect.
- GN-14 See Architectural drawings for fireproofing and waterproofing details and requirements.

GENERAL NOTES - DESIGN LOADS

GN-15 Design Loads:

OCCUPANCY	LIVE LOAD	DEAD LOAD	CONCENTRATED LOAD
Retail	75 psf	20 psf	1,000#

Design superimposed dead loads listed above do not include masonry walls or other concentrated loads. See architectural drawings for these loads. Concentrated live loads do not act concurrently with area live loads.

GN-16 Handrails and Guards:

Loads shall be applied to act in any direction at any point on the handrail or top rail to produce the maximum load effect. Linear and concentrated loading shall not be applied concurrently. Glass in handrails and guards shall be designed with a safety factor of 4.

SHOP DRAWINGS AND OTHER SUBMITTALS

- SD-1 Refer to the applicable Plan Specifications or Project Specifications for technical content requirements. Incomplete submittals will be returned without review.
- SD-2 Submit specific components, such as columns, footings, etc., in a single package. Submit similar floors together.
- SD-3 On first submittal, clearly flag and cloud all differences from the Contract Documents. On resubmittals, flag and cloud all changes and additions to previous submittal; only clouded items will be reviewed.
- SD-4 The Trade Contractor is responsible for confirming and correlating dimensions at the job sites, for tolerances, clearances, quantities, fabrication processes and techniques of construction, coordination of the work with other trades and full compliance with the Contract Documents.
- SD-5 The Contractor shall review and approve submittals, including substitution requests and shop drawings, and shall sign and date each drawing prior to submitting to the Architect. This approval is to confirm that the submittal is complete, complies with the submittal requirements and is coordinated with field dimensions, other trades, erection sequencing and constructability. Submittals not reviewed by the Contractor will be returned without review.
- SD-6 Bliss & Nyitray (BNI) reviews submittals to confirm that the submittal is in general conformance with the design concept presented in the Contract Documents. Quantities and dimensions are not checked. Notations on submittals do not authorize changes to the contract sum. Checking of the submittal by BNI shall not relieve the Contractor of responsibility for deviations from the Contract Documents and from errors or omissions in the submittal.

SD-7 BNI may transfer to the Contractor BIM files, CAD files or other electronic data for use in preparing Shop Drawings. The contractor shall email a request for BIM or CAD files along with an acknowledgement that he/she has read and agreed to the following terms and conditions:

- This electronic data remains the property of BNI, and in no case shall the transfer of these files be considered a sale. The files shall not be used for other projects, additions to this project, or for completion of this project by others.
- The Contractor is responsible for assuring that the electronic data accurately represents the Contract Documents. In the event of a conflict, the Contract Documents shall govern.
- The electronic data is current as of the date of transfer but may subsequently be revised or supplemented. If so, then the Contractor may request updated electronic data.
- The use of these electronic data shall not modify Contractor's responsibility for coordination with other trades, or for the proper checking and coordination of dimensions, details, member sizes and gage, and quantities of materials to facilitate complete and accurate fabrication and erection.
- Do not scale dimensions since the electronic data may not be precise and, in some cases, have been intentionally altered for presentation purposes.
- Contractor shall indemnify, defend and hold harmless BNI from all claims, damages, losses, expenses, penalties, and liabilities, including attorneys' fees, arising out of or resulting from the use of the electronic data by Contractor or others.

POST-INSTALLED ANCHORS - GENERAL

- AN-1 Substitution requests will be considered for products having an ICC-ES report recognizing the product for the appropriate application. Substitute concrete anchors must be approved for use in cracked concrete. Substitution requests shall include signed and sealed calculations prepared by a Florida Licensed Engineer who demonstrates that substituted product is capable of achieving the equivalent performance values of the design basis product.
- AN-2 Confirm the absence of reinforcing steel by drilling a 1/4" diameter pilot hole for each anchor in non-post-tension applications. For post-tensioned slabs, confirm the absence of reinforcing steel by nondestructive testing prior to drilling holes. Do not cut reinforcing steel without approval of the Structural Engineer.
- AN-3 Install in accordance with manufacturer's printed installation instructions (MPII) (ACI 314-19, 26.7.2). Refer to MPII for appropriate drill size. Clean hole and remove dust.
- AN-4 Anchors listed below may not be used to substitute the specified anchors in a product's Notice of Acceptance (NOA) or Florida Product Approval.
- AN-5 Anchors shall be installed in concrete having a minimum age of 21-days at time of anchor installation (ACI 318-19, 26.7.2(f))

POST-INSTALLED ANCHORS - MECHANICAL ANCHORS

AN-6 For anchoring into concrete: Wedge-Type Mechanical anchors shall have been tested and qualified for use in accordance with ACI 355.2 and ICC-ES AC193. Pre-approved anchors include Hilti Kwik Bolt TZ, DeWalt Power-Stud+SD1, and Simpson Strong-Bolt 2.

POST-INSTALLED ANCHORS - SCREW ANCHORS

AN-7 For anchoring into concrete: Screw anchors shall have been tested and qualified for use in accordance with ACI 355.2 and ICC-ES AC193. Pre-approved anchors include the 1/4" Ø Hilti KH-EZ and the 1/4" Ø DeWalt Screw Bolt +.

POST-INSTALLED ANCHORS - ADHESIVE ANCHORS

- AN-8 Install adhesive anchors in accordance with manufacturer's requirements for concrete age, temperature, moisture condition, acceptable drilling methods, and hole preparation in conformance with ACI 318-19, 26.7.1(i).
- AN-9 For anchoring into concrete: Adhesive anchors shall have been tested and qualified for use in accordance with ACI 355.4 and ICC-ES AC308. Pre-approved standard cure time adhesives include Hilti RE500v3, DeWalt Pure 110+, and Simpson Set-XP.
- AN-10 Threaded rods for use with adhesive are galvanized ASTM F1554 Grade 36 U.O.N.

LIGHT GAUGE STEEL FRAMING (LTGFRM)

- LG-1 Fabricate and erect stud construction in accordance with the "Standard for Cold-Formed Steel Framing-General Provisions", American Iron and Steel Institute and General Notes.
- LG-2 Light gauge steel framing shall be formed from steel having a galvanized coating meeting the requirements of ASTM A653. Yield strength for 16 GA (54mil) or heavier shall be 50ksi and for 18 GA (43mil) and lighter shall be 33ksi. Alternatively, yield strength for 18mil may be 70ksi to achieve a 20 GA equivalent.
- LG-3 Use galvanized steel Track, minimum 350T137-33 for 4" walls and 600T137-33 for 6" walls, at top and bottom light gauge wall studs fastened to each stud with #10 tek screws each side of wall.
- LG-4 Splicing of framing components, other than the continuous track at the top and bottom of walls, is not permitted, u.o.n. Splicing of track used in the construction of the jamb, head, or sill assemblies of framed wall openings is not permitted. Where splicing of track is necessary between stud spacings, a section of stud shall be placed on the adjoining tracks across the joint fastened to the flanges at both sides of the wall. Holes or notches in headers are not permitted unless approved in writing by the Engineer of Record or as shown on the drawings.
- LG-5 Use 0.157" diameter power actuated fasteners with a minimum of 1" embedment spaced at 24" o.c., U.O.N.
- LG-6 Screws, where required, shall meet the minimum requirements of SAE J-429 Grade 5 and IFI-105. Screws shall have a protective coating equivalent to cadmium or zinc plating, ASTM B766.

Field cutting of LTGFRM framing members shall be saw or shear. Torch cutting is not permitted.

STRUCTURAL PLAN SPECIFICATIONS

GENERAL NOTES

SGN-1 These Plan Specifications are intended to be used for projects without Project Specification Books. If they are accidentally issued along with a Project Specification Books, the Project Specification Books shall supersede the Plan Specifications.

RISK CATEGORY	1.0 MULTPLIER	0.60 MULTPLIER	0.42 MULTPLIER
Risk Category II	700 YEAR MRI	50-YEAR MRI	25-YEAR MRI

SHOP DRAWINGS AND SUBMITTALS

- SSD-1 Material substitution shall not be submitted in the shop drawings without a substitution request being made to the Architect in advance and in writing, along with detailed substitution cost savings to be credited to the Owner. Upon approval by the Architect, the material substitution can be included in the submitted shop drawings.
- SSD-2 All structural Shop Drawings shall be submitted in PDF format to BNI for review and approval. Submittals shall be reviewed and electronically stamped by the Contractor as having "No Exception Taken".
- SSD-3 Manufacturer Literature and Product Data shall be submitted in PDF format. The submittals will be stamped as "Received, for record only" by BNI and returned accordingly.



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PROJECT NAME:
A1A & 10TH

PROJECT ADDRESS:
**975 3RD STREET SOUTH
JACKSONVILLE BEACH, FL
32250**

STORE #: 8565
PROJECT #: 18756-108
ISSUE DATE: 03-27-2024
DESIGN MANAGER: ES
PRODUCTION DESIGNER: RV
CHECKED BY: AP

Revision Schedule			
Rev	Date	By	Description

SHEET TITLE:
STRUCTURAL NOTES


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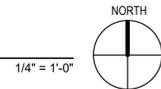


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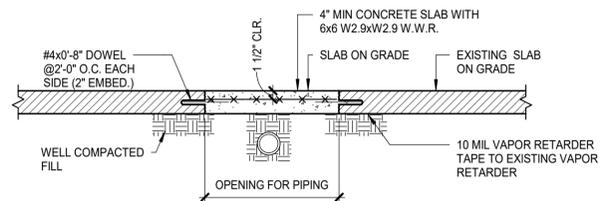


FIRST LEVEL



- PLAN KEYNOTES:**
- 1 INTERIOR LIGHT GAUGE STUDS PER S3.01. SEE ARCH FOR WIDTH AND HEIGHT.

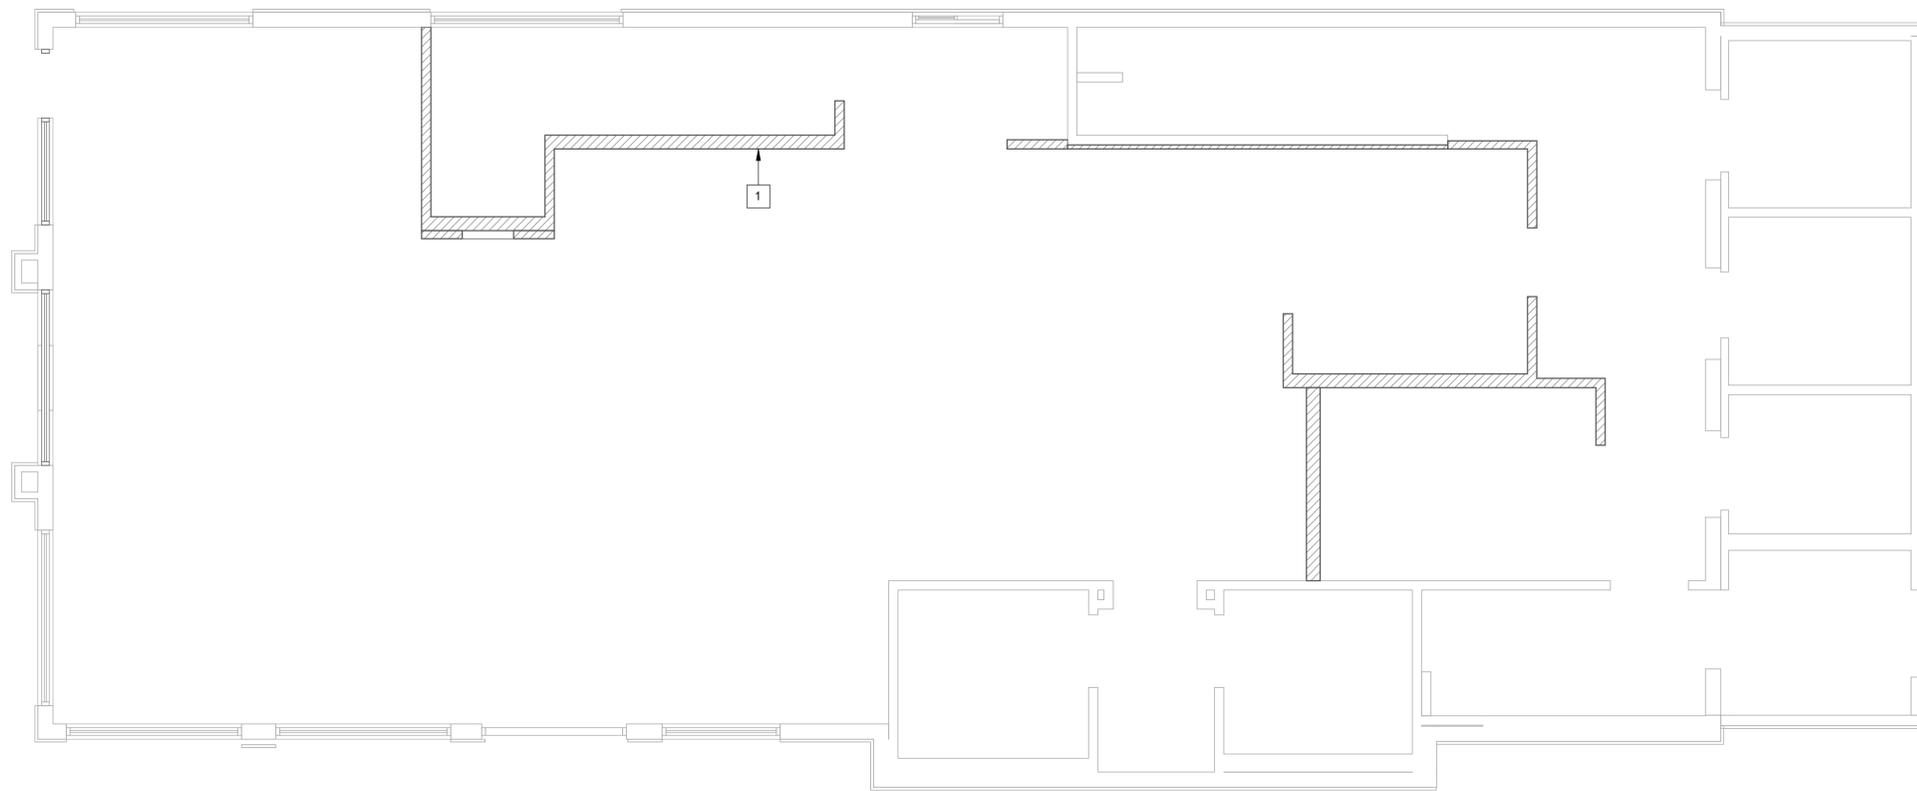NOTE:
 TERMITE PROTECTION SHALL BE PROVIDED WITH REGISTERED TERMITICIDES. UPON COMPLETING THE APPLICATION OF THE TERMITE PROTECTIVE TREATMENT, A CERTIFICATE OF COMPLIANCE SHALL BE ISSUED TO THE BUILDING DEPARTMENT BY THE LICENSED PEST CONTROL COMPANY THAT CONTAINS THE FOLLOWING STATEMENT, "THE AREAS UNDERNEATH NEW SLABS-ON-GRADE HAVE RECEIVED A COMPLETE TREATMENT FOR THE PREVENTION OF SUBTERRANEAN TERMITES. TREATMENT IS IN ACCORDANCE WITH RULES AND LAWS ESTABLISHED BY THE FLORIDA DEPARTMENT OF AGRICULTURE AND CONSUMER SERVICES." REFER TO FBC SECTION 1816 FOR ADDITIONAL INFORMATION.



1 TRENCH REPAIR DETAIL
 AS REQ'D BY ARCHITECT
 3/4" = 1'-0"



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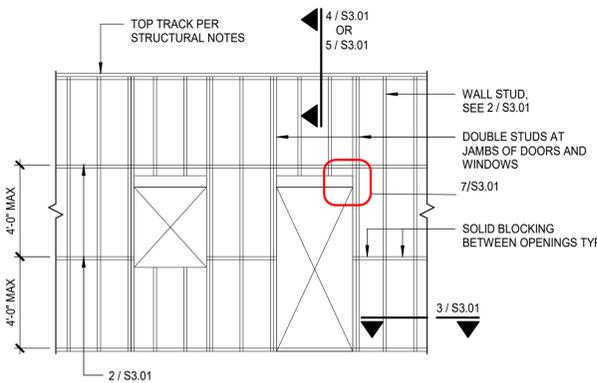
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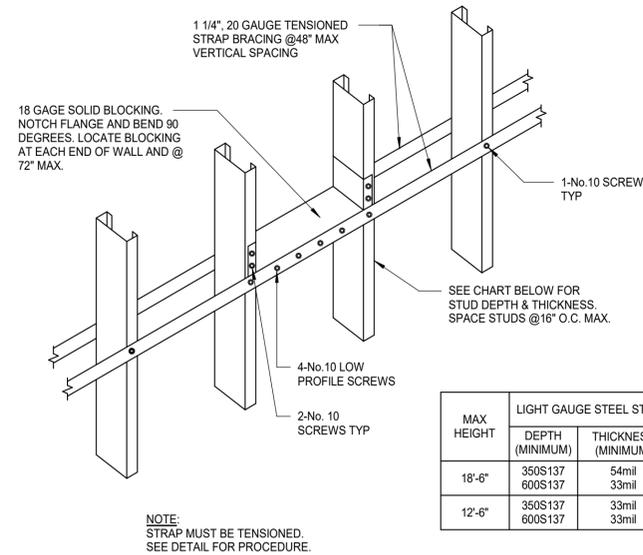
SHEET TITLE:
SLAB ON GRADE PLAN & DETAILS
 SCALE: AS SHOWN

SHEET NUMBER:
S2.00

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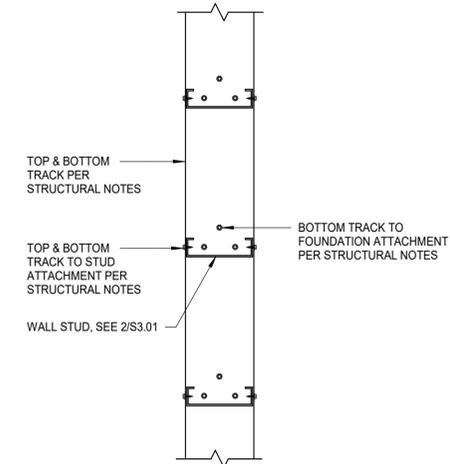


1 TYPICAL LIGHT GAGE WALL FRAMING
1 1/2" = 1'-0"




2 INTERIOR STUD WALL HORIZONTAL BRIDGING
1 1/2" = 1'-0"


MAX HEIGHT	LIGHT GAUGE STEEL STUD	
	DEPTH (MINIMUM)	THICKNESS (MINIMUM)
18'-6"	350S137 600S137	54mil 33mil
12'-6"	350S137 600S137	33mil 33mil




3 LIGHT GAGE STEEL TRACK CONNECTION
PLAN VIEW
1 1/2" = 1'-0"

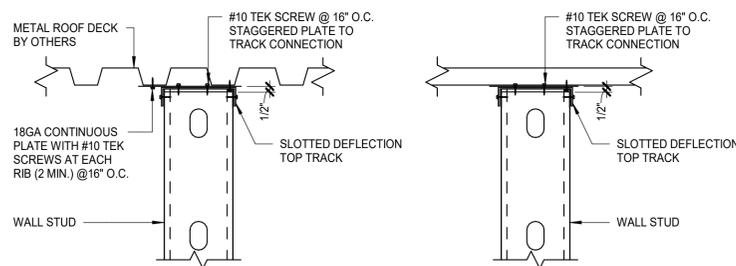


4 TOP OF INTERIOR WALL NON-LOAD BEARING TO ROOF DECK
1 1/2" = 1'-0"

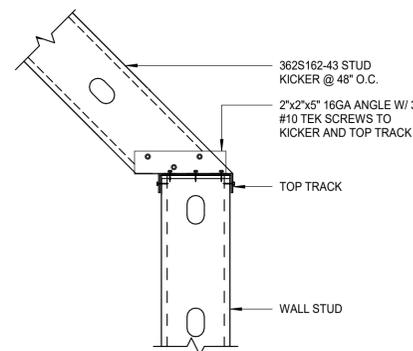


5 LIGHT GAGE KICKER CONNECTION AT TOP OF WALL FRAMING
1 1/2" = 1'-0"

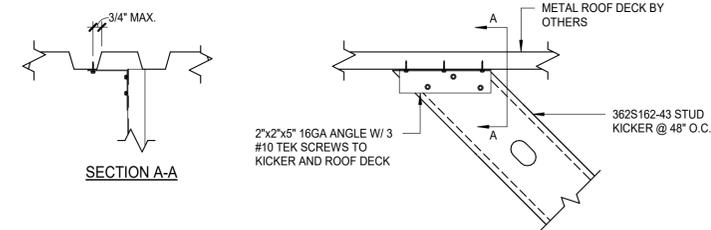

6 LIGHT GAGE KICKER CONNECTION AT BOTTOM OF ROOF FRAMING
1 1/2" = 1'-0"

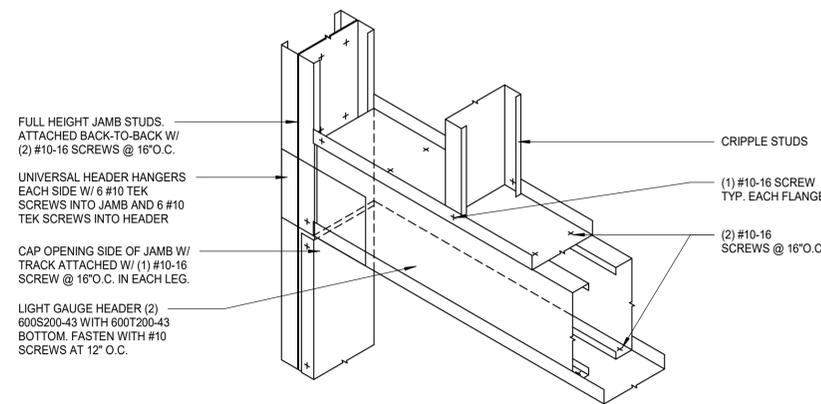

7 LIGHT GAGE HEADER
3/4" = 1'-0"

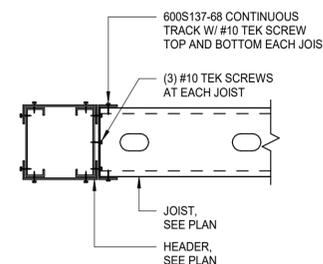


8 JOIST TO HEADER ATTACHMENT
1 1/2" = 1'-0"



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SHEET TITLE:
LIGHT GAUGE DETAILS

SCALE: AS SHOWN

SHEET NUMBER:
S3.01
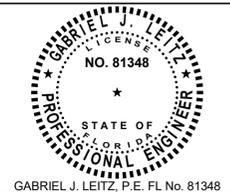
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ABBREVIATIONS

AFF	ABOVE FINISHED FLOOR
AHJ	AUTHORITIES HAVING JURISDICTION
APPROX	APPROXIMATE
BLDG	BUILDING
CKT	CIRCUIT
CLG	CEILING
CM	STARBUCKS CONSTRUCTION MANAGER
CONST	CONSTRUCTION
CW	COLD WATER
CXA	COMMISSIONING AGENT
DEG	DEGREES
DL	LIGHTS WITHIN DAYLIGHT ZONE
DM	STARBUCKS DESIGN MANAGER
DN	DOWN
DTL	DETAIL
DWG(S)	DRAWING(S)
EA	EACH
EC	ELECTRICAL CONTRACTOR
ECP	EQUIPMENT CONTROL PAC
EG	EXHAUST GRILLE
ELEC	ELECTRICAL
EM	EMERGENCY
EMS	ENERGY MANAGEMENT SYSTEM
EXIST	EXISTING
EXT	EXTERIOR
F&I	FURNISH & INSTALL
FOIC	FURNISHED BY OWNER, INSTALLED BY CONTRACTOR
FOIO	FURNISHED BY OWNER, INSTALLED BY OWNER
FLR	FLOOR
FT	FOOT/FEET
GC	GENERAL CONTRACTOR
GFCI	GROUND FAULT CIRCUIT INTERRUPTER
GND	GROUND
HR	HOUR
HVAC	HEATING, VENTILATION, AIR CONDITIONING
HW	HOT WATER
LCP	LIGHTING CONTROL PANEL
LL	LANDLORD
LS	LIGHT SENSOR PHOTOCELL
LV	LOW VOLTAGE
MAX	MAXIMUM
MC	MECHANICAL CONTRACTOR
MDP	MAIN DISTRIBUTION PANEL
MECH	MECHANICAL
MEP	MECHANICAL, ELECTRICAL, AND PLUMBING
MFG	MANUFACTURER
MIN	MINIMUM
NL	NIGHTLIGHT
NTS	NOT TO SCALE
OCP	OVERCURRENT PROTECTION
PIR	PASSIVE INFRARED SENSOR
REF	REFERENCE
REQ(D)	REQUIRE(D)
REV	REVISION
SF	SQUARE FEET
SHT	SHEET
SPECS	SPECIFICATION(S)
SST	STAINLESS STEEL
TEL	TELEPHONE
TEMP	TEMPORARY
TYP	TYPICAL
UC	UNDER COUNTER
UNO	UNLESS NOTED OTHERWISE
WH	WATER HEATER
WP	WEATHER PROOF

ELECTRICAL SYMBOL LEGEND

Ⓝ	JUNCTON BOX	Ⓝ	RECEPTACLE: DUPLEX
Ⓢ	SWITCH	Ⓝ	RECEPTACLE: DUPLEX - INDIVIDUAL BRANCH CIRCUIT
Ⓢ3	THREE-WAY SWITCH	Ⓝ	RECEPTACLE: QUAD
ⓈM	MOTION (OCCUPANCY) SENSOR SWITCH	Ⓝ	RECEPTACLE: QUAD - INDIVIDUAL BRANCH CIRCUIT
Ⓢ	SWITCHBACK	Ⓝ	RECEPTACLE: HIGH VOLTAGE
▼	TELEPHONE	Ⓝ	RECEPTACLE: FLOOR DUPLEX
Ⓢ	THERMOSTAT	Ⓝ	GROUNDING ELECTRODE CONNECTION
Ⓢ	THERMOSTAT SENSOR	NL	NIGHTLIGHTING 24HR/DAY
Ⓢ	DIMMER SWITCH	Ⓝ	PHOTOELECTRIC CELL
Ⓢ	RECEPTACLE: DATA	Ⓝ	SPEAKER
Ⓢ	RACEWAY CONCEALED IN CEILING OR WALL. HASH MARKS INDICATE NUMBER OF WIRES. #12 AWG WIRE UNLESS OTHERWISE NOTED. TWO WIRES PLUS GROUND IF NO HASH MARKS SHOWN. LONG HASH MARK DENOTES NEUTRAL. GROUND WIRE NOT SHOWN.	Ⓝ	WIFI ACCESS POINT
		Ⓝ	360 CAMERA
		Ⓝ	CARBON MONOXIDE SENSOR
		Ⓝ	CARBON DIOXIDE SENSOR

FIRE ALARM SYSTEM NOTES

IF STARBUCKS IS REQUIRED TO PROVIDE A FIRE ALARM AND/OR FIRE ALARM MONITORING AND/OR PHONE LINES FOR A FIRE ALARM, AS SPECIFIED IN THE LEASE AGREEMENT, THE CONTRACTOR IS TO NOTIFY GNOC IMMEDIATELY THAT FIRE ALARM LINES ARE NEEDED. STARBUCKS PREFERRED FIRE ALARM SERVICE PROVIDER, STANLEY, IS TO BE CONTACTED BY THE CONSTRUCTION MANAGER TO INSTALL FIRE ALARM PANEL AND/OR MONITORING SERVICE AS REQUIRED.

CARBON MONOXIDE (CO) DETECTOR NOTES

COORDINATE INSTALLATION OF CARBON MONOXIDE (CO) DETECTOR DEVICE(S) AND LOW VOLTAGE WIRING WITH STARBUCKS SECURITY VENDOR FOR NEW STORES, RELOCATIONS AND MAJOR RENOVATIONS. VENDOR TO FURNISH AND INSTALL DEVICE(S) IN BOH AND FOH (AS APPLICABLE PER STARBUCKS STANDARDS). GC TO PROVIDE ROUGH-IN FOR SENSORS.

LANDLORD REQUIREMENTS

PRIOR TO BID: THE CONTRACTOR SHALL COORDINATE WITH LANDLORD / BUILDING OWNER FOR ANY CONSTRUCTION REQUIREMENTS. IF LANDLORD / BUILDING OWNER DOES HAVE REQUIREMENTS, CONTRACTOR SHALL BECOME COMPLETELY FAMILIAR WITH REQUIREMENTS AND ADHERE TO THEM. WHERE LANDLORD / BUILDING OWNER REQUIREMENTS ARE MORE STRINGENT THAN SHOWN IN THESE PLANS (IN THE OPINION OF THE ENGINEER), LANDLORD / BUILDING OWNER REQUIREMENTS SHALL GOVERN.

SYSTEM COMMISSIONING

CONTRACTOR RESPONSIBILITIES FOR BUILDING COMMISSIONING

CONTRACTOR SHALL PROVIDE SUPPORT AND WORK AS SPECIFIED, NEEDED AND REQUIRED TO CONDUCT AND FACILITATE STARBUCKS STAFF BUILDING COMMISSIONING EFFORTS. THIS WORK WILL BE COMPRISED OF THREE DISTINCT EFFORTS:

- 1) SUPPORT STARBUCKS COMMISSIONING AGENT (CXA) DURING INSTALLATION VERIFICATION AND CORRECT DISCLOSED DEFICIENCIES;
- 2) PERFORM TESTING, ADJUSTING, BALANCING AND SYSTEM STARTUP AND SUPPORT FUNCTIONAL PERFORMANCE TESTING BY STARBUCKS CXA;
- 3) CORRECT DEFICIENCIES DISCLOSED BY FUNCTIONAL PERFORMANCE TESTING AND SUBMIT REPORTS. CONTRACTOR SHALL PERFORM AND PROVIDE THE FOLLOWING:

A. SYSTEMS SUBJECT TO COMMISSIONING MAY INCLUDE , BUT ARE NOT LIMITED TO DOMESTIC HOT WATER GENERATION, HVAC SYSTEMS, ROOFTOP UNITS, EXHAUST FANS, HVAC CONTROLS, LIGHTING CONTROLS AND AIR CURTAINS.

B. CONTRACTOR SHALL INCLUDE COMMISSIONING ACTIVITIES IN PROJECT SCHEDULE AND SHOW INTERVALS FOR PERFORMANCE OF WORK FOR WHICH CONTRACTOR IS RESPONSIBLE AND INTERVALS FOR WORK PERFORMED BY STARBUCKS CXA. CONTRACTOR SHALL SHOW RESOURCES FOR PERFORMING ALL WORK RELATED TO COMMISSIONING ACTIVITIES ON A LINE ITEM IN THE SCHEDULE OF VALUES.

C. CONTRACTOR SHALL INSTALL EQUIPMENT IN ACCORDANCE WITH THE MANUFACTURER 'S REQUIREMENTS AND ALL CONTRACT DOCUMENTS. ENSURE THAT ALL EQUIPMENT IS INSTALLED TOTALLY COMPLETE, AND ACCESSIBLE TO STARBUCKS CXA FOR INSTALLATION VERIFICATION AND FUNCTIONAL PERFORMANCE TESTING PRIOR TO THE SCHEDULED START OF INSTALLATION VERIFICATION.

D. INSTALLATION VERIFICATION SHALL BE PERFORMED BY STARBUCKS CXA. CONTRACTOR SHALL SUPPORT STARBUCKS CXA INSTALLATION VERIFICATION EFFORTS AS NECESSARY. PROVIDE ALL ACCESS AND EQUIPMENT NECESSARY FOR STARBUCKS STAFF TO VERIFY THAT THE EQUIPMENT IS INSTALLED CORRECTLY.

E. CONTRACTOR SHALL BE READILY AVAILABLE DURING INSTALLATION VERIFICATION TO CORRECT ANY DEFICIENCIES OR DEFECTS DISCLOSED BY THE INSTALLATION VERIFICATION PROCESS. CORRECTIONS SHALL BE MADE IN A TIMELY MANNER WITHOUT DISRUPTION OF THE CONSTRUCTION SCHEDULE.

F. ALL HVAC, EXHAUST FAN, AND AIR CURTAIN EQUIPMENT SHALL BE TESTED, ADJUSTED AND BALANCED BY THE CONTRACTOR 'S TESTING, ADJUSTING AND BALANCE AGENT(SEE TESTING, ADJUSTING AND BALANCING) AFTER THE SYSTEM IS VERIFIED TO BE COMPLETE AND CORRECT BY STARBUCKS CXA, IN ACCORDANCE WITH THE REQUIREMENTS OF THESE DOCUMENTS. ALL HVAC CONTROL SYSTEMS SHALL BE TESTED TO ENSURE THAT CONTROL DEVICES, COMPONENTS, EQUIPMENT AND SYSTEMS ARE CALIBRATED, ADJUSTED AND OPERATE IN ACCORDANCE WITH THESE PLANS AND PROJECT MANUAL. SEQUENCES OF OPERATION SHALL BE TESTED TO ENSURE THAT THEY OPERATE IN ACCORDANCE WITH THE CONTRACT REQUIREMENTS. DELIVERABLES: PRELIMINARY, WRITTEN TESTING AND AIR BALANCE REPORT CONFORMING TO THE REQUIREMENTS SPECIFIED HEREIN, DOCUMENTING THE INFORMATION SPECIFIED, ETC. TO THE STARBUCKS CXA IMMEDIATELY UPON COMPLETION OF THE WORK.

G. CONTRACTOR SHALL INFORM STARBUCKS CXA WHEN EQUIPMENT IS READY FOR FUNCTIONAL PERFORMANCE TESTING. ALL EQUIPMENT SHALL BE READY FOR FUNCTIONAL PERFORMANCE TESTING PRIOR TO STARTING TESTING. CONTRACTOR SHALL OPERATE EQUIPMENT FOR STARBUCKS CXA AND VERIFY BY DEMONSTRATION THE CORRECT OPERATION OF EQUIPMENT, RESPONSE OF SENSORS, AND PROPER EXECUTION OF HVAC CONTROL AND LIGHTING SEQUENCES; INCLUDING BUT NOT LIMITED TO: AIR MOVEMENT, TEMPERATURE, SOUND, AND CONTROL RESPONSE. PROVIDE ANY SECURITY ACCESS, HARDWARE, SOFTWARE, OR OTHER SUPPORT AS NEEDED FOR THE STARBUCKS CXA TO EFFICIENTLY WITNESS AND DOCUMENT ALL EQUIPMENT TESTING. STARBUCKS CXA WILL RECORD THE EQUIPMENT OPERATION AND RESPONSE TO TESTING SEQUENCES AND PREPARE A LIST OF ANY DEFICIENCIES DISCLOSED BY THE FUNCTIONAL PERFORMANCE TESTS FOR CORRECTION BY THE CONTRACTOR. EQUIPMENT INCLUDES, BUT IS NOT LIMITED TO, AIR HANDLING UNITS, ROOFTOP AND SPLIT TYPE, CONDENSING UNITS, EXHAUST FANS, LIGHTING CONTROLS, ETC. DELIVERABLES: PROVIDE COMPLETED COPIES OF ALL START UP REPORTS, FILLED OUT ON THE MANUFACTURER'S FORMS, TO THE STARBUCKS CXA.

H. CONTRACTOR IS RESPONSIBLE FOR CORRECTING ANY ISSUES OR DEFICIENCIES DISCLOSED DURING THE FUNCTIONAL PERFORMANCE TESTING PROCESS. CORRECTIONS SHOULD BE MADE IN A TIMELY MANNER WITHOUT DISRUPTION TO THE SYSTEM AND CONSTRUCTION SCHEDULE.

I. CONTRACTOR SHALL BE READILY AVAILABLE FOR ANY RE-TESTING OF EQUIPMENT DEEMED NECESSARY BY STARBUCKS CXA DURING INSTALLATION VERIFICATION AND FUNCTIONAL PERFORMANCE TESTING. CONTRACTOR IS RESPONSIBLE FOR CORRECTING ANY ISSUES OR DEFICIENCIES FOUND IN THE SYSTEM DURING ANY AND ALL RE-TESTING. CORRECTIONS SHOULD BE MADE IN A TIMELY MANNER WITHOUT DISRUPTION TO THE SYSTEM AND CONSTRUCTION SCHEDULE. DELIVERABLES: FINAL BALANCE REPORT, DEFICIENCIES LIST NOTING CORRECTIVE ACTION REQUIRED BY CONTRACTOR IN RESPONSE TO INSTALLATION VERIFICATION AND FUNCTIONAL PERFORMANCE TEST RESULTS.

J. CONSTRUCTION AND POST CONSTRUCTION TESTING: ADDITIONAL TESTING MAY BE REQUIRED AND OTHER PROCESSES THAT MAY OCCUR OUT OF SEQUENCE WITH COMMISSIONING SERVICE. CONTRACTOR SHALL CONDUCT, DOCUMENT, SUPPORT AND SCHEDULE THIS TESTING AS DIRECTED BY STARBUCKS CXA.

SECURITY SYSTEM NOTES

STARBUCKS CONTRACTS DIRECTLY WITH SECURITY VENDOR TO SUPPLY AND INSTALL THE SECURITY SYSTEM. CONTRACTOR TO SCHEDULE INSTALLATION OF SECURITY SYSTEM FOR FOUR (4) TIMES:

1. MEET TO PLAN SECURITY CABLE PULL WITH SECURITY CABLE INSTALLER PRIOR TO DRYWALL INSTALLATION.
2. SECURITY CABLE INSTALLER PULLS SECURITY CABLES, MOUNTS PANEL, KEYPAD AND SENSORS.
3. SECURITY EQUIPMENT INSTALL OF CAMERA, NVR AND MONITOR.
4. SECURITY MONITORING COMPANY TO BRING SYSTEM ONLINE AND TRAIN PARTNERS AFTER POS INSTALL.

SECURITY VENDOR REQUIRES A MINIMUM TWO (2) WEEKS LEAD TIME FOR EACH INSTALLATION. SECURITY VENDOR WILL COORDINATE REGIONAL INSTALLERS. ALL ADDITIONAL EXPENSES INCURRED DUE TO THE CONTRACTOR'S FAILURE TO SCHEDULE ACCORDINGLY WILL BE THE RESPONSIBILITY OF THE CONTRACTOR.

TELEPHONE SYSTEM NOTES

IF ADDITIONAL TELEPHONE LINES ARE REQUIRED BEYOND THE STANDARD SINGLE LINE (SUCH AS FOR A FIRE ALARM) THE GENERAL CONTRACTOR SHALL CONTACT THE STARBUCKS CONSTRUCTION MANAGER PRIOR TO BEGINNING CONSTRUCTION TO ORDER THE ADDITIONAL TELEPHONE LINE(S). REPORT ANY TELEPHONE INSTALLATION ISSUES IMMEDIATELY TO THE STARBUCKS CONSTRUCTION MANAGER.

CONFIRM PRIOR TO BEGINNING CONSTRUCTION THAT THERE ARE EXISTING, WORKING TELCO FACILITIES TO THE BUILDING OR THAT LANDLORD HAS PROVIDED AND INSTALLED ONE (1) 2" (51MM) MIN. (ENTRANCE) CONDUIT INCLUDING PULL STRING FROM TELCO STREET FEED LINE TO THE BUILDING AS IDENTIFIED BY THE PHONE COMPANY. NOTIFY STARBUCKS CONSTRUCTION MANAGER IMMEDIATELY IF FACILITIES OR CONDUIT AND PULL STRING ARE NOT INSTALLED.

GENERAL CONTRACTOR IS TO ENSURE THAT THERE IS A 2" (51MM) MIN. CONDUIT WITH PULL STRING FROM THE DATA RACK TO THE DEMARC (TELCO TO CUSTOMER HAND OFF EQUIPMENT) WHEN THE DEMARC IS MORE THAN 10' FROM THE DATA RACK. DISTANCES LESS THAN 10' WILL NOT REQUIRE CONDUIT.

PROVIDE A 3-POSITION GROUND LUG, GROUNDING WITH #6 AWG GROUND WIRE, IF REQUIRED BY TELEPHONE COMPANY.

ALL TELEPHONE/NETWORK CABLING IS THE SCOPE OF WORK OF THE TELEPHONE/NETWORK CABLING VENDOR.

POS \ DATA LINE NOTES

STARBUCKS CONTRACTS DIRECTLY WITH THE DATA CABLING VENDOR TO SUPPLY AND INSTALL CATEGORY 5e (CAT5e) LAN CABLE AND CONNECTORS FOR THE POINT OF SALE (POS) SYSTEMS. CONTRACTOR TO SCHEDULE INSTALLATION OF DATA CABLING WITH DATA CABLING VENDOR. DATA CABLING VENDOR REQUIRES A LEAD TIME FOR INSTALLATION. DATA CABLING VENDOR WILL COORDINATE REGIONAL INSTALLERS.

AT THE START OF CONSTRUCTION, STARBUCKS CONSTRUCTION MANAGER SCHEDULES DELIVERY OF CASH REGISTER/MANAGER'S WORKSTATION EQUIPMENT AND INSTALLATION BY A POS INSTALL TECHNICIAN FOR ONE (1) MONTH PRIOR TO STORE OPEN. CONTRACTOR TO VERIFY DELIVERY SCHEDULE TWO (2) WEEKS PRIOR TO DELIVERY AND INSTALLATION DATE. EQUIPMENT IS SHIPPED DIRECTLY TO THE STORE. CONTRACTOR TO ACCEPT POS EQUIPMENT DELIVERY. DO NOT REFUSE DELIVERY.

DATA CABLING TECHNICIAN TO PROVIDE ALL CAT5e LAN CABLING AND CONNECTORS FROM ALL DESIGNED AND FUTURE CASH REGISTER LOCATIONS, MANAGER'S WORKSTATION, ALL OTHER NETWORKED EQUIPMENT (CUP LABELERS, CLOVER, BUMP BAR, ETC..) AND WIRELESS ACCESS POINT TO THE DATA RACK AREA. CONTRACTOR IS TO HAVE CONDUIT WITH PULL STRING IN PLACE FOR ALL CABLE RUNS PRIOR TO CABLE INSTALL DATE.

STARBUCKS NEW STORE GROUP IS RESPONSIBLE FOR COORDINATING STARBUCKS POS SYSTEMS DELIVERY AND INSTALLATION WITH THE POS VENDOR. THIS GROUP MAY BE CONTACTED AT: NEWSTORES@STARBUCKS.COM.

COMMUNICATION SYSTEM NOTES

CONFIRM PRIOR TO BEGINNING CONSTRUCTION THAT THE LANDLORD HAS FURNISHED AND INSTALLED ONE (1) ADDITIONAL 2" (51MM) (ENTRANCE) CONDUIT INCLUDING PULL STRING (FOR A TOTAL OF TWO (2)) FROM THE STREET FEED TO THE BUILDING AS IDENTIFIED BY THE INTERNET SERVICE PROVIDER.

WIRELESS NETWORK NOTES

CABLING FOR INTERNET SERVICE SHALL BE FURNISHED AND INSTALLED BY THE VENDOR FOR FIBER OR BROADBAND CONNECTIONS. T1 AND ETHERNET EXTENSION CABLING IS PROVIDED BY THE STARBUCKS (TELEPHONE/ NETWORK) CABLING VENDOR. COORDINATE WITH STARBUCKS.

MUSIC SYSTEM NOTES

MOUNT OWNER FURNISHED SPEAKERS WHERE SHOWN ON INTERIOR REFLECTED CEILING PLANS AND IN COORDINATION WITH ALL PLANS, DETAILS AND MANUFACTURER'S INSTALLATION REQUIREMENTS. INSTALL AND CONNECT OWNER FURNISHED WIRING SYSTEM BETWEEN ALL SPEAKERS AND THE OWNER PROVIDED MUSIC SYSTEM. SET WATTAGE TAP ON EACH SPEAKER'S ROTARY SWITCH PER TAP SETTINGS NOTED ON PLANS.

ELECTRICAL SHEET INDEX

E001	ELECTRICAL NOTES
E002	DEMO PLAN
E101	POWER PLAN
E102	POWER PLAN - ENLARGED
E103	LIGHTING PLAN
E201	PANEL SCHEDULES & DETAILS
E202	PANEL SCHEDULES

GENERAL ELECTRICAL NOTES

1. THE ELECTRICAL CONTRACTOR SHALL COORDINATE ELECTRICAL WORK WITH OTHER TRADES. THE ARCHITECTURAL DRAWINGS SHALL TAKE PRECEDENCE OVER ALL OTHER DRAWINGS. DO NOT SCALE DISTANCES OFF THE ELECTRICAL DRAWINGS; USE ACTUAL BUILDING DIMENSIONS. OVERALL CASEWORK COMPONENT DIMENSIONING ON ELECTRICAL DETAILS ARE SHOWN FOR REFERENCE AND COORDINATION ONLY. SEE PROJECT MANUAL.
2. ALL ELECTRICAL SYSTEMS SHALL BE TESTED FOR PROPER OPERATION. BALANCE ALL BRANCH CIRCUIT LOADS BETWEEN THE PHASES OF THE SYSTEM WITHIN 10% OF THE HIGHEST PHASE LOAD IN EACH PANEL BOARD.
3. THE ELECTRICAL CONTRACTOR SHALL BE RESPONSIBLE FOR DE-ENERGIZING CIRCUITS IN DEMOLITION AREAS TO INSURE A SAFE CONDITION. ELECTRICAL DEVICES AND ASSOCIATED WIRING LOCATED WITHIN THE DEMOLITION AREA THAT WILL NO LONGER BE USED SHALL BE REMOVED AND PROPERLY DISPOSED OF AT CONTRACTORS EXPENSE UNLESS OTHERWISE NOTED.
4. THE ELECTRICAL CONTRACTOR SHALL SCHEDULE ALL ELECTRICAL SYSTEM OUTAGES WITH THE GENERAL CONTRACTOR AND LANDLORD AT LEAST 24 HOURS IN ADVANCE. UNLESS APPROVED OTHERWISE ALL OUTAGES SHALL OCCUR BETWEEN 11:00PM AND 5:00AM.
5. ELECTRICAL CONTRACTOR SHALL FURNISH AND INSTALL ALL NECESSARY CONDUIT AND JUNCTIONS TO SUPPORT A COMPLETE SECURITY, PHONE, POS AND DATA SYSTEMS. SEE MANAGER WORKSTATION AND BAR POINT OF SALE (POS) POWER/TELECOM/SECURITY DIAGRAM. COORDINATE ALL DEVICE LOCATIONS AND MOUNTING HEIGHTS WITH SECURITY VENDOR PRIOR TO ROUGH-IN. PROVIDE END-TO-END PULL STRINGS IN ALL CONDUITS. LABEL EACH END OF THE PULL STRING WITH CONDUIT SYSTEM (SECURITY, PHONE, DATA) AND IDENTIFICATION ("SAFE", "FRONT BAR", ETC.). PROVIDE INSULATED BUSHINGS ON ALL STUBBED-UP AND EXPOSED CONDUIT ENDS.
6. ELECTRICAL CONTRACTOR SHALL COORDINATE WITH THE GENERAL CONTRACTOR TO PATCH AND REPAIR ALL EXISTING WALLS, FLOORS, CEILINGS OR OTHER SURFACES IDENTIFIED TO REMAIN THAT MAY BECOME DAMAGED DURING THE COURSE OF WORK.
7. EXPOSED/SURFACE MOUNTED CONDUITS SHALL ONLY BE ALLOWED WHERE NECESSARY IN EXPOSED CEILING AREAS. IF CONDUITS NEED TO BE SURFACE MOUNTED TO WALLS, COORDINATE WITH STARBUCKS CONSTRUCTION MANAGER FOR APPROVAL.
8. VERIFY LOCATION OF ALL OUTLETS AND SWITCHES WITH ARCHITECTURAL DRAWINGS, INTERIOR DETAILS, FINISH SCHEDULES, GENERAL CONTRACTOR, EQUIPMENT VENDORS, STARBUCKS AND EXISTING SITE CONDITIONS. VERIFY FINAL DOOR HINGE LOCATION PRIOR TO SWITCH INSTALLATION AND ADJUST SWITCH LOCATION IF NEEDED. DO NOT MOUNT RECEPTACLES/SWITCHES IN LOCATIONS THAT WOULD CONFLICT WITH MIRRORS, SEAMS OF WALLS, WAINSCOTS, TILE TRANSITIONS, ETC....

GENERAL NOTES

SCOPE
THE INTENT OF THE DRAWINGS AND PROJECT MANUAL IS TO PROVIDE A COMPLETE AND FULLY OPERATIONAL ELECTRICAL SYSTEM. THE ELECTRICAL CONTRACTOR SHALL FURNISH AND INSTALL ALL LABOR, MATERIAL, AND EQUIPMENT NECESSARY TO COMPLETE THE ELECTRICAL WORK.

SITE EXAMINATION
THE ELECTRICAL CONTRACTOR SHALL THOROUGHLY EXAMINE ALL AREAS WHERE EQUIPMENT, CONDUIT, AND WIRING WILL BE INSTALLED AND WILL REPORT ANY CONDITION THAT, IN HIS OPINION, PREVENTS THE PROPER INSTALLATION OF THE ELECTRICAL WORK.

STANDARDS
EQUIPMENT AND MATERIALS SHALL CONFORM WITH APPROPRIATE PROVISIONS OF CSA, ULC, NEC, ASTM, UL, ETL, NEMA, ANSI, AS APPLICABLE TO EACH INDIVIDUAL UNIT OR ASSEMBLY.

CODES
ALL WORK SHALL BE PERFORMED IN STRICT ACCORDANCE WITH ALL APPLICABLE PROVINCIAL AND LOCAL CODES AND ORDINANCES. IN CASE OF CONFLICT BETWEEN THE DRAWINGS AND SPECIFICATIONS AND THE CODES, THE HIGHEST STANDARD SHALL APPLY. ELECTRICAL CONTRACTOR SHALL SATISFY CODE REQUIREMENTS AS A MINIMUM STANDARD WITHOUT ANY EXTRA COST TO STARBUCKS.

PERMITS AND FEES
THE ELECTRICAL CONTRACTOR SHALL PROCURE AND PAY FOR ALL PERMITS, FEES, AND INSPECTIONS NECESSARY TO COMPLETE THE ELECTRICAL WORK.


WARRANTY
THE ELECTRICAL CONTRACTOR SHALL UNCONDITIONALLY WARRANT ALL WORK TO BE FREE OF DEFECTS IN MATERIAL AND WORKMANSHIP FOR A PERIOD OF ONE (1) YEAR FROM THE DATE OF FINAL ACCEPTANCE BY STARBUCKS AND WILL REPAIR OR REPLACE ANY DEFECTIVE WORK PROMPTLY AND WITHOUT CHARGE AND RESTORE ANY OTHER EXISTING WORK DAMAGED IN THE COURSE OF REPAIRING DEFECTIVE MATERIALS AND WORKMANSHIP.



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CERT OF AUTH 5454

PROJECT NAME:
A1A & 10TH

PROJECT ADDRESS:
**975 3RD STREET SOUTH
JACKSONVILLE BEACH, FL 32250**

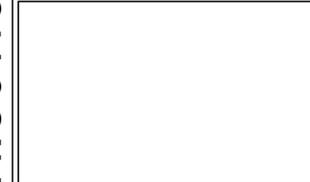STORE #: 8566
PROJECT #: 18756-108
ISSUE DATE: 03-27-2024
DESIGN MANAGER: ROMINA VIGNOLO
PRODUCTION DESIGNER: GENSLER
CHECKED BY: GENSLER


Revision Schedule			
Rev	Date	By	Description

SHEET TITLE:
ELECTRICAL NOTES

SCALE: AS SHOWN

SHEET NUMBER:
E001

PERMIT SET - FOR CONSTRUCTION USE

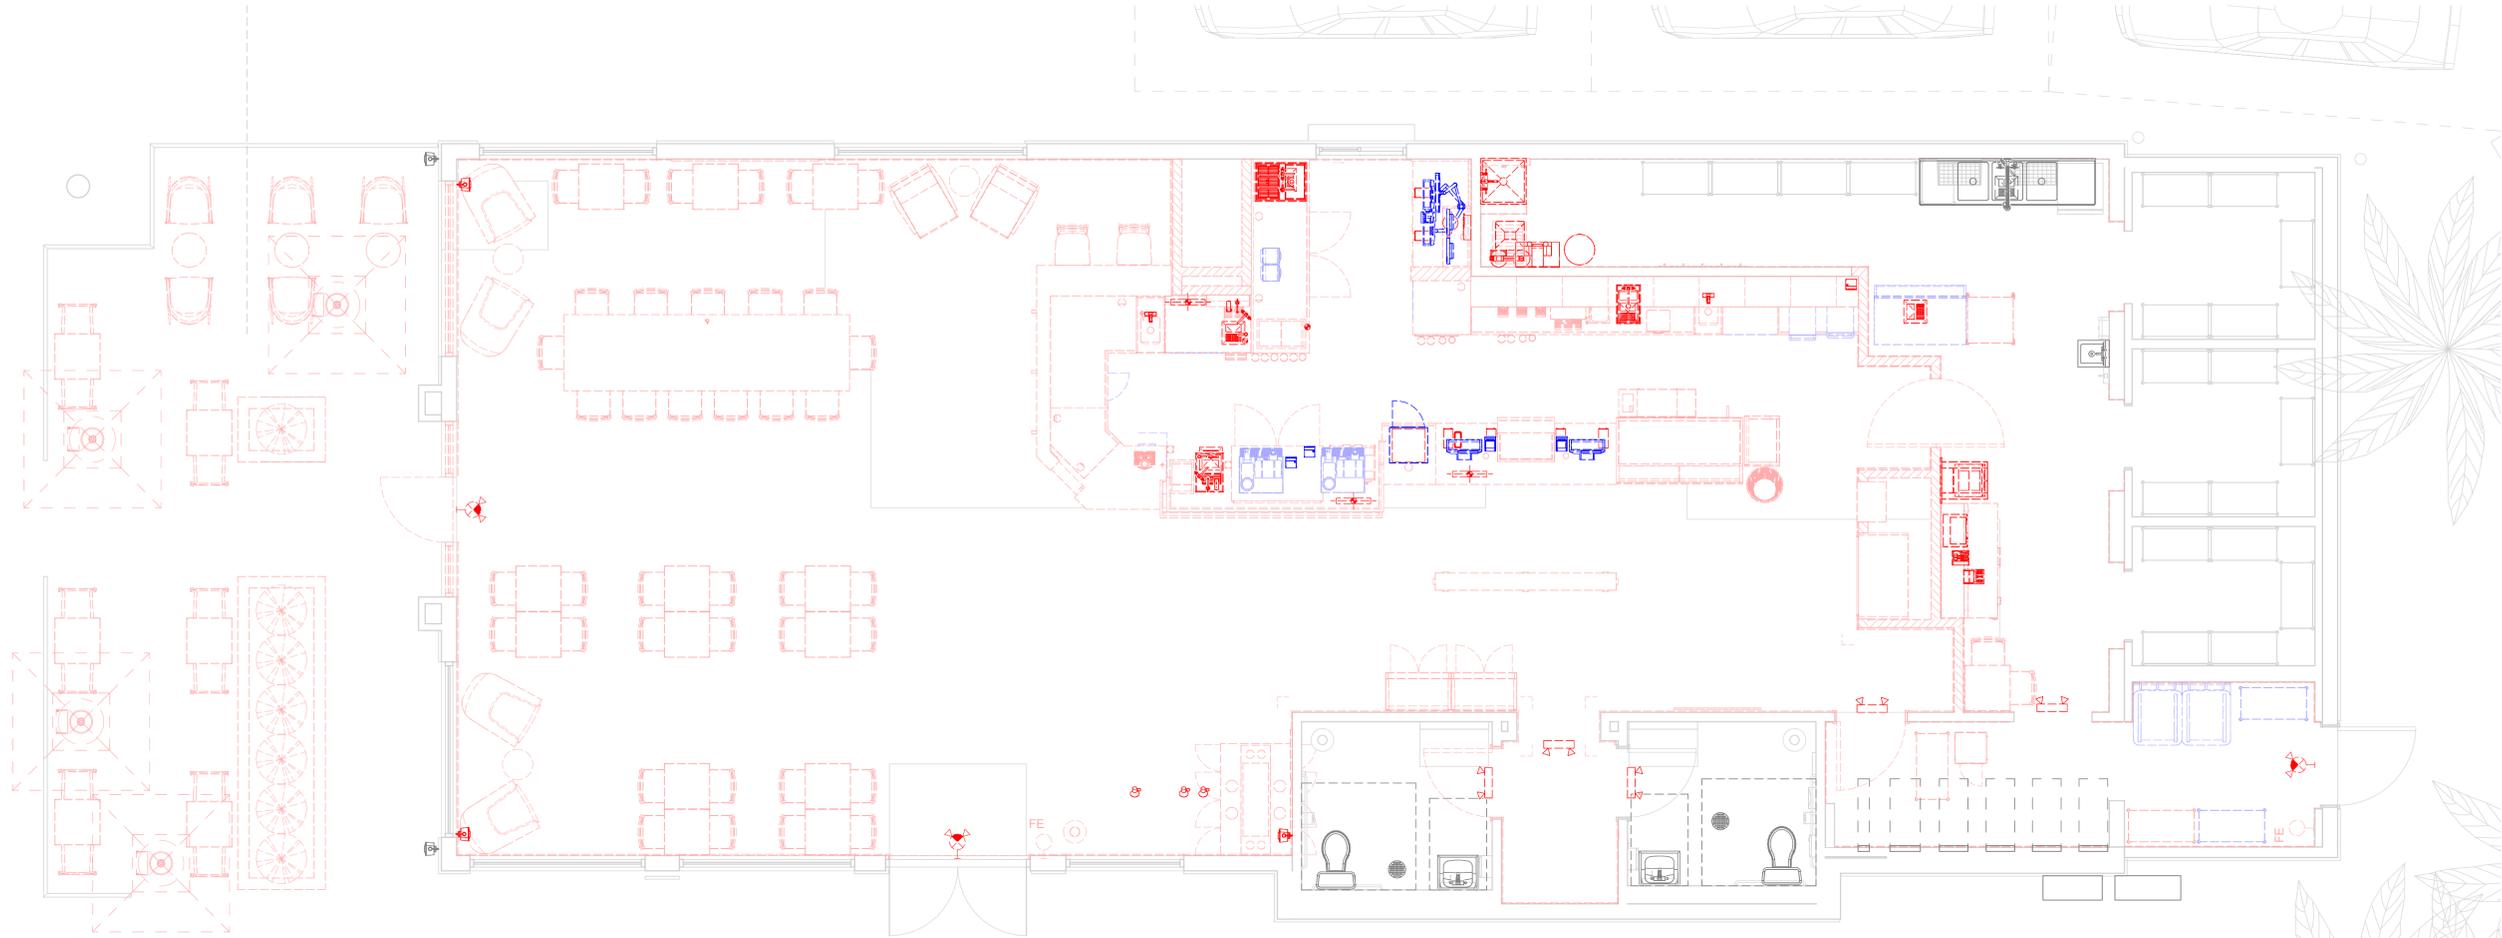

1 DEMO PLAN
1/4" = 1'-0"

DEMOLITION NOTES

1. THE CONTRACTOR SHALL REMOVE ALL UNUSED AND ABANDONED WIRING AND CABLING FROM THE CEILING PLENUM THAT ISN'T LABELED FOR FUTURE USE, AS REQUIRED BY THE NEC. THIS SHALL INCLUDE BUT IS NOT LIMITED TO FIRE ALARM, POWER, SECURITY, CONTROLS, DATA, TELEPHONE, AV, ETC.
2. CIRCUITS MADE SPARE SHALL BE UPDATED ON PANEL SCHEDULES, DIRECTORY CARDS SHALL BE REPLACED WITH NEW TYPED DIRECTORIES, INCLUDING ALL NEW LOADS IN ADDITION TO SPARES. HAND-MARKED NOTES WILL NOT BE ACCEPTED.
3. CARE SHALL BE TAKEN TO RELOCATE ALL EXISTING EQUIPMENT THAT IS BEING MOVED BUT REMAINING AFTER COMPLETION OF WORK. THE CONTRACTOR SHALL BE RESPONSIBLE TO KEEP ALL EXISTING TO REMAIN OR RELOCATED EQUIPMENT AT THE SAME LEVEL OF FUNCTIONALITY FROM THE ACCEPTANCE OF THE CONTRACT TO FINAL COMPLETION. ANY DAMAGE OR LOSS OF FUNCTIONALITY SHALL BE REMEDIED BY THE CONTRACTOR AT NO ADDITIONAL EXPENSE TO THE OWNER.
4. EQUIPMENT INDICATED TO BE REMOVED AND NOT RE-USED SHALL REMAIN THE PROPERTY OF THE OWNER AND RETURNED OR STORED AS DIRECTED.
5. CONDUITS AND RACEWAY SYSTEMS MAY BE ABANDONED WHERE CONCEALED HOWEVER SHALL BE REMOVED WHERE EXPOSED. REMOVED OUTLETS SHALL BE PROVIDED WITH BLANK COVERS, COLOR PER THE ARCHITECTS DIRECTION.
6. EXISTING RACEWAYS AND WIRING ARE ALLOWED TO BE RE-USED PROVIDED THEY MEET THE SPECIFICATIONS FOR THE NEW SYSTEM(S).
7. ALL OUTAGES SHALL BE COORDINATED WITH THE OWNER, THE CONTRACTOR SHALL PLAN AHEAD TO MINIMIZE ALL OUTAGES.
8. CIRCUITS SHALL STAY FUNCTIONAL WHERE DEVICES/FIXTURES ARE BEING DEMOLISHED THAT SHARE A COMMON CIRCUIT WITH DEVICES/FIXTURES THAT ARE TO REMAIN. WIRING SHALL BE REMOVED AS FAR AS POSSIBLE WHILE MAINTAINING EXISTING TO REMAIN OPERATION.
9. THE CONTRACTORS SHALL REMOVE ALL EXISTING ELECTRICAL EQUIPMENT NOT REUSED OR NOT NECESSARY FOR THE COMPLETION OF THIS PROJECT.



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PROJECT NAME:
A1A & 10TH

PROJECT ADDRESS:
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JACKSONVILLE BEACH, FL 32250**

STORE #: 8565
PROJECT #: 18756-108
ISSUE DATE: 03-27-2024
DESIGN MANAGER: ROMINA VIGNOLO
PRODUCTION DESIGNER: GENSLER
CHECKED BY: GENSLER

Revision Schedule			
Rev	Date	By	Description

SHEET TITLE:
DEMO PLAN

SCALE: AS SHOWN

SHEET NUMBER:
E002



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Revision Schedule			
Rev	Date	By	Description

SHEET TITLE:
POWER PLAN

SCALE: AS SHOWN


SHEET NUMBER:
E101

GENERAL NOTES


- A. REFER TO ELECTRICAL DETAIL SHEETS FOR EXACT LOCATIONS AND MOUNTING HEIGHTS OF ELECTRICAL DEVICES.
- B. THE ELECTRICAL CONTRACTOR IS RESPONSIBLE FOR CONFIRMING ALL VOLTAGE REQUIREMENTS ON ALL EQUIPMENT AND PROVIDING BUCK-BOOST TRANSFORMERS AS MAY BE NEEDED FOR CODE. ALL ARE NOT NECESSARILY INDICATED.
- C. ELECTRICAL CONTRACTOR SHALL COORDINATE WITH PLUMBING AND HEATING, VENTILATING, AND AIR CONDITIONING (HVAC) CONTRACTORS FOR ANY ADDITIONAL EQUIPMENT NEEDING POWER.
- D. ANY EQUIPMENT NOTED AS 'FUTURE' SHALL BE PROVIDED WITH APPROPRIATE RECEPTACLES AND WIRING TO ENABLE FUTURE OPERATION.
- E. GROUND FAULT CIRCUIT INTERRUPTER (GFCI) BREAKERS (NOT RECEPTACLES) SHALL BE UTILIZED WHERE REQUIRED BY CODE AND AT ANY FLOOR BOXES. PROVIDE DEDICATED NEUTRAL WIRE FOR ALL THESE CIRCUITS.
- F. EQUIPMENT REQUIRES CONNECTION TO THE BUILDING ELECTRICAL SYSTEM. FURNISH AND INSTALL ALL NECESSARY CONDUIT, WIRE, CONNECTIONS, RECEPTACLES AND OVERCURRENT PROTECTION NECESSARY TO ENSURE THE EQUIPMENT FUNCTIONS PROPERLY AND COMPLIES WITH ALL APPLICABLE LOCAL AND NATIONAL CODES. COORDINATE EQUIPMENT REQUIREMENTS WITH MANUFACTURER CUT SHEET PRIOR TO ROUGH-IN.
- G. ALL FRONT BAR J-BOXES AND OUTLETS SHALL BE SURFACE MOUNTED. PROVIDE CONDUITS AS NEEDED AND ONE (1) ADDITIONAL SPARE CONDUIT BETWEEN ALL J-BOXES FOR FUTURE ELECTRICAL REQUIREMENTS. ALL J-BOXES SHALL BE POSITIONED TO AVOID OBSTRUCTION OF ANY EQUIPMENT SUCH AS REFRIGERATORS AND DISHWASHERS.
- H. REFERENCE LANDLORD WORK LETTER FOR DIVISION OF ELECTRICAL SCOPE OF WORK AND COORDINATE WITH STARBUCKS CONSTRUCTION MANAGER.

KEYNOTE LEGEND

E11	COORDINATE BENCH POWER CONNECTION WITH ARCHITECT.
E12	EXISTING HAND DRYER CIRCUIT TO REMAIN.
E93	RECEPTACLE FOR SEASONAL LIGHTING (SHOW WINDOW RECEPTACLES) IN WALL @ MAXIMUM HEIGHT AFF AND CENTERED ABOVE WINDOW AND PER CODE.
E95	EXISTING PANEL TO REMAIN.

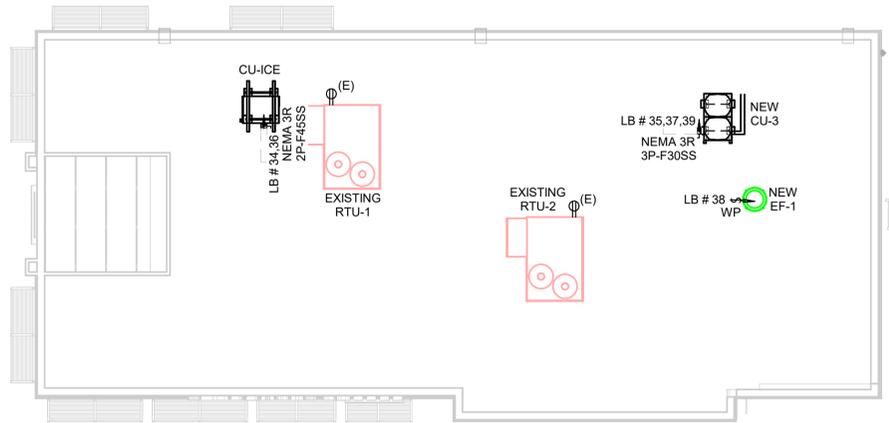


2 POWER PLAN - ROOF
1/8" = 1'-0"

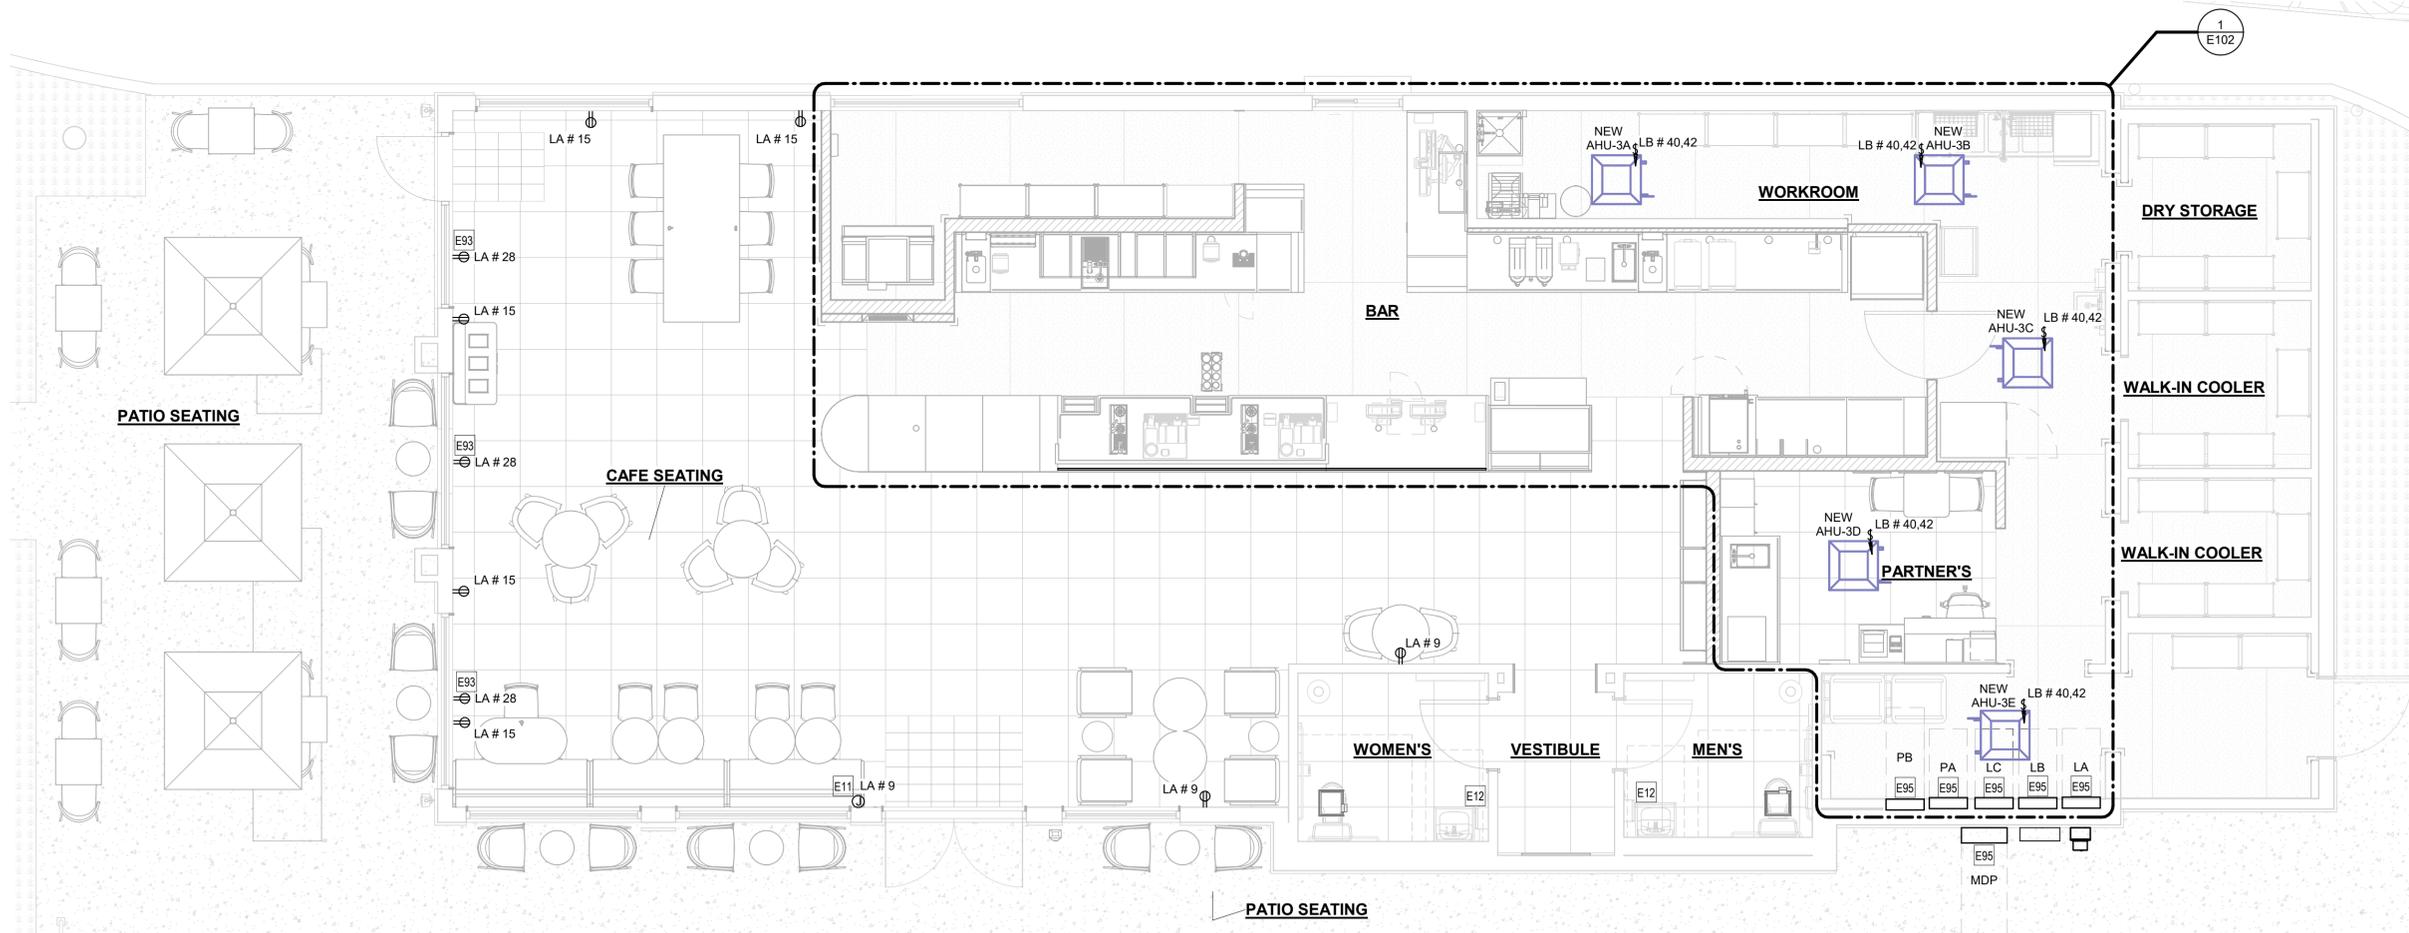

1 POWER PLAN
1/4" = 1'-0"

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1 ENLARGED
1/2" = 1'-0"

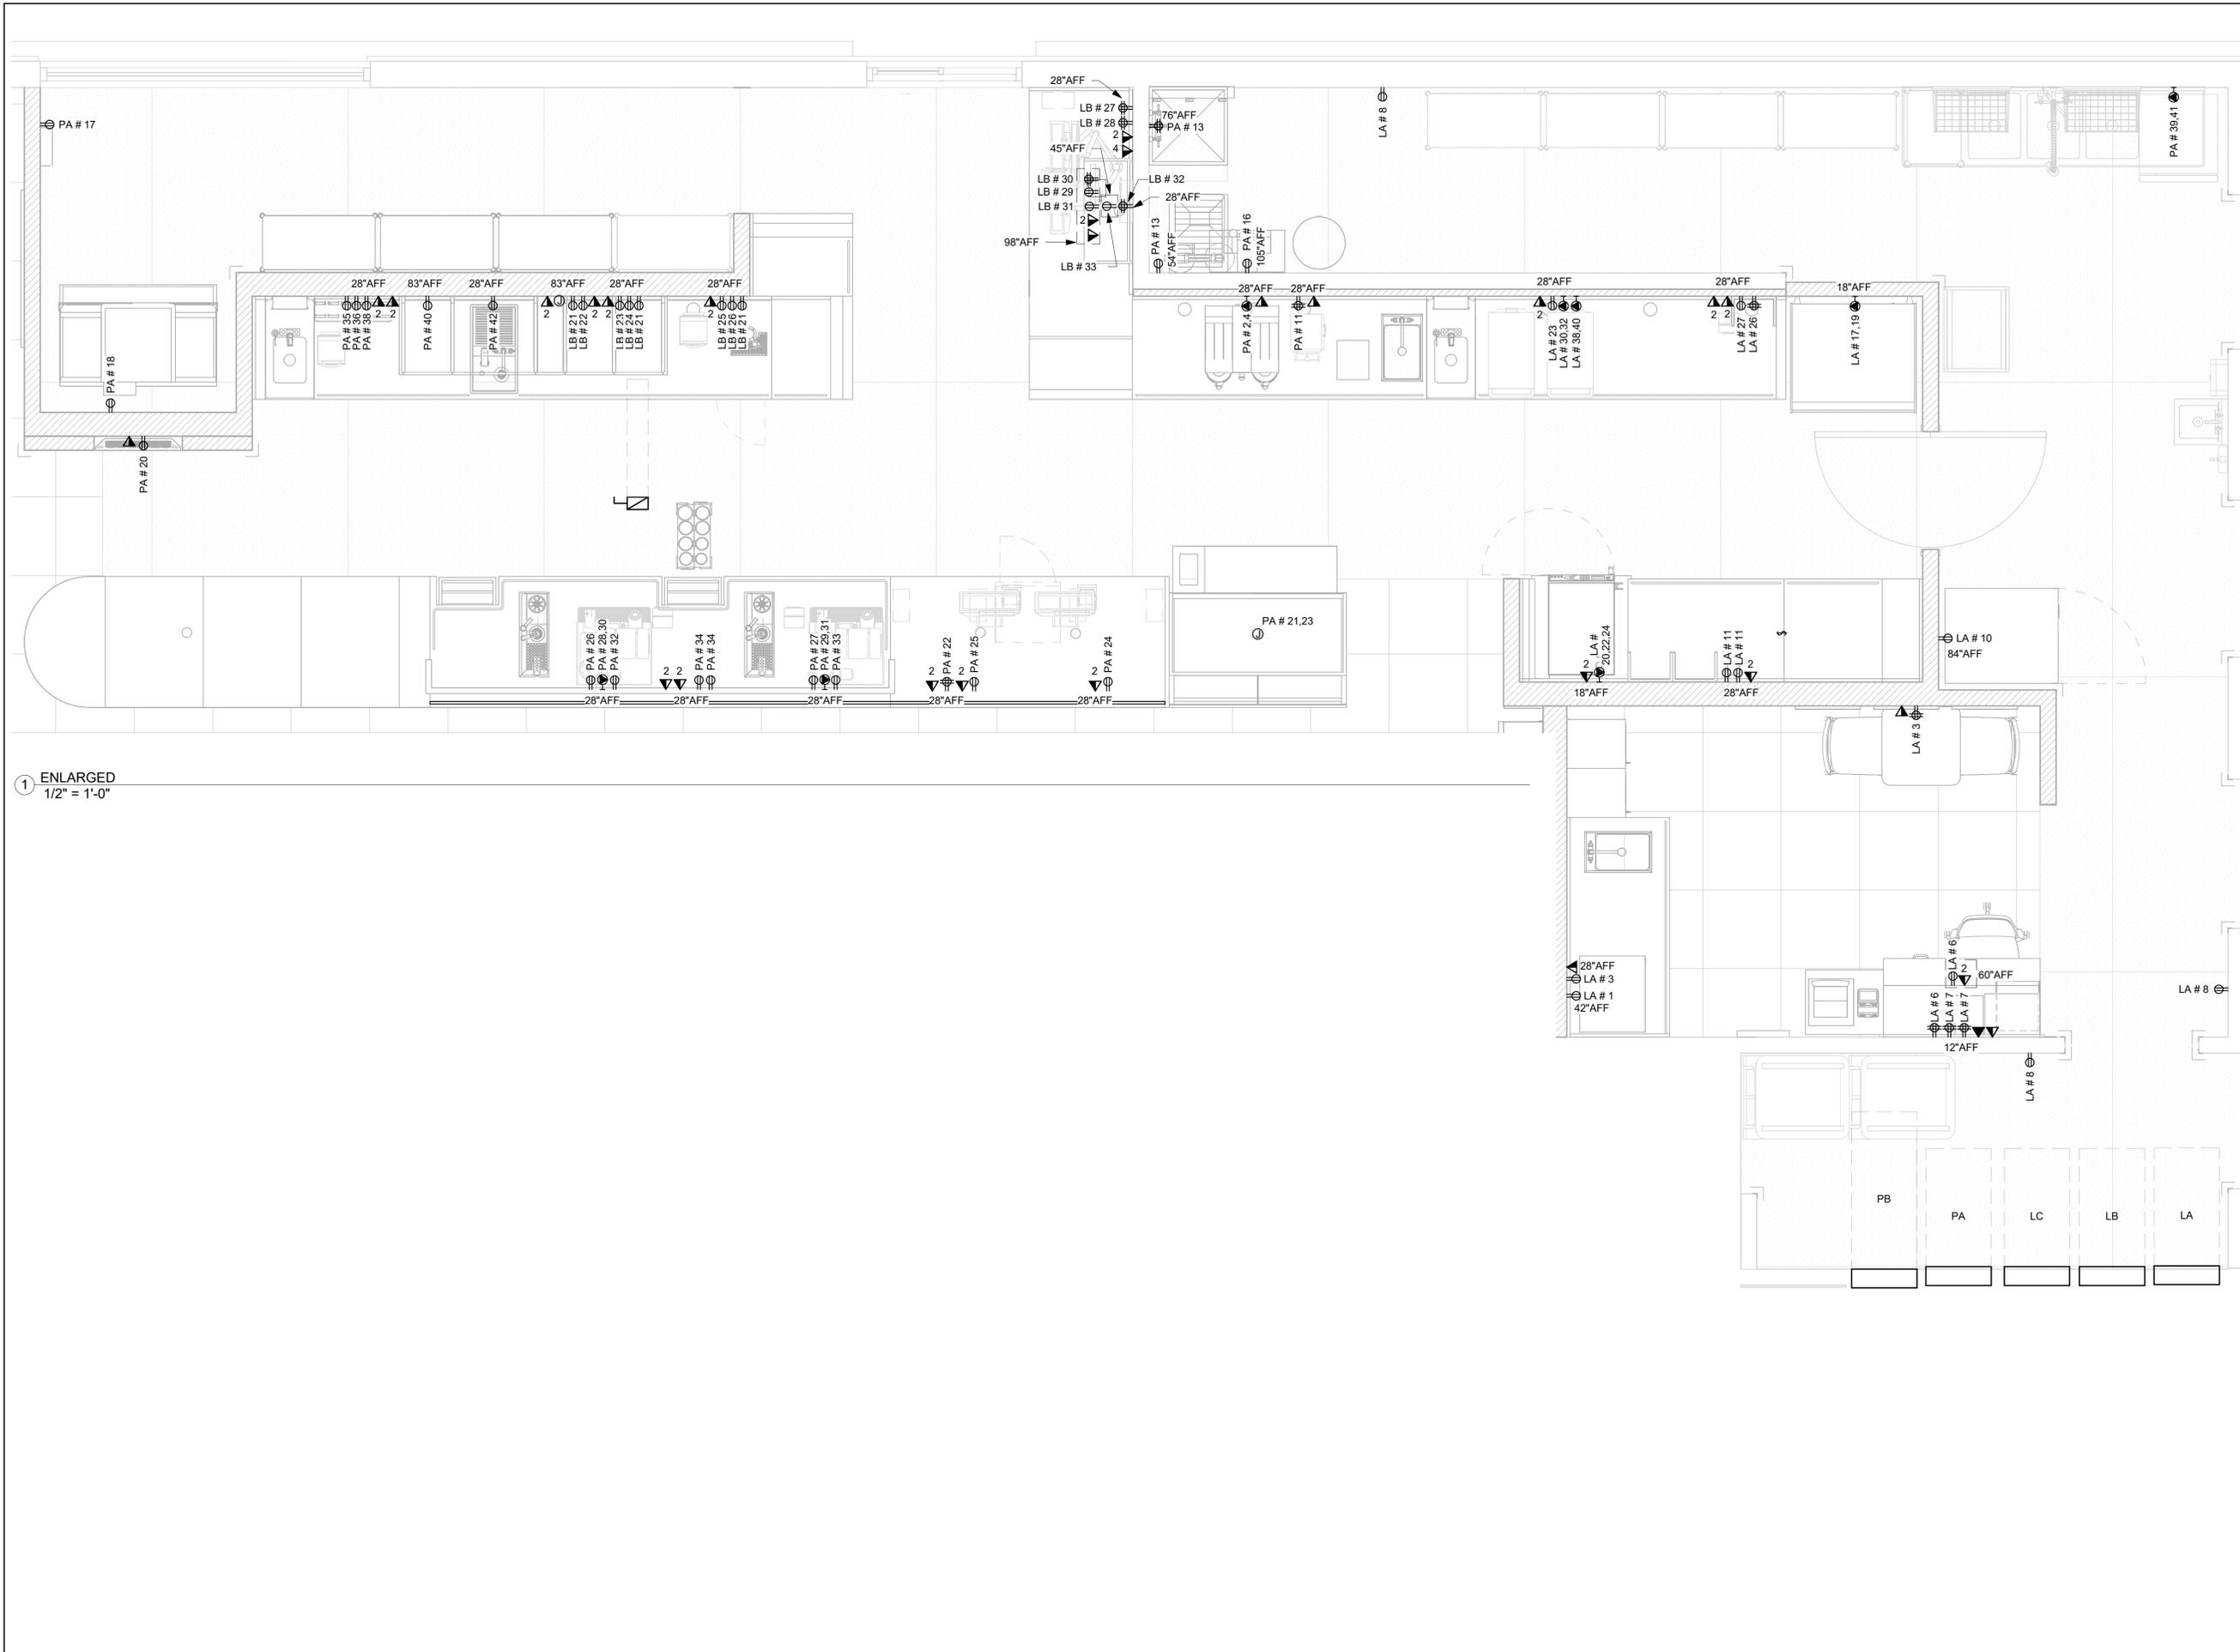

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Revision Schedule			
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SHEET TITLE:
**POWER PLAN -
ENLARGED**

SCALE: AS SHOWN

SHEET NUMBER:
E102

LIGHTING FIXTURE SCHEDULE - "L"						
DESIGN ID	COUNT	DESCRIPTION	FURN. BY	INST. BY	BULB	COMMENTS
EXIT						
19047	2	LED EXIT SIGN WITH EMERGENCY LIGHT - BLACK AND GREEN			INTEGRATED LED	
PENDANT						
20714	1	PENDANT - HOLLIS AND MORRIS LINK - 3FT 91CM - WHITE OAK			INTEGRATED LED	
RECESSED CAN						
22248	51	CAN - LED DOWNLIGHT - 3IN 75MM - BLACK - 700LM WF			INTEGRATED LED	
TRACK						
12944	4	TRACK - WITH CONNECTORS - 16FT 488CM - WHITE - 1 CIRCUIT				
12946	4	TRACK - WITH CONNECTORS - 4FT 122CM - BLACK				
21779	26	TRACK - LED FIXTURE WITH SNOOT - 3IN 75MM - BLACK - 1100LM FLOOD			INTEGRATED LED	

KEYNOTE LEGEND	
E01	PROVIDE UNSWITCHED HOT CONDUCTOR TO NEW EMERGENCY LIGHT/ EXIT SIGN, TIE INTO EXISTING LIGHT BRANCH CIRCUIT USING 2#12, 1#12 G IN 1/2" CONDUIT.
E03	CIRCUIT NEW RESTROOM LIGHTING TO EXISTING RESTROOM LIGHTING CIRCUIT USING 2#12, 1#12 G IN 1/2" CONDUIT, USE EXISTING MOTION SWITCH AS SHOWN.
E07	CONNECT NEW PARTNERS LIGHTS TO EXISTING WORKROOM LIGHTING CIRCUIT USING 2#12, 1#12 G IN 1/2" CONDUIT. PROVIDE NEW CONTROLS AS SHOWN.
E08	CONNECT NEW LIGHTS TO EXISTING LIGHTING CONTROL PANEL. COORDINATE NEW SWITCHBANK LOCATION WITH ARCHITECT.

- ### GENERAL NOTES
- ALL FIXTURES IN WORK ROOM, BACK AND FRONT LINE, ABOVE CONDIMENT CART, AND ANY OTHER AREAS WHERE EXPOSED FOOD, CLEAN EQUIPMENT OR UTENSILS, OR UNWRAPPED SINGLE SERVICE ITEMS WILL BE EXPOSED, SHALL HAVE SHATTERPROOF LAMPS IF THE FIXTURE IS NOT LENSED. ARCHITECT OF RECORD TO INCLUDE APPROPRIATE LAMPS / FIXTURES ON DRAWINGS AND SCHEDULES, AND COMPLY WITH ANY ADDITIONAL JURISDICTIONAL LIGHTING REQUIREMENT.
 - PROVIDE GROMMET AT ALL CEILING PENETRATIONS FOR FIXTURES/SUPPORTS.
 - CENTER EMERGENCY/EXIT LIGHTS ABOVE DOORS, UNLESS OTHERWISE NOTED.
 - ADJUST FOCUS OF ALL TRACK AND RECESSED DIRECTIONAL LIGHTING TO FULLY ILLUMINATE ALL ARTWORK, MENU BOARDS, AND MERCHANDISE BAYS. COORDINATE AIMING WITH OWNER.
 - IF PENDANT CYLINDERS SUSPENDED LENGTH EXCEEDS 48" (1220MM) FROM CEILING, REPLACE WITH SURFACE MOUNTED CYLINDER CANS AND SUSPEND WITH GENERAL CONTRACTOR SUPPLIED CONDUIT AND J-BOX TO INDICATED HEIGHT.




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- ### EGRESS LIGHTING NOTES
- EXIT SIGNS SHALL BE INTERNALLY ILLUMINATED, LISTED AND LABELED IN ACCORDANCE WITH UL 924 AND INSTALLED IN ACCORDANCE WITH THE MANUFACTURER'S INSTRUCTIONS.
 - ANYTIME A BUILDING OR A PORTION OF A BUILDING IS OCCUPIED, THE MEANS OF EGRESS SERVING THE OCCUPIED PORTION SHALL BE ILLUMINATED AT AN INTENSITY OF NOT LESS THAN 1 FOOT CANDLE (11 LUX) AT THE WALKING SURFACE LEVEL. (1008)
 - THE POWER SUPPLY FOR MEANS OF EGRESS ILLUMINATION SHALL BE PROVIDED BY THE PREMISE'S ELECTRICAL SUPPLY, IN THE EVENT OF POWER SUPPLY FAILURE, ILLUMINATION SHALL BE AUTOMATICALLY PROVIDED FROM AN EMERGENCY SYSTEM FOR THE FOLLOWING AREAS. (1008.3):
 - AISLES AND UNENCLOSED EGRESS STAIRWAYS IN ROOMS AND SPACES THAT REQUIRE TWO OR MORE MEANS OF EGRESS.
 - CORRIDORS, INTERIOR EXIT STAIRWAYS & RAMPS AND EXIT PASSAGEWAYS IN BUILDINGS REQUIRED TO HAVE TWO OR MORE EXITS.
 - EXTERIOR EGRESS COMPONENTS AT OTHER THAN THE LEVEL OF EXIT DISCHARGE UNTIL EXIT DISCHARGE IS ACCOMPLISHED FOR BUILDINGS REQUIRED TO HAVE TWO OR MORE EXITS.
 - INTERIOR EXIT DISCHARGE ELEMENTS, AS PERMITTED IN SECTION 1027.1 IN BUILDINGS REQUIRED TO HAVE TWO OR MORE EXITS.
 - EXTERIOR LANDINGS, AS REQUIRED BY SECTION 1008.1.6 EXIT DISCHARGE DOORWAYS IN BUILDING REQUIRED TO HAVE TWO OR MORE EXITS.
 - THE EMERGENCY POWER SYSTEM SHALL ALSO BE CONNECTED TO AN EMERGENCY ELECTRICAL SYSTEM WHICH IS TO PROVIDE CONTINUED ILLUMINATION FOR A DURATION OF NOT LESS THAN 1 1/2 HOUR IN CASE OF PRIMARY POWER LOSS. CONTINUED ILLUMINATION IS TO BE PROVIDED FROM STORAGE BATTERIES, UNIT EQUIPMENT OR AN ON-SITE GENERATOR AND THE INSTALLATION OF THE EMERGENCY POWER SYSTEM SHALL BE INSTALLED IN ACCORDANCE WITH THE MANUFACTURER'S INSTRUCTIONS.
 - EMERGENCY LIGHTING FACILITIES SHALL BE ARRANGED TO PROVIDE INITIAL ILLUMINATION THAT IS AT LEAST AN AVERAGE OF 1 FOOT CANDLE (11 LUX) AND A MINIMUM AT ANY POINT OF 0.1 FOOT CANDLE (1 LUX) MEASURED ALONG THE PATH OF EGRESS AT FLOOR LEVEL. A MAXIMUM TO MINIMUM ILLUMINATION UNIFORMITY RATION OF 40:1 SHALL NOT BE EXCEEDED. (1008.1.9.3)



1 LIGHTING PLAN
1/4" = 1'-0"

PERMIT SET - FOR CONSTRUCTION USE

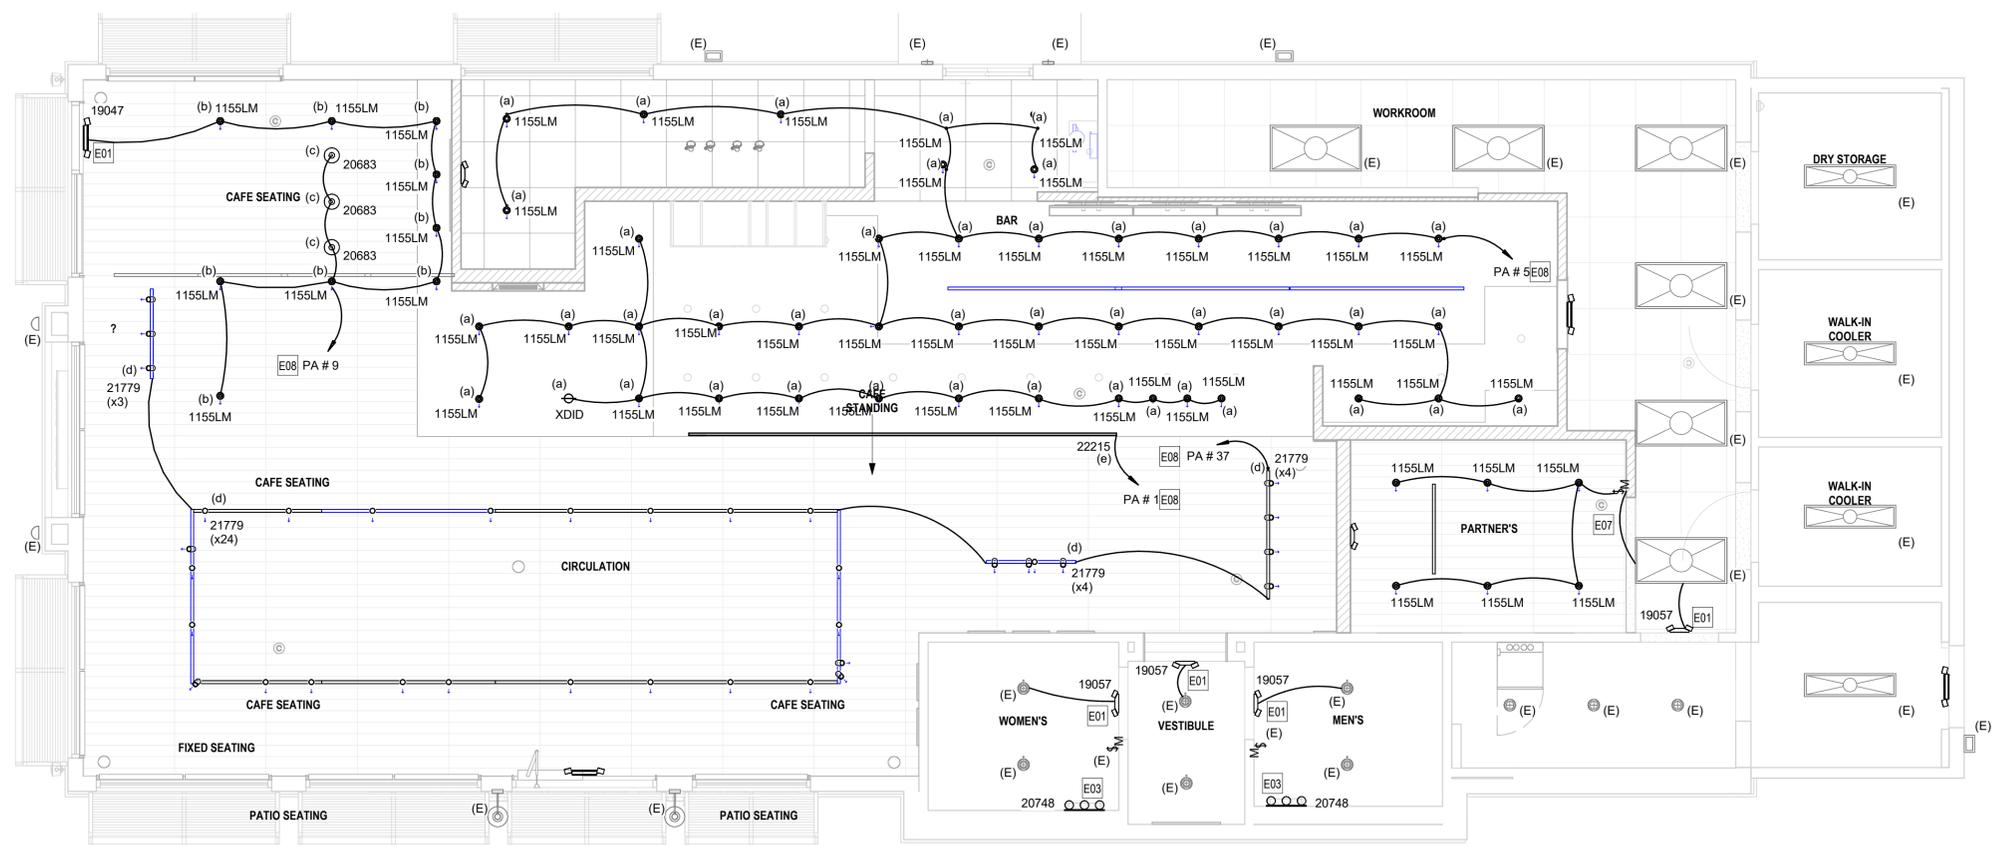

PROJECT NAME:
A1A & 10TH

PROJECT ADDRESS:
**975 3RD STREET SOUTH
JACKSONVILLE BEACH, FL 32250**

STORE #: 8565
PROJECT #: 18756-108
ISSUE DATE: 03-27-2024
DESIGN MANAGER: ROMINA VIGNOLO
PRODUCTION DESIGNER: GENSLER
CHECKED BY: GENSLER

Revision Schedule			
Rev	Date	By	Description

SHEET TITLE:
LIGHTING PLAN

SCALE: AS SHOWN

SHEET NUMBER:
E103

BRANCH PANEL: PA

Location: WORKROOM 93
 Fed From:
 Mounting: Surface

Volts: 120/208 V
 Phases: 3
 Wires: 4

A.I.C. Rating: EXISTING
 Bus: 225 A
 M.L.O. / M.C.B.: MLO
 Feed Thru Lugs:

CKT	Circuit Description	WIRE	COND	BKR	P	A	B	C	P	BKR	COND	WIRE	Circuit Description	CKT	
1	CAFE BAR LTG.			20 A	1	0.11	4.10			2	50 A	3/4"	2#6	DUAL BREWER	2
3	EXISTING EM LTG.	--	--	20 A	1		0.00	4.10			--	--	--		4
5	BEV PREP BAR LTG.			20 A	1			0.40	0.00	1	20 A	--	--	EXISTING LTG. CONTACTOR	6
7	EXISTING R.R./WORK RM LTG.	--	--	20 A	1	0.00	0.00			1	20 A	--	--	EXISTING BUILDING SIGNAGE	8
9	CAFE SEATING LTG.			20 A	1		0.40	0.00		1	20 A	--	--	EXISTING BUILDING SIGNAGE	10
11	GRINDER QUAD	2#12	1/2"	20 A	1			1.00	0.00	1	20 A	--	--	EXISTING BUILDING SIGNAGE	12
13	WATER FILTRATION/ WH CONTROLS	2#12	1/2"	20 A	1	0.72	0.00			1	20 A	--	--	EXISTING BUILDING SIGNAGE	14
15	EXISTING DIRECTIONAL SIGNS	--	--	20 A	1		0.00	0.18		1	20 A	1/2"	2#12	BOOSTER PUMP	16
17	ICE DIVERTER CONTROL PANEL	2#12	1/2"	20 A	1			0.18	0.18	1	20 A	1/2"	2#12	FOLLET EVAP FOR ICE	18
19	EXISTING LTG.	--	--	20 A	1	0.00	0.18			1	20 A	1/2"	2#12	MENU ORDER STATUS BOARD	20
21	ZEPHYR FOOD CASE	2#12	1/2"	20 A	2		0.25	0.36		1	20 A	1/2"	2#12	POS QUAD/ CONV.	22
23	--	--	--	--	--			0.25	0.18	1	20 A	1/2"	2#12	POS SAFE	24
25	POS	2#12	1/2"	20 A	1	0.18	1.30			1	20 A	1/2"	2#12	INSTA HOT	26
27	INSTA HOT	2#12	1/2"	20 A	1		1.30	3.30		2	40 A	3/4"	2#8	ESPRESSO MACHINE	28
29	ESPRESSO MACHINE	2#8	3/4"	40 A	2			3.30	3.30	--	--	--	--		30
31	--	--	--	--	--	3.30	0.36			1	20 A	1/2"	2#12	UC FRIG	32
33	UC FRIG	2#12	1/2"	20 A	1		0.36	0.36		1	20 A	1/2"	2#12	PRINTERS/ FUTURE DEVICES	34
35	REACH IN FRIG	2#12	1/2"	20 A	1			0.36	1.80	1	20 A	1/2"	2#12	BLENDER	36
37	SEATING/CIRCULATION LTG.			20 A	1	0.20	0.18			1	20 A	1/2"	2#12	PRINTER FUTURE USE REC.	38
39	DISHWASHER/ SANITIZER	2#8	3/4"	40 A	2		3.15	1.20		1	20 A	1/2"	2#12	DAIRY DISP.	40
41	--	--	--	--	--			3.15	1.30	1	20 A	1/2"	2#12	RINSE SINK	42
Total Load:						10.63 KVA	14.96 KVA	15.40 KVA							
Total Amps:						89 A	130 A	134 A							

Load Classification	Connected Load (kVA)	Demand Factor	Estimated Demand (kVA)	Panel Totals
Kitchen	37.40	65.00%	24.31	Heat or Cool Dominant: Cooling
Lighting	1.11	100.00%	1.11	Total Connected Load (kVA): 40.99
Other	0.50	100.00%	0.50	Total Estimated Demand (kVA): 27.90
Receptacle	1.98	100.00%	1.98	Total Connected Current: 114 A
				Total Estimated Demand Current: 77 A

Note:



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PROJECT NAME:
A1A & 10TH

PROJECT ADDRESS:
**975 3RD STREET SOUTH
 JACKSONVILLE BEACH, FL 32250**

STORE #: 8565
 PROJECT #: 18756-108
 ISSUE DATE: 03-27-2024
 DESIGN MANAGER: ROMINA VIGNOLO
 PRODUCTION DESIGNER: GENSLER
 CHECKED BY: GENSLER

Revision Schedule			
Rev	Date	By	Description

SHEET TITLE:
**PANEL SCHEDULES &
 DETAILS**
 SCALE: AS SHOWN

SHEET NUMBER:
E201

BRANCH PANEL: LA

Location: WORKROOM 93
Fed From:
Mounting: Surface

Volts: 120/208 V
Phases: 3
Wires: 4

A.I.C. Rating: EXISTING
Bus: 225 A
M.L.O. / M.C.B.: MLO
Feed Thru Lugs:

CKT	Circuit Description	WIRE	COND	BKR	P	A	B	C	P	BKR	COND	WIRE	Circuit Description	CKT	
1	PARTNER'S RM MICROWAVE	2#12		20 A	1	1.20	0.00			1	20 A	--	EXISTING HAND DRYER	2	
3	PARTNER'S UC FRIG/CONV. REC.	2#12		20 A	1		0.54	0.00		1	20 A	--	EXISTING HAND DRYER	4	
5	EXISTING SECURITY SYST.	--	--	20 A	1			0.00	0.54	1	20 A	--	MANGR'S DESK MUSIC/GEN USE QUAD	6	
7	MANGR'S SCALE/PRINTER/HPC	2#12		20 A	1	0.72	0.54			1	20 A	2#12	WORK RM RECS.	8	
9	RETAIL RECS.	2#12		20 A	1		0.86	0.60		1	20 A	2#12	WORK RM REACH IN FRIG.	10	
11	REACH IN FRIG/ G.P. REC.	2#12		20 A	1			0.78	0.00	2	20 A	--	EXISTING PARKING LOT LTG.	12	
13	EXISTING ROOF TOP RECS.	--	--	20 A	1	0.00	0.00			--	--	--		14	
15	RETAIL RECS.	2#12		20 A	1		0.90	0.00		2	30 A	--	EXISTING WATER HEATER	16	
17	WARMING WALL (NEMA 6-30R)	2#10	3/4"	30 A	2			1.50	0.00	--	--	--		18	
19	--	--	--	--	--	1.50	1.50			3	30 A	3/4"	3#10	COMBI OVEN	20
21	EXISTING MONUMENT SIGN	--	--	20 A	1		0.00	1.50		--	--	--		22	
23	UC REACH IN FRIG	2#12		20 A	1			0.36	1.50	--	--	--		24	
25	EXISTING ROOFTOP REC.	--	--	20 A	1	0.00	0.36			1	20 A	2#12	PRINTER/CONV. QUAD	26	
27	REACH IN FRIG	--	--	20 A	1		0.36	0.54		1	20 A	2#12	STORE FRONT WINDOW RECS.	28	
29	EXISTING DRIVE THRU MENU BOARDS	--	--	20 A	1			0.00	3.00	2	40 A	3/4"	2#8	EKON OVEN	30
31	--	--	--	--	--	3.00				--	--	--		32	
33	EXISTING DRIVE THRU SPEAKER	--	--	20 A	1		0.00	0.00		2	20 A	--	EXISTING PARKING LOT LTG.	34	
35	--	--	--	--	--			0.00		--	--	--		36	
37	EXISTING DRIVE THRU MONITORS	--	--	20 A	1	0.00	3.00			2	40 A	3/4"	2#8	EKON OVEN	38
39	EXISTING DRIVE THRU INTERCOM	--	--	20 A	1		0.00	3.00		--	--	--		40	
41	EXISTING DRIVE THRU INTERCOM	--	--	20 A	1			0.00	0.00	1	20 A	--	EXISTING PARKING LOT LTG.	42	
Total Load:						11.82 kVA	8.30 kVA	7.68 kVA							
Total Amps:						99 A	70 A	64 A							

Load Classification	Connected Load (kVA)	Demand Factor	Estimated Demand (kVA)	Panel Totals
Kitchen	16.32	65.00%	10.61	Heat or Cool Dominant: Cooling
Receptacle	11.48	93.55%	10.74	Total Connected Load (kVA): 27.80
				Total Estimated Demand (kVA): 21.35
				Total Connected Current: 77 A
				Total Estimated Demand Current: 59 A

Note:

BRANCH PANEL: LB

Location: WORKROOM 93
Fed From:
Mounting: Surface

Volts: 120/208 V
Phases: 3
Wires: 4

A.I.C. Rating: EXISTING
Bus: 225 A
M.L.O. / M.C.B.: MLO
Feed Thru Lugs:

CKT	Circuit Description	WIRE	COND	BKR	P	A	B	C	P	BKR	COND	WIRE	Circuit Description	CKT	
1	EXISTING	--	--	30 A	2	1.00	0.72			1	20 A	--	EXISTING	2	
3	--	--	--	--	--		1.00	0.72		1	20 A	--	EXISTING	4	
5	EXISTING	--	--	30 A	2			1.00	0.72	1	20 A	--	EXISTING	6	
7	--	--	--	--	--	1.00	0.72			1	20 A	--	EXISTING	8	
9	EXISTING	--	--	20 A	1		1.00	0.72		1	20 A	--	EXISTING	10	
11	EXISTING	--	--	20 A	2			1.00	0.72	1	20 A	--	EXISTING	12	
13	--	--	--	--	--	1.00	0.72			1	20 A	--	EXISTING	14	
15	SPACE	--	--	--	1		--	0.72		1	20 A	--	EXISTING	16	
17	SPACE	--	--	--	1			--	0.72	1	20 A	--	EXISTING	18	
19	EXISTING	--	--	20 A	1	0.00	0.72			1	20 A	--	EXISTING	20	
21	PRINTER/FUTURE USE	2#12	1/2"	20 A	1		0.54	1.20		1	20 A	1/2"	2#12	DAIRY DISP.	22
23	REACH IN FRIG	2#12	1/2"	20 A	1			0.36	1.80	1	20 A	1/2"	2#12	BLENDER	24
25	NITRO FRIG	2#12	1/2"	20 A	1	0.50	0.50			1	20 A	1/2"	2#12	NITROGEN GENERATOR	26
27	DT DIGITAL PRODUCTION MONITOR	2#12	1/2"	20 A	1		0.36	0.36		1	20 A	1/2"	2#12	FUTURE USE QUAD	28
29	WIRELESS BASE SIGNAL PROCESSOR	2#12	1/2"	20 A	1			0.18	0.36	1	20 A	1/2"	2#12	DT TIMER MONITOR	30
31	WIRELESS BASE SIGNAL PROCESSOR	2#12	1/2"	20 A	1	0.18	0.36			1	20 A	1/2"	2#12	UC FRIG/ FUTURE USE QUAD	32
33	CONV. REC.	2#12	1/2"	20 A	1		0.18	3.00		2	45 A	3/4"	2#8	REMOTE ICE COND.	34
35	CU-3	3#10	3/4"	20 A	3			2.53	3.00	--	--	--		36	
37	--	--	--	--	--	2.53	0.68			1	20 A	1/2"	2#12	EF-1	38
39	--	--	--	--	--		2.53	0.25		2	15 A	1/2"	2#12	AHU-3A/B/C/D/E	40
41	SPACE	--	--	--	1			--	0.25	--	--	--		42	
Total Load:						10.63 kVA	12.58 kVA	12.64 kVA							
Total Amps:						89 A	107 A	108 A							

Load Classification	Connected Load (kVA)	Demand Factor	Estimated Demand (kVA)	Panel Totals
Cooling	13.60	100.00%	13.60	Heat or Cool Dominant: Cooling
Kitchen	4.90	65.00%	3.19	Total Connected Load (kVA): 35.86
Lighting	1.18	100.00%	1.18	Total Estimated Demand (kVA): 34.15
Receptacle	1.98	100.00%	1.98	Total Connected Current: 100 A
Spare	14.20	100.00%	14.20	Total Estimated Demand Current: 95 A

Note:



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STARBUCKS TEMPLATE VERSION: i2024.01.01



PROJECT NAME:
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PROJECT ADDRESS:
975 3RD STREET SOUTH
JACKSONVILLE BEACH, FL 32250

STORE #: 8565
PROJECT #: 18756-108
ISSUE DATE: 03-27-2024
DESIGN MANAGER: ROMINA VIGNOLO
PRODUCTION DESIGNER: GENSLER
CHECKED BY: GENSLER

Revision Schedule			
Rev	Date	By	Description

SHEET TITLE:
PANEL SCHEDULES

SCALE: AS SHOWN

SHEET NUMBER:


E202

PERMIT SET - FOR CONSTRUCTION USE

ABBREVIATIONS

AFF	ABOVE FINISHED FLOOR
AHJ	AUTHORITIES HAVING JURISDICTION
APPROX	APPROXIMATE
BD	BACKDRAFT DAMPER
CO2	CARBON DIOXIDE
CFM	CUBIC FEET PER MINUTE
CLG	CEILING
CU	CONDENSING UNIT
CXA	COMMISSIONING AGENT
DEG	DEGREES
DM	STARBUCKS DESIGN MANAGER
DN	DOWN
DTL	DETAIL
DWG(S)	DRAWING(S)
EA	EXHAUST AIR
EC	ELECTRICAL CONTRACTOR
ECP	EQUIPMENT CONTROL PAC
EG	EXHAUST GRILLE
ELEC	ELECTRICAL
EM	EMERGENCY
EMS	ENERGY MANAGEMENT SYSTEM
EX	EXISTING
EF	EXHAUST FAN
F&I	FURNISH & INSTALL
FOIC	FURNISHED BY OWNER, INSTALLED BY CONTRACTOR
FOIO	FURNISHED BY OWNER, INSTALLED BY OWNER
FLR	FLOOR
FT	FOOT/FEET
G	GAS PIPING
GC	GENERAL CONTRACTOR
HR	HOUR
HVAC	HEATING, VENTILATION, AIR CONDITIONING
I.D.	INSIDE DIAMETER
IAQ	INDOOR AIR QUALITY
LCP	LIGHTING CONTROL PANEL
LL	LANDLORD
LV	LOW VOLTAGE
MAX	MAXIMUM
MC	MECHANICAL CONTRACTOR
MECH	MECHANICAL
MEP	MECHANICAL, ELECTRICAL AND PLUMBING
MFG	MANUFACTURER
MIN	MINIMUM
NTS	NOT TO SCALE
O.D.	OUTSIDE DIMENSION
OA	OUTSIDE AIR
REF	REFERENCE
RG	RETURN GRILLE
RA	RETURN AIR
RTU	ROOFTOP UNIT
SF	SQUARE FEET
SD	SUPPLY DIFFUSER
SA	SUPPLY AIR
SST	STAINLESS STEEL
TEMP	TEMPORARY
TYP	TYPICAL
UNO	UNLESS NOTED OTHERWISE
UC	UNDER COUNTER
WH	WATER HEATER
WSHP	WATER SOURCE HEAT PUMP

MECHANICAL SYMBOL LEGEND

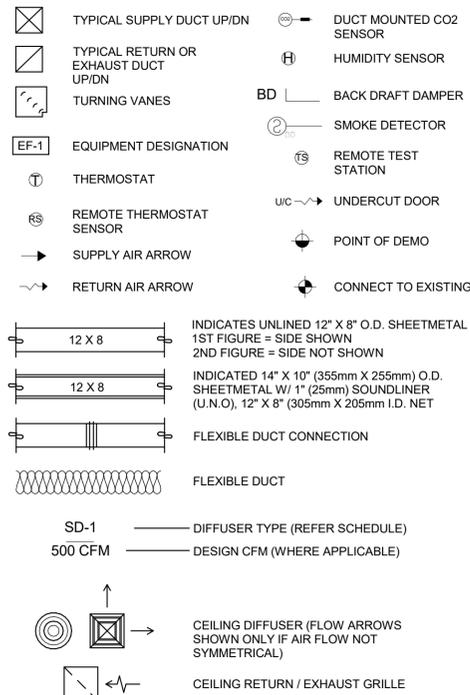

CONTROLS AND OPERATION NOTES

THE GENERAL CONTRACTOR SHALL FURNISH AND INSTALL THE FOLLOWING COMPONENTS:

CONTROL WIRING
THE MECHANICAL CONTRACTOR SHALL PROVIDE ALL CONTROL WIRING IN CONDUIT NECESSARY FOR THE COMPLETE AND PROPER OPERATING TEMPERATURE CONTROL SYSTEM INCLUDING ALL MODES OF OPERATION AND INTERLOCK.

EXHAUST FANS
RESTROOM EXHAUST FAN(S) TO BE OPERATED IN CONJUNCTION WITH STORE HOURS UNLESS OTHERWISE NOTED OR APPROVED OR AS REQUIRED BY JURISDICTION (COORDINATE WITH ELECTRICAL).

THERMOSTAT
PERMANENT THERMOSTAT(S) AND REMOTE SENSOR(S) SHALL BE FURNISHED AND INSTALLED. ONE THERMOSTAT AND SENSOR IS PROVIDED FOR EACH UNIT. MOUNT THERMOSTAT(S) AND SENSOR(S) IN LOCATION & HEIGHT AS INDICATED ON DRAWINGS. MECHANICAL CONTRACTOR TO PROVIDE THERMOSTAT IDENTIFICATION LABELS PER SPECIFICATION REQUIREMENTS. REFER TO THERMOSTAT SETUP INSTRUCTIONS BELOW FOR ADDITIONAL REQUIREMENTS.

- THERMOSTAT SETUP INSTRUCTIONS**
PROVIDE THE FOLLOWING SETUP AND PROGRAMMING:
- CONFIGURE AS FOLLOWS:
 - DEGREES "F" DISPLAY
 - 12 HOUR CLOCK
 - CONTINUOUS FAN OPERATION IN OCCUPIED MODE
 - DISABLE KEYBOARD PROGRAMMING
 - SET TIME AND DATE
 - SET TO DISPLAY CURRENT TEMPERATURE
 - SET OCCUPIED START TIME AT 30 MIN. BEFORE OPENING. SET UNOCCUPIED START TIME AT 30 MIN. AFTER CLOSING. VERIFY HOURS WITH STORE MANAGER OR CONSTRUCTION MANAGER.
 - SET POINTS SHALL BE AS FOLLOWS OR AS APPROPRIATE FOR CLIMATE:
 - OCCUPIED (5° F DEADBAND) (3° C DEADBAND)
 - HEATING: 70° F (21° C)
 - COOLING: 75° F (24° C)
 - UNOCCUPIED
 - HEATING: 60° F (15° C)
 - COOLING: 78° F (25° C)
 - SET TWO (2) HOUR OCCUPIED OVERRIDE FUNCTION TO PROVIDE THE FOLLOWING SET POINT OVERRIDES:
 - HEATING: +2° F (1° C)
 - COOLING: -2° F (1° C)

DEMAND CONTROL VENTILATION (DCV)
THE CO2 SENSOR SHALL MODULATE THE AIR HANDLING UNIT OUTSIDE AIR DAMPER TO MAINTAIN 1000 PPM CO2 OR LESS

- OCCUPIED MODE:**
- FAN SHALL RUN CONTINUOUSLY WHILE BRINGING IN MINIMUM DCV OUTSIDE AIR AS INDICATED IN SCHEDULE.
 - IF CO2 SENSOR SET POINT IS BELOW THE SETPOINT, THE AIR DAMPER SHALL BE OPEN TO THE CALCULATED DCV MINIMUM OUTSIDE AIR.
 - IF CO2 SENSOR SETPOINT IS EXCEEDED, OUTSIDE AIR DAMPER SHALL MODULATE TO MAINTAIN 1000 PPM NOT TO EXCEED THE CALCULATED DESIGN MINIMUM OUTSIDE AIR. UPON CO2 PPM FALLING BELOW THE SETPOINT OF 1000 PPM, THE AIR DAMPER SHALL RETURN TO DCV MINIMUM OUTSIDE AIR.
 - THE ECONOMIZER SHALL HAVE PRIORITY OVER THE DCV CONTROLS. OUTSIDE AIR MAY EXCEED DCV MINIMUM AND DESIGN MINIMUM WHEN AIR CONDITIONS ARE APPROPRIATE TO DO SO.

- UNOCCUPIED MODE:**
- FAN SHALL CYCLE WITH HEATING AND OUTSIDE AIR DAMPER CLOSED. OUTSIDE DAMPER SHALL NOT BE CYCLED WITH CO2 PPM SETPOINT.

SYSTEM COMMISSIONING

CONTRACTOR RESPONSIBILITIES FOR BUILDING COMMISSIONING

CONTRACTOR SHALL PROVIDE SUPPORT AND WORK AS SPECIFIED, NEEDED AND REQUIRED TO CONDUCT AND FACILITATE STARBUCKS STAFF BUILDING COMMISSIONING EFFORTS. THIS WORK WILL BE COMPRISED OF THREE DISTINCT EFFORTS:

- SUPPORT STARBUCKS COMMISSIONING AGENT (CXA) DURING INSTALLATION VERIFICATION AND CORRECT DISCLOSED DEFICIENCIES.
- PERFORM TESTING, ADJUSTING, BALANCING AND SYSTEM STARTUP AND SUPPORT FUNCTIONAL PERFORMANCE TESTING BY STARBUCKS CXA.
- CORRECT DEFICIENCIES DISCLOSED BY FUNCTIONAL PERFORMANCE TESTING AND SUBMIT REPORTS.

CONTRACTOR SHALL PERFORM AND PROVIDE THE FOLLOWING:

- SYSTEMS SUBJECT TO COMMISSIONING MAY INCLUDE, BUT ARE NOT LIMITED TO DOMESTIC HOT WATER GENERATION, HVAC SYSTEMS, ROOFTOP UNITS, EXHAUST FANS, HVAC CONTROLS, LIGHTING CONTROLS AND AIR CURTAINS.
- CONTRACTOR SHALL PROVIDE WRITTEN RESPONSES TO ALL CXA'S REVIEWS AND COMMENTS. RESPONSES SHALL BE PROVIDED IN A TIMELY MANNER.
- CONTRACTOR SHALL INCLUDE COMMISSIONING ACTIVITIES IN PROJECT SCHEDULE AND SHOW INTERVALS FOR PERFORMANCE OF WORK FOR WHICH CONTRACTOR IS RESPONSIBLE AND INTERVALS FOR WORK PERFORMED BY STARBUCKS CXA. CONTRACTOR SHALL SHOW RESOURCES FOR PERFORMING ALL WORK RELATED TO COMMISSIONING ACTIVITIES ON A LINE ITEM IN THE SCHEDULE OF VALUES.
- CONTRACTOR SHALL INSTALL EQUIPMENT IN ACCORDANCE WITH THE MANUFACTURER'S REQUIREMENTS AND ALL CONTRACT DOCUMENTS. ENSURE THAT ALL EQUIPMENT IS INSTALLED TOTALLY COMPLETE AND ACCESSIBLE TO STARBUCKS CXA FOR INSTALLATION VERIFICATION AND FUNCTIONAL PERFORMANCE TESTING PRIOR TO THE SCHEDULED START OF INSTALLATION VERIFICATION.
- CONTRACTOR SHALL COMPLETE MANUFACTURER'S STARTUP PROCEDURES PRIOR TO COMMISSIONING COORDINATION WITH CXA.
- CONTRACTOR SHALL BE READILY AVAILABLE DURING INSTALLATION VERIFICATION TO CORRECT ANY DEFICIENCIES OR DEFECTS IS CLOSED BY THE INSTALLATION VERIFICATION PROCESS. CORRECTIONS SHALL BE MADE IN A TIMELY MANNER WITHOUT DISRUPTION OF THE CONSTRUCTION SCHEDULE.
- ALL HVAC EXHAUST FAN AND AIR CURTAIN EQUIPMENT SHALL BE TESTED, ADJUSTED AND BALANCED BY THE CONTRACTOR'S TESTING, ADJUSTING AND BALANCE AGENT (SEE TESTING ADJUSTING AND BALANCING) AFTER THE SYSTEM IS VERIFIED TO BE COMPLETE AND ACCESSIBLE WITH THE CONTRACTOR IN ACCORDANCE WITH THE REQUIREMENTS OF THESE DOCUMENTS. ALL HVAC CONTROL SYSTEMS SHALL BE TESTED TO ENSURE THAT CONTROL DEVICES, COMPONENTS, EQUIPMENT AND SYSTEMS ARE CALIBRATED, ADJUSTED AND OPERATE IN ACCORDANCE WITH THESE PLANS AND SPECIFICATIONS. SEQUENCES OF OPERATION SHALL BE TESTED TO ENSURE THAT THEY OPERATE IN ACCORDANCE WITH THE CONTRACT REQUIREMENTS. DELIVERABLES: PRELIMINARY WRITTEN TESTING AND AIR BALANCE REPORT CONFORMING TO THE REQUIREMENTS SPECIFIED HEREIN, DOCUMENTING THE INFORMATION SPECIFIED, ETC... TO THE STARBUCKS CXA IMMEDIATELY UPON COMPLETION OF THE WORK.
- PROVIDE A LIST OF ALL FACTORY AND FIELD SETTINGS THAT HAVE BEEN PROGRAMMED INTO THE EQUIPMENT (SUCH AS SETPOINTS, SCHEDULES, DIP SWITCH SETTINGS, CONDENSER AND EVAPORATOR OPERATING PRESSURE/TEMPERATURE, ETC...).
- CONTRACTOR SHALL INFORM STARBUCKS CXA WHEN EQUIPMENT IS READY FOR FUNCTIONAL PERFORMANCE TESTING. ALL EQUIPMENT SHALL BE READY FOR FUNCTIONAL PERFORMANCE TESTING PRIOR TO STARTING TESTING. THIS INCLUDES REHEARSING ALL FUNCTIONAL PERFORMANCE TESTS BEFORE DEMONSTRATING TO THE CXA. CONTRACTOR SHALL OPERATE EQUIPMENT FOR STARBUCKS CXA AND VERIFY BY DEMONSTRATING THE CORRECT OPERATION OF EQUIPMENT, SENSOR CALIBRATION, RESPONSE OF ACTUATORS AND PROPER EXECUTION OF HVAC CONTROL AND LIGHTING SEQUENCES INCLUDING BUT NOT LIMITED TO AIR MOVEMENT, TEMPERATURE, SOUND AND CONTROL RESPONSE. PROVIDE ANY SECURITY ACCESS, HARDWARE, SOFTWARE OR OTHER SUPPORT AS NEEDED FOR THE STARBUCKS CXA TO EFFICIENTLY WITNESS AND DOCUMENT ALL EQUIPMENT TESTING. STARBUCKS CXA WILL RECORD THE EQUIPMENT OPERATION AND RESPONSE TO TESTING SEQUENCES AND PREPARE A LIST OF ANY DEFICIENCIES DISCLOSED BY THE FUNCTIONAL PERFORMANCE TESTS FOR CORRECTION BY THE CONTRACTOR. EQUIPMENT INCLUDES, BUT IS NOT LIMITED TO, AIR HANDLING UNITS, ROOFTOP AND SPLIT TYPE, CONDENSING UNITS, EXHAUST FANS, LIGHTING CONTROLS, ETC... DELIVERABLES: PROVIDE COMPLETED COPIES OF ALL START UP REPORTS, FILLED OUT ON THE MANUFACTURER'S FORMS, TO THE STARBUCKS CXA.
- CONTRACTOR IS RESPONSIBLE FOR CORRECTING ANY ISSUES OR DEFICIENCIES DISCLOSED DURING THE FUNCTIONAL PERFORMANCE TESTING PROCESS. CORRECTIONS SHOULD BE MADE IN A TIMELY MANNER WITHOUT DISRUPTION TO THE SYSTEM AND CONSTRUCTION SCHEDULE.
- CONTRACTOR SHALL BE READILY AVAILABLE FOR ANY RE-TESTING OF EQUIPMENT DEEMED NECESSARY BY STARBUCKS CXA DURING INSTALLATION VERIFICATION AND FUNCTIONAL PERFORMANCE TESTING. CONTRACTOR IS RESPONSIBLE FOR CORRECTING ANY ISSUES OR DEFICIENCIES FOUND IN THE SYSTEM DURING ANY AND ALL RE-TESTING. CORRECTIONS SHOULD BE MADE IN A TIMELY MANNER WITHOUT DISRUPTION TO THE SYSTEM AND CONSTRUCTION SCHEDULE. DELIVERABLES: FINAL BALANCE REPORT, DEFICIENCIES LIST NOTING CORRECTIVE ACTIONS PERFORMED BY CONTRACTOR IN RESPONSE TO INSTALLATION VERIFICATION AND FUNCTIONAL PERFORMANCE TEST RESULTS.
- CONSTRUCTION AND POST CONSTRUCTION TESTING: ADDITIONAL TESTING MAY BE REQUIRED BY LEED AND OTHER PROCESSES THAT MAY OCCUR OUT OF SEQUENCE WITH COMMISSIONING SERVICE. CONTRACTOR SHALL CONDUCT, DOCUMENT, SUPPORT AND SCHEDULE THIS TESTING AS DIRECTED BY STARBUCKS CXA.

SYSTEM COMMISSIONING (continued)

- CONTRACTOR SHALL PROVIDE A TRAINING PLAN FOR EACH TRADE (MECHANICAL, ELECTRICAL, PLUMBING) FOR THE CXA'S APPROVAL. THE TRAINING PLAN SHALL OUTLINE ALL THE TOPICS THAT ARE TO BE COVERED ALONG WITH THE TIME DURATION FOR EACH TOPIC. IT SHALL ALSO INCLUDE THE INSTRUCTOR'S NAME, QUALIFICATIONS AND COMPANY LOGO.
- THE CONTRACTOR IS RESPONSIBLE FOR RECORDING ATTENDANCE FOR EACH TRAINING SESSION. COPIES OF THESE SHALL BE SUBMITTED TO THE CXA.
- CONTRACTOR SHALL SUBMIT O&M MANUALS FOR ALL PIECES OF EQUIPMENT AT LEAST 6 WEEKS IN ADVANCE OF THE TRAINING SESSIONS.

HVAC EQUIPMENT AND MATERIALS

FILTERS
IF OPERATING HVAC DURING CONSTRUCTION, PROVIDE THREE (3) SETS OF 2" (51MM) MERV6 PLEATED DISPOSABLE FILTERS (OR HIGHER RATING IF REQUIRED BY LEED). USE ONE SET UNTIL COMPLETION OF CONSTRUCTION. INSTALL ONE SET AT COMPLETION OF CONSTRUCTION (PRIOR TO TAB) AND DELIVER ONE SET OF MERV13 FILTERS TO STARBUCKS LABELED TO DENOTE THEIR RESPECTIVE AIR HANDLING UNIT.

BRACING AND ANCHORING
ALL MECHANICAL EQUIPMENT, FIXED OR FLEXIBLY MOUNTED, SHALL BE BRACED OR ANCHORED TO COMPLY WITH LOCAL CODES.

DUCTWORK AND ACCESSORIES

SHEET METAL DUCTWORK
ASSEMBLE AND INSTALL DUCTWORK IN ACCORDANCE WITH RECOGNIZED INDUSTRY PRACTICE FOR ACHIEVING AIR TIGHT (5% LEAKAGE) AND NOISELESS (NO OBJECTIONABLE NOISE) SYSTEMS. NO VARIATION OF DUCT CONFIGURATION OR SIZES WILL BE PERMITTED EXCEPT BY PERMISSION FROM THE ENGINEER.

DAMPERS
PROVIDE CONVENIENTLY LOCATED ACCESS DOORS OF AMPLE SIZE AND QUANTITY FOR SERVICING THE DAMPERS. PROVIDE MOTORIZED DAMPERS AT ALL INTAKE & EXHAUST BUILDING OPENINGS. COORDINATE WITH OTHER TRADES FOR ACCESS PANELS, POWER AND FIRE ALARM INTERFACES. SEE PROJECT MANUAL.

ACOUSTICAL DUCT LINER
UNLESS OTHERWISE INDICATED ON THE PLANS, PROVIDE 1" (25MM) ACOUSTICAL DUCT LINER IN SUPPLY AND RETURN DUCTWORK WITHIN 10'-0" (305CM) OF THE DISCHARGE AND INTAKE OF AIR HANDLING UNITS. INCREASE DUCT SIZE INDICATED ON PLANS AS NEEDED TO ACCOMMODATE LINER. LINER TO BE PROVIDED AND FASTENED TO DUCT WITH MECHANICAL LINER FASTENERS IN ACCORDANCE WITH SMACNA AND PROJECT MANUAL.

FLEXIBLE DUCTWORK
FLEXIBLE DUCTWORK SHALL ONLY BE INSTALLED AS SHOWN IN PLAN AND NOT ABOVE HARD LID CEILINGS. FLEXIBLE DUCTWORK SHALL NOT EXCEED 5'-0" (152CM) IN LENGTH AND TWO 45° ELBOWS. IT SHALL BE PULLED TAUT AND APPROPRIATELY FASTENED TO RIGID BRANCH DUCT & DIFFUSER. BENDS SHALL BE MINIMIZED AND WHERE NEEDED BE A FULL RADIUS BEND. SUPPORT BANDS SHALL BE INSTALLED SO AS TO NOT CRIMP FLEX DUCT. FLEXIBLE DUCTWORK SHALL MEET REQUIREMENTS.

TESTING, ADJUSTING, BALANCING

INDEPENDENT AIR BALANCE CONTRACTOR OR QUALIFIED MECHANICAL CONTRACTOR SHALL BE QUALIFIED BY NEBB OR AABC STANDARDS. BALANCER SHALL ACCURATELY BALANCE THE SUPPLY, RETURN AND OUTSIDE AIR, EXHAUST FAN(S), HYDRONIC (WHERE APPLICABLE) AND EXHAUST FAN(S) SYSTEMS TO PROVIDE AIR AND WATER QUANTITIES WITHIN 10% PLUS MINUS OF THE VALUES INDICATED ON THE DRAWINGS AND IN THE SPECIFICATIONS UNLESS MANUFACTURER REQUIRES TIGHTER TOLERANCES. OPERATE AUTOMATIC CONTROLS SYSTEMS AND VERIFY SETPOINTS FOR THERMOSTATS, CO2 SENSORS, DCV, EMS AND ECONOMIZER/OUTSIDE AIR DAMPER. SEE CONTROLS AND OPERATION NOTES AND HVAC SCHEDULES AND NOTES FOR DETAILS. IF DEFICIENCIES OR SITE CONDITIONS PREVENT COMPLETE AND PROPER BALANCING, DO NOT COMPLETE WORK AND SUBMIT A REQUEST FOR INFORMATION TO GET COMPLETE INFORMATION PRIOR TO COMPLETING WORK. SUBMIT THREE (3) COPIES OF THE BALANCE REPORT TO THE ENGINEER, CONSTRUCTION MANAGER AND COMMISSIONING AGENT FOR APPROVAL. THE BALANCE REPORT SHALL INCLUDE NEBB OR AABC CREDENTIALS, EQUIPMENT/INSTRUMENT LIST WITH THE MOST RECENT CALIBRATION DATE AND BALANCE REPORTS FOR ALL HVAC AND EXHAUST SYSTEMS. T&B REPORT SHOULD MATCH NEBB OR AABC STANDARD REPORTS INCLUDING UNIT TEST DATA WITH TEMPERATURES, PRESSURES AND STATIC PRESSURE PROFILES. INCLUDE A COPY OF THE BALANCE REPORT AS APPROVED BY THE ENGINEER WITH APPLICATION FOR FINAL CONTRACT PAYMENT.

IAQ MANAGEMENT PLAN

DURING CONSTRUCTION, CONTRACTOR SHALL COMPLY WITH CHAPTER 3 OF SMACNA'S IAQ GUIDELINES FOR OCCUPIED BUILDINGS UNDER CONSTRUCTION. CONTRACTOR SHALL PERFORM AND SUBMIT ALL INFORMATION AS REQUIRED. IF HVAC SYSTEM IS TO BE USED DURING CONSTRUCTION, INSTALL MERV 8 FILTERS AT EACH RETURN AIR GRILL AND COMPLY WITH SMACNA'S GUIDELINES.

MECHANICAL SHEET INDEX	
M000	MECHANICAL COVER SHEET
M001	MECHANICAL ZONE MAP
M101	MECHANICAL DEMO PLAN
M102	MECHANICAL ROOF DEMO PLAN
M201	MECHANICAL FLOOR PLAN
M202	MECHANICAL ROOF PLAN
M301	MECHANICAL ISOMETRIC
M401	MECHANICAL SCHEDULES
M501	MECHANICAL DETAILS
M502	MECHANICAL DETAILS
M503	MECHANICAL VRF SCHEMATIC
M601	MECHANICAL CALCULATIONS

GENERAL MECHANICAL NOTES

- MECHANICAL CONTRACTOR SHALL COORDINATE WITH THE GENERAL CONTRACTOR TO PATCH AND REPAIR ALL EXISTING WALLS, FLOORS, CEILINGS OR OTHER SURFACES IDENTIFIED TO REMAIN THAT MAY BECOME DAMAGED DURING THE COURSE OF WORK.
- DRAWINGS ARE DIAGMMATIC AND INDICATE GENERAL INTENT OR ARRANGEMENT OF SYSTEM(S). FURNISH & INSTALL ALL COMPONENTS NEEDED WHETHER INDICATED OR NOT TO PROVIDE A COMPLETE AND OPERATING SYSTEM.
- CONTRACTOR TO VERIFY ALL DIMENSIONS, INCLUDING CLEARANCES REQUIRED BY OTHER TRADES, AND NOTIFY STARBUCKS CONSTRUCTION MANAGER OF ANY DISCREPANCIES PRIOR TO PROCEEDING WITH THE WORK. ALL DIMENSIONS ARE TO THE FACE OF THE FINISHED SURFACE UNLESS NOTED OTHERWISE. ALL DIMENSIONS TO BE TAKEN FROM ACTUAL BUILDING DIMENSIONS.
- THE MECHANICAL CONTRACTOR SHALL COORDINATE HVAC WORK WITH OTHER TRADES. THE ARCHITECTURAL DRAWINGS AND PROJECT MANUAL SHALL TAKE PRECEDENCE OVER ALL OTHER DRAWINGS. SEE ARCHITECTURAL DRAWINGS AND PROJECT MANUAL FOR DIMENSIONED DIFFUSER LOCATIONS AND MOUNTING HEIGHTS WHERE EXPOSED.
- NEW DUCTWORK AND EQUIPMENT SHALL NOT BE INSTALLED WHERE IT OBSTRUCTS ANY EXISTING OR NEW AREAS THAT REQUIRE ACCESS.
- INSULATE DUCTWORK PER CODE AND SPEC. REQUIREMENTS. COORDINATE CLEARANCE REQUIREMENTS FOR ADDED INSULATION.
- ALL IS NEW UNLESS NOTED OTHERWISE.

GENERAL NOTES

SCOPE
THE INTENT OF THE PROJECT MANUAL AND THE DRAWINGS IS TO PROVIDE A COMPLETE AND FULLY OPERATIONAL MECHANICAL SYSTEM. THE MECHANICAL CONTRACTOR SHALL FURNISH ALL LABOR, MATERIAL, AND EQUIPMENT NECESSARY TO COMPLETE THE MECHANICAL WORK.

SITE EXAMINATION
THE MECHANICAL CONTRACTOR SHALL THOROUGHLY EXAMINE ALL AREAS WHERE EQUIPMENT, DUCTWORK, AND PIPING WILL BE INSTALLED AND WILL REPORT ANY CONDITION THAT, IN HIS OPINION, PREVENTS THE PROPER INSTALLATION OF THE MECHANICAL WORK.

PENETRATIONS
WHERE PIPES AND DUCTS PENETRATE WALL, SEAL OPENINGS TO PREVENT AIR TRANSFER BETWEEN SPACES. USE FIRE RATED SEALANTS ON ALL FIRE SEPARATION PENETRATIONS, INCLUDING FLOORS. SEAL AROUND ALL PIPES AND DUCTS PENETRATING FIRE SEPARATIONS WITH NON-COMBUSTIBLE PACKING RETAINED BY METAL COLLARS. THE ASSEMBLY SHALL BE APPROVED BY STATE FIRE MARSHALL.

STANDARDS
EQUIPMENT AND MATERIALS SHALL CONFORM WITH THE APPROPRIATE PROVISIONS OF CSA, ULC, ARL, ASME, ASTM, UL, NEMA, ANSI, SMACNA, ASHRAE, NFPA, AS APPLICABLE TO EACH INDIVIDUAL UNIT OR ASSEMBLY.

CODES
ALL WORK SHALL BE PERFORMED IN STRICT ACCORDANCE WITH ALL APPLICABLE PROVINCIAL AND LOCAL CODES AND ORDINANCES. IN CASE OF CONFLICT BETWEEN THE DRAWINGS AND PROJECT MANUAL AND THE CODES AND ORDINANCES, USE WHICHEVER IS MORE STRINGENT. THE MECHANICAL CONTRACTOR SHALL SATISFY CODE REQUIREMENTS AS A MINIMUM STANDARD WITHOUT ANY EXTRA COST TO STARBUCKS.

PERMITS AND FEES
THE MECHANICAL CONTRACTOR SHALL PROCURE AND PAY FOR ALL PERMITS, FEES, AND INSPECTIONS NECESSARY TO COMPLETE THE MECHANICAL WORK.

WARRANTY
THE MECHANICAL CONTRACTOR SHALL UNCONDITIONALLY WARRANT ALL WORK TO BE FREE OF DEFECTS IN MATERIAL AND WORKMANSHIP FOR A PERIOD OF ONE (1) YEAR FROM THE DATE OF FINAL ACCEPTANCE BY STARBUCKS AND WILL REPAIR OR REPLACE ANY DEFECTIVE WORK PROMPTLY AND WITHOUT CHARGE AND RESTORE ANY OTHER EXISTING WORK DAMAGED IN THE COURSE OF REPAIRING DEFECTIVE MATERIALS AND WORKMANSHIP.

LANDLORD REQUIREMENTS

PRIOR TO BID: THE GENERAL CONTRACTOR SHALL COORDINATE WITH LANDLORD / BUILDING OWNER FOR ANY CONSTRUCTION REQUIREMENTS. IF LANDLORD / BUILDING OWNER DOES HAVE REQUIREMENTS, CONTRACTOR SHALL BECOME COMPLETELY FAMILIAR WITH REQUIREMENTS AND ADHERE TO THEM. WHERE LANDLORD / BUILDING OWNER REQUIREMENTS ARE MORE STRINGENT THAN SHOWN IN THESE PLANS (IN THE OPINION OF THE ENGINEER), LANDLORD / BUILDING OWNER REQUIREMENTS SHALL GOVERN.

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STARBUCKS TEMPLATE VERSION: i2024.01.01



PROJECT NAME:
A1A & 10TH

PROJECT ADDRESS:
**975 3RD STREET SOUTH
JACKSONVILLE BEACH, FL 32250**

STORE #:	8565
PROJECT #:	18756-108
ISSUE DATE:	03-27-2024
DESIGN MANAGER:	ROMINA VIGNOLO
PRODUCTION DESIGNER:	GENSLER
CHECKED BY:	GENSLER

Revision Schedule			
Rev	Date	By	Description

SHEET TITLE:
MECHANICAL COVER SHEET

SHEET NUMBER:
M000



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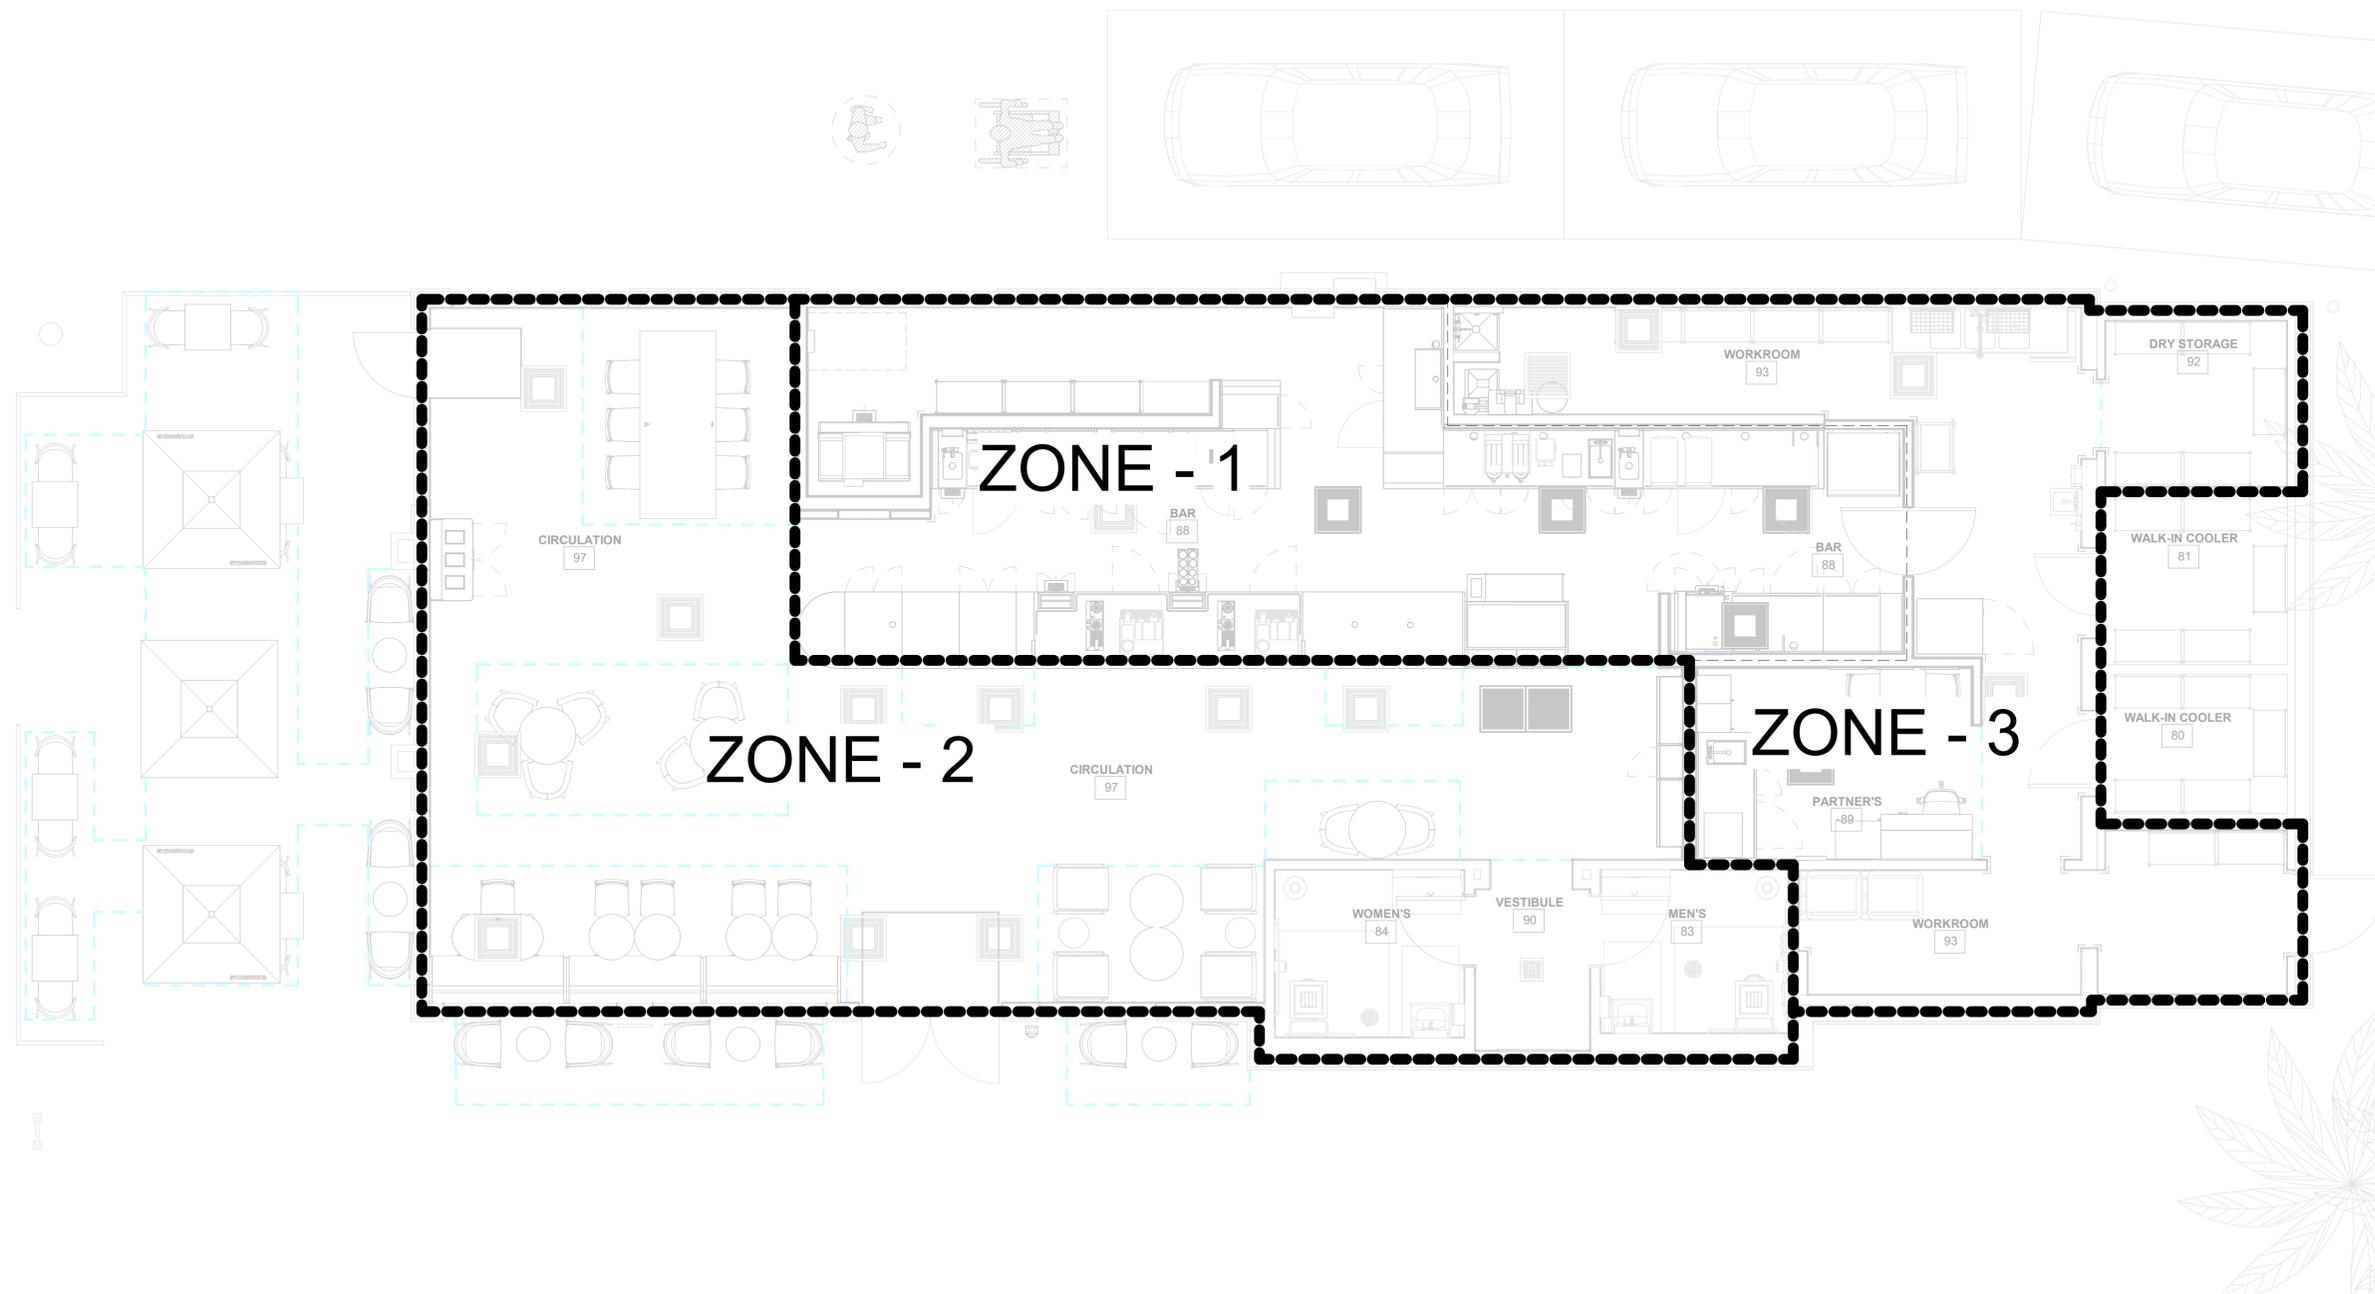
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Revision Schedule			
Rev	Date	By	Description

SHEET TITLE:
MECHANICAL ZONE MAP

SCALE: AS SHOWN

SHEET NUMBER:
M001



1 Mechanical Zone Map
1/4" = 1'-0"



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Revision Schedule			
Rev	Date	By	Description

SHEET TITLE:
**MECHANICAL DEMO
PLAN**

SCALE: AS SHOWN

SHEET NUMBER:
M101


MECHANICAL KEYNOTES	
04	EXISTING RETURN GRILLE AND ASSOCIATED REUTRN DUCT SHALL BE REMOVED BACK TO THE POINT OF DEMO.
06	REMOVE AND PROPERLY DISPOSE OF EXISTING DIFFUSER AND ASSOCIATED FLEX DUCT.
15	TEMPERATURE SENSOR AND T-STAT LOCATIONS SHALL BE RELOCATED. REFERENCE SHEET M201 FOR NEW LOCATIONS.
16	EXISTING DIFFUSER SHALL BE REMOVED AND RE-INTALLED IN NEW LOCATION. REFERENCE SHEET M201 FOR NEW LOCATION.
17	THE EXISTING SUPPLY DUCT SHALL BE REMOVED BACK TO THE POINT OF DEMO.



1 Mechanical Demo Plan
1/4" = 1'-0"



MECHANICAL KEYNOTES	
07	EXISTING ROOFTOP GRAVITY VENTILATOR TO REMAIN.
10	THE EXISTING CONDENSATE DRAINS ARE CURRENTLY ROUTED TO AN EXISTING DOWNSPOUT. THE EXISTING DOWNSPOUT DISCHARGES ONTO THE ASPHALT IN THE DRIVE THRU LANE AND HAS CREATED AN UNSIGHTLY APPEARANCE(REFERENCE PHOTO). CONDENSATE IS NOT PERMITTED TO DISCHARGE ONTO PUBLIC WALKWAYS OR DRIVEWAYS PER THE FBC. THE EXISTING CONDENSATE SHALL BE REMOVED AND DISPOSED OF AT THE POINT OF DEMO. REFERENCE THE MECHANICAL FLOOR PLAN FOR NEW CONDENSATE PIPE ROUTING.

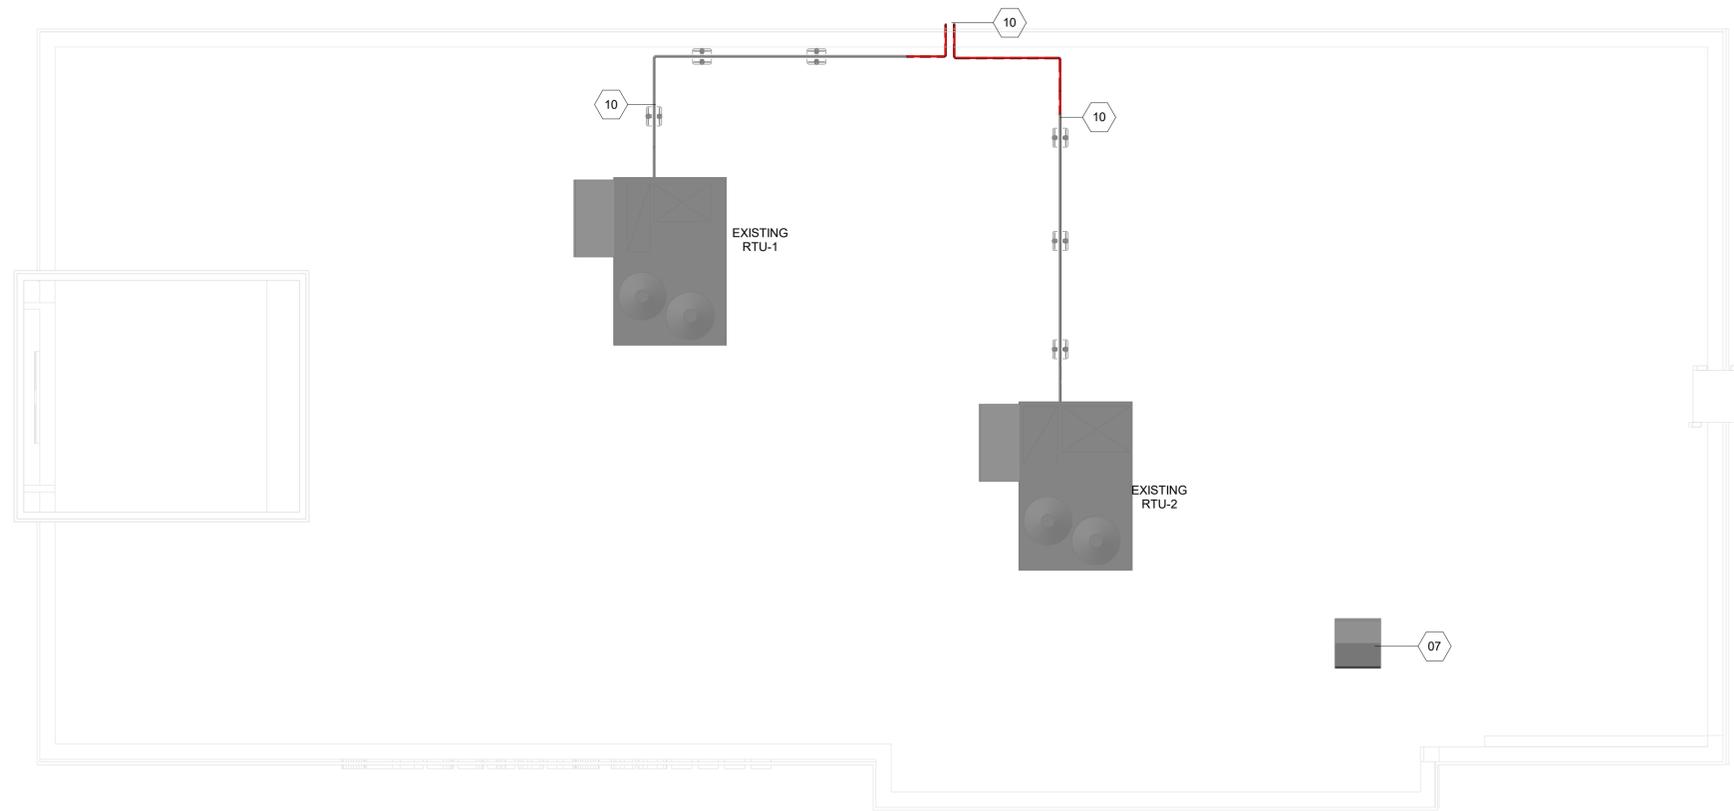

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Revision Schedule			
Rev	Date	By	Description

SHEET TITLE:
**MECHANICAL ROOF
DEMO PLAN**
SCALE: AS SHOWN

SHEET NUMBER:
M102



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CERT OF AUTH 5454

PROJECT ADDRESS:
975 3RD STREET SOUTH
JACKSONVILLE BEACH, FL 32250

PROJECT NAME:
A1A & 10TH

STORE #: 8565
PROJECT #: 18756-108
ISSUE DATE: 03-27-2024
DESIGN MANAGER: ROMINA VIGNOLO
PRODUCTION DESIGNER: GENSLER
CHECKED BY: GENSLER


Revision Schedule

Rev	Date	By	Description

SHEET TITLE:
MECHANICAL FLOOR PLAN
SCALE: AS SHOWN

SHEET NUMBER:
M201

MECHANICAL KEYNOTES	
05	CONFIRM EXISTING DUCT SMOKE DETECTOR IS INSTALLED IN THE SUPPLY DUCT AND IN GOOD WORKING CONDITION. ALSO ENSURE THAT THE REMOTE TEST STATION IS INSTALLED ADJACENT TO THE T-STAT LOCATION.
14	ROUTE CONDENSATE DOWN WALL AND TERMINATE INTO JANITOR'S SINK.
15	TEMPERATURE SENSOR AND T-STAT LOCATIONS SHALL BE RELOCATED. REFERENCE SHEET M201 FOR NEW LOCATIONS.
18	EXISTING SUPPLY DIFFUSER SHALL BE REBALANCE TO NEW AIRFLOW VALUE SHOWN.

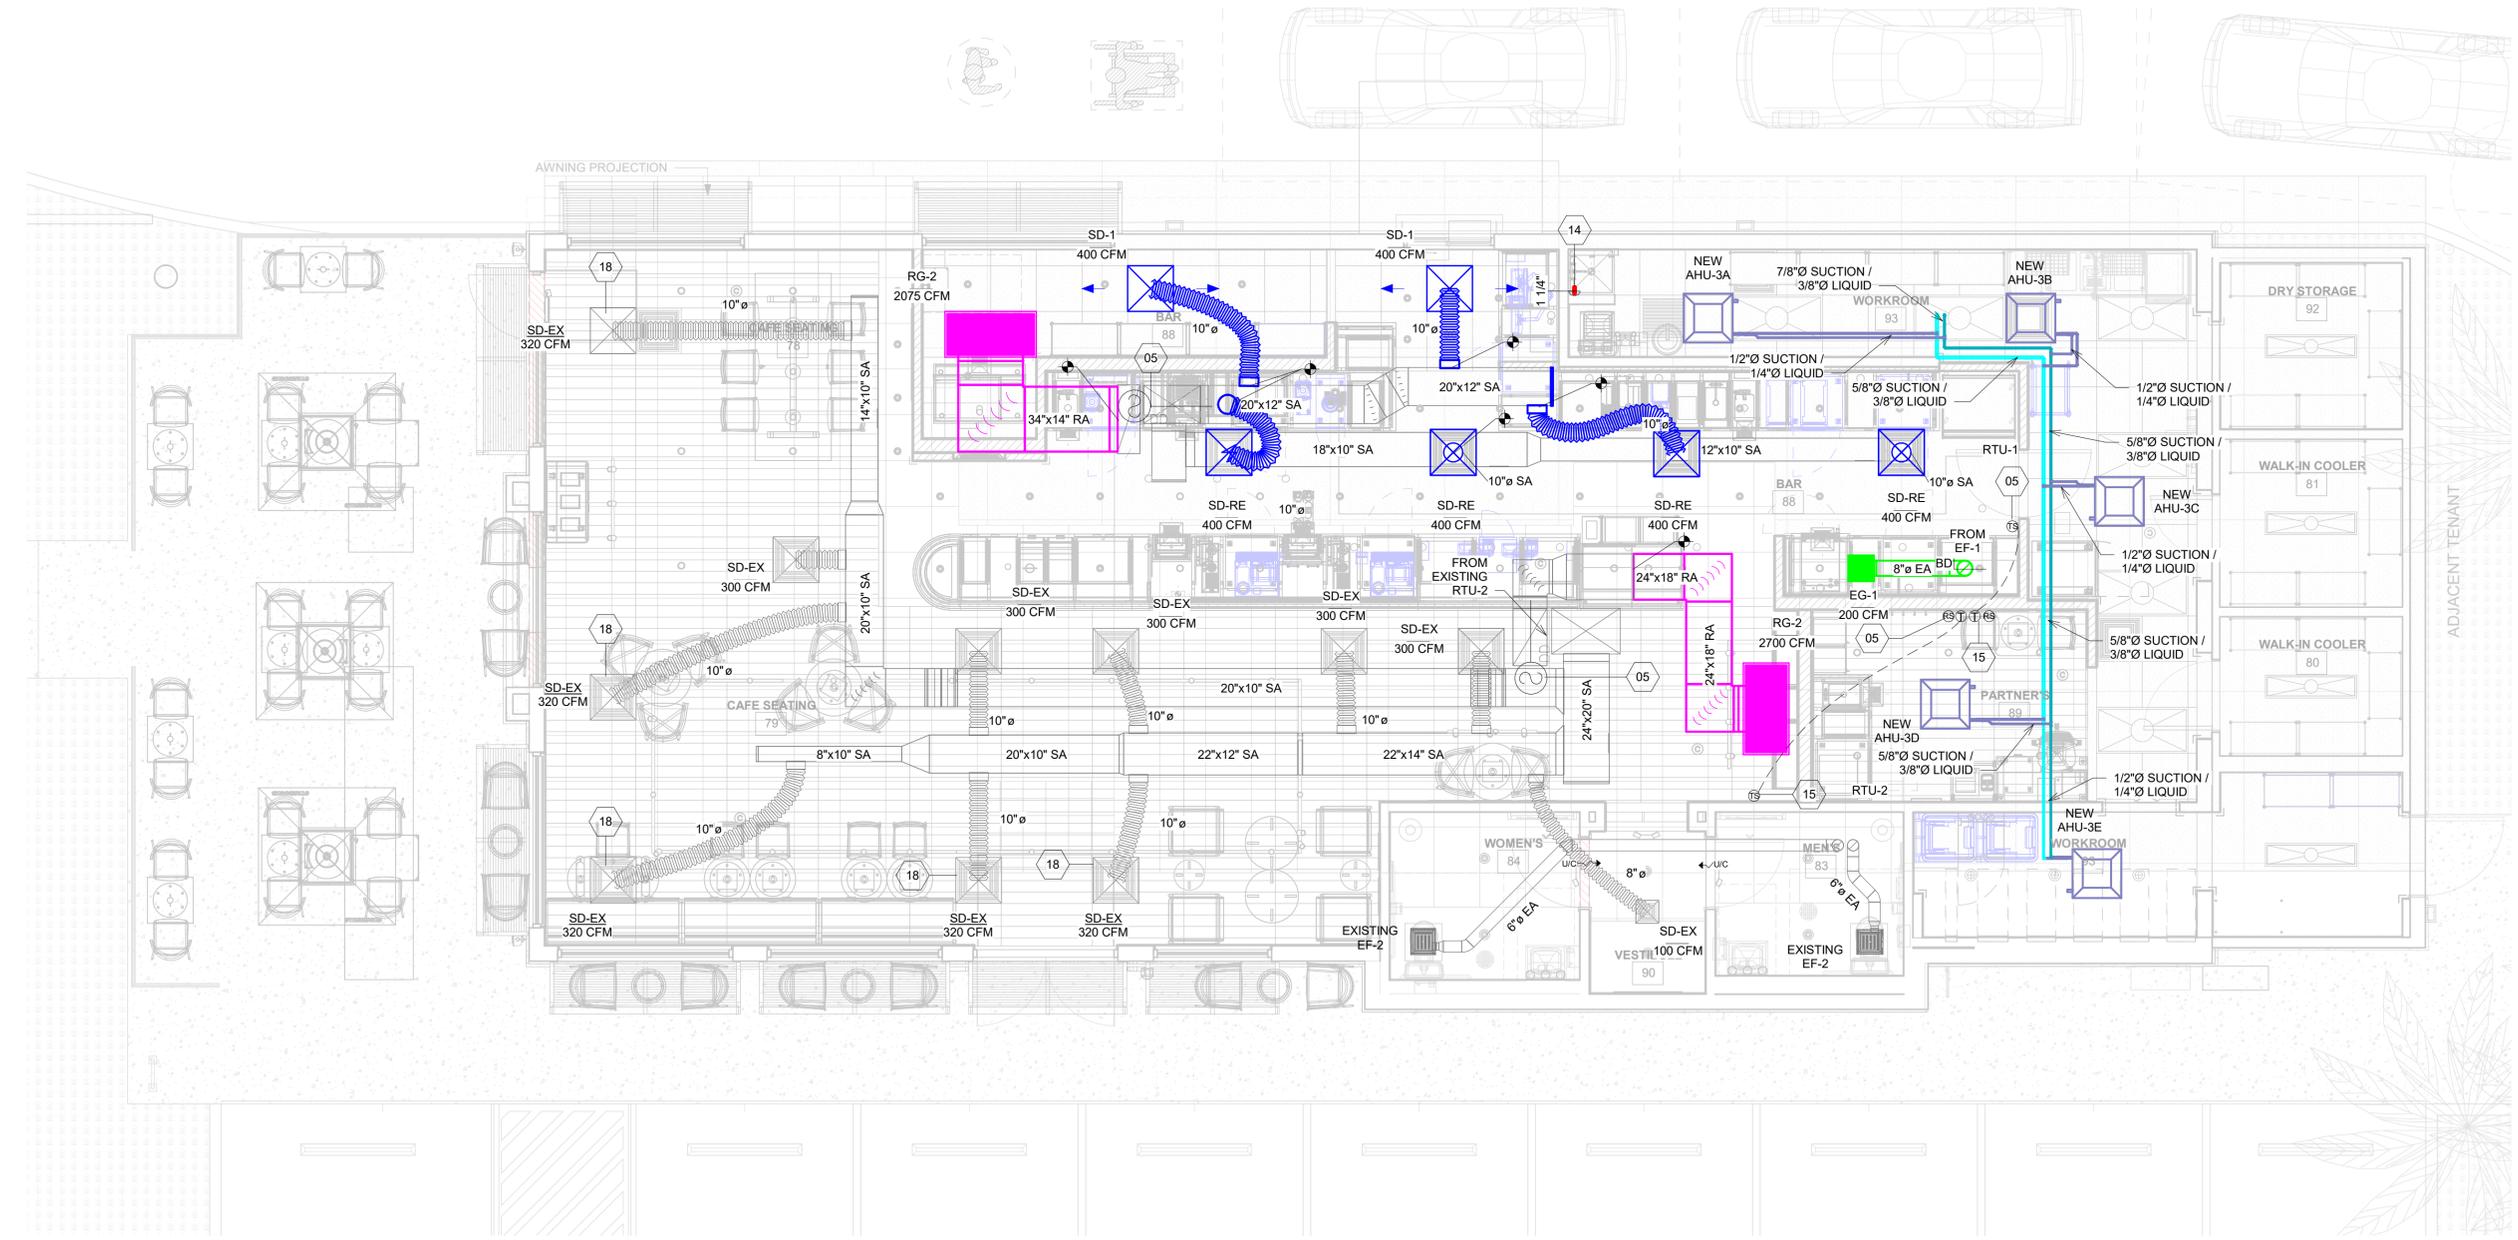

1 Mechanical Floor Plan
1/4" = 1'-0"

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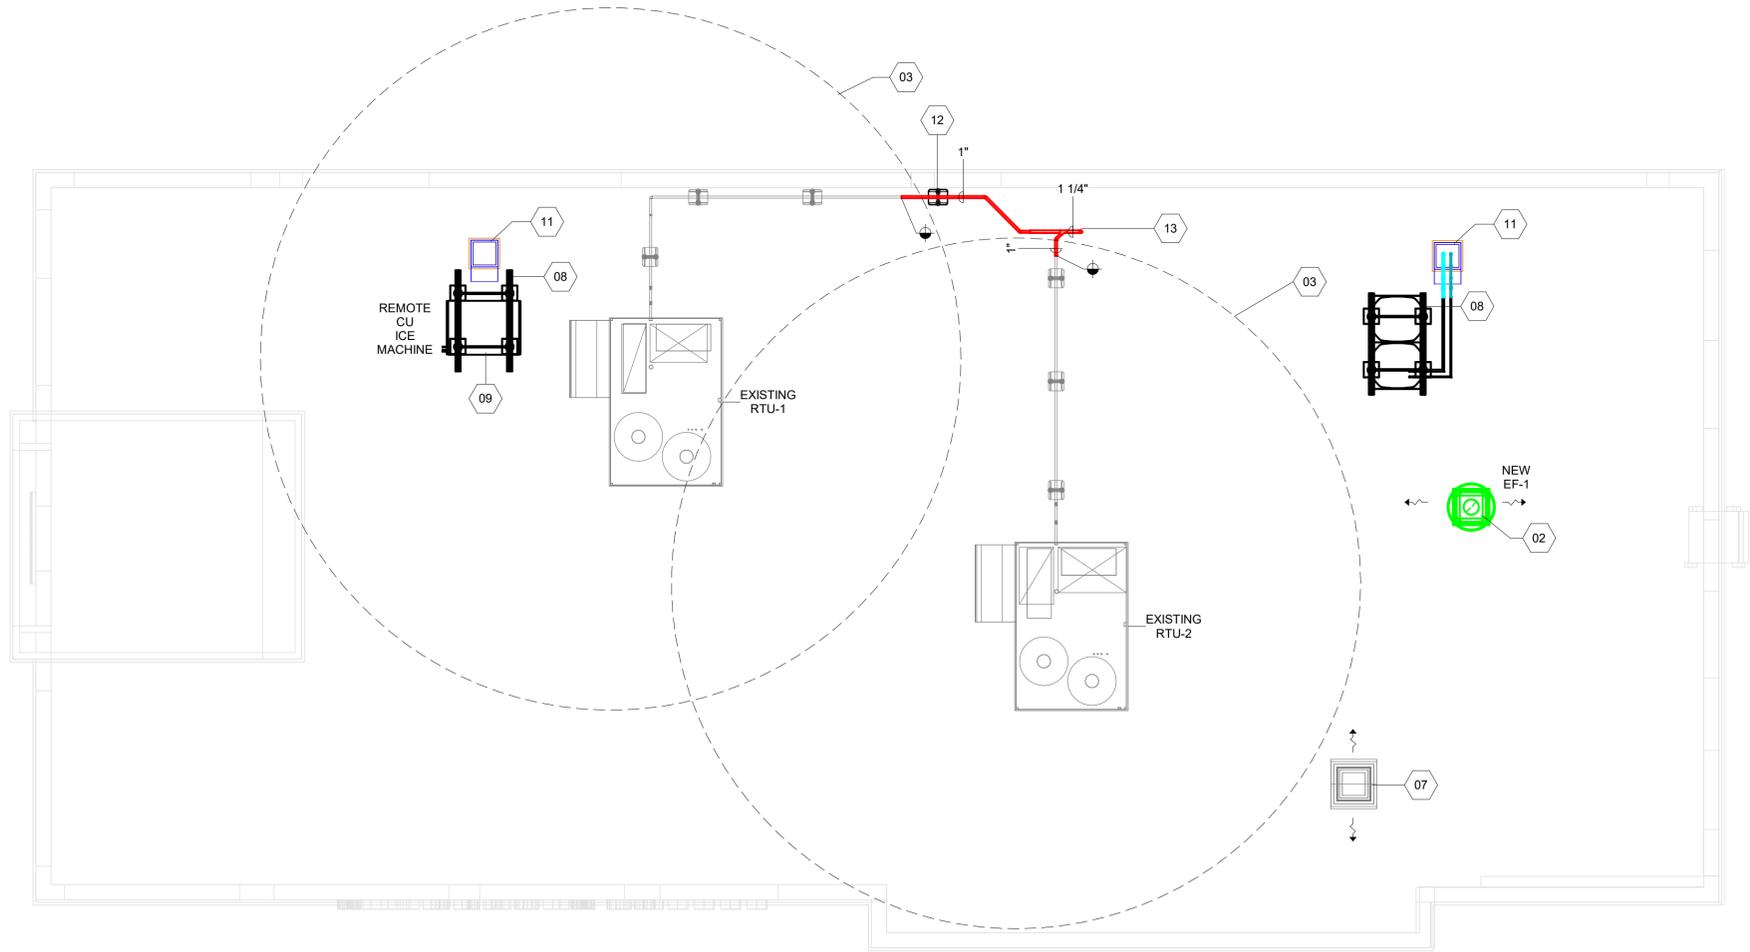
Revision Schedule			
Rev	Date	By	Description

SHEET TITLE:
MECHANICAL ROOF PLAN


SCALE: AS SHOWN

SHEET NUMBER:
M202

MECHANICAL KEYNOTES	
02	PROVIDE NEW EXHAUST FAN INSTALLED ON NEW CURB, REFERENCE DETAIL & FAN SCHEDULE.
03	OUTSIDE AIR INTAKE RADIUS. NO EXHAUST OR SANITARY PERMITTED INSIDE OF 15' - 0" RADIUS.
07	EXISTING ROOFTOP GRAVITY VENTILATOR TO REMAIN.
08	PROVIDE F&L ALUMINUM PARTS INC. ROOFTOP CONDENSER STAND OR EQUAL. INSTALL PER NOA 23-1206.01 INSTALLATION DETAILS. REFERENCE DETAIL.
09	LOCATION FOR REMOTE CONDENSER FOR ICE MACHINE.
11	PROVIDE ROOFTOP PIPE COWLING. REFERENCE DETAIL.
12	PROVIDE ROOFTOP CONDENSATE PIPING SUPPORT EVERY 5 FEET. TYPICAL FOR ALL ROOFTOP CONDENSATE PIPING. REFERENCE DETAIL.
13	PROVIDE PITCH POCKET / CHEM CURB OR EQUAL FOR CONDENSATE PIPE ROOF PENETRATION.



① Mechanical Roof Plan
1/4" = 1'-0"

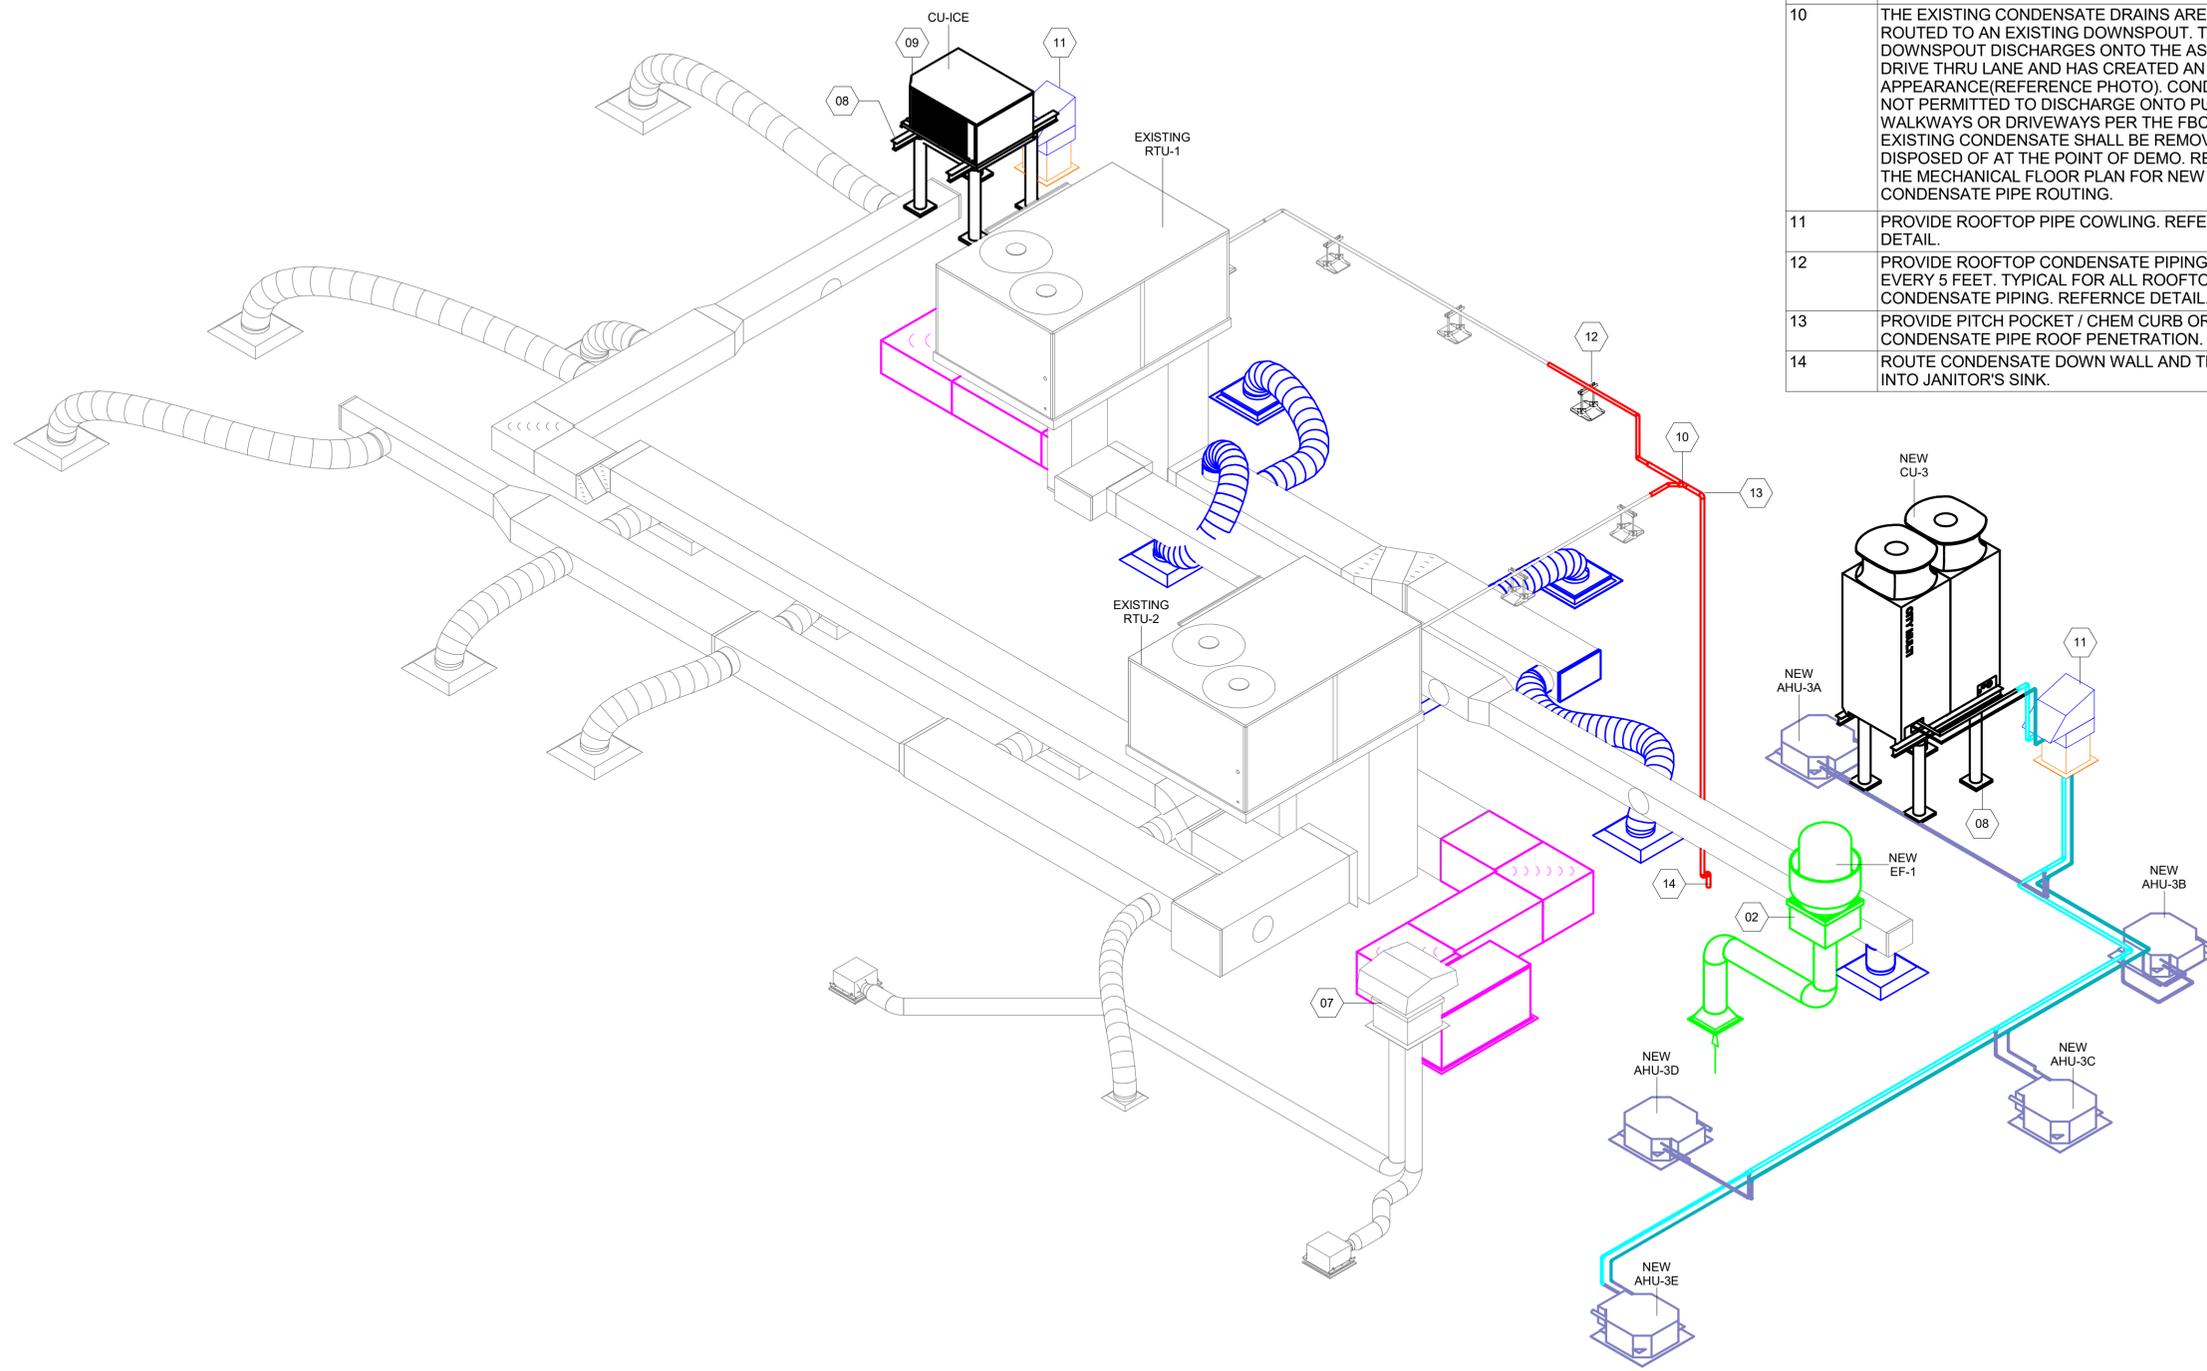

MECHANICAL KEYNOTES	
02	PROVIDE NEW EXHAUST FAN INSTALLED ON NEW CURB, REFERENCE DETAIL & FAN SCHEDULE.
07	EXISTING ROOFTOP GRAVITY VENTILATOR TO REMAIN.
08	PROVIDE F&L ALUMINUM PARTS INC. ROOFTOP CONDENSER STAND OR EQUAL. INSTALL PER NOA 23-1206.01 INSTALLATION DETAILS. REFERENCE DETAIL.
09	LOCATION FOR REMOTE CONDENSER FOR ICE MACHINE.
10	THE EXISTING CONDENSATE DRAINS ARE CURRENTLY ROUTED TO AN EXISTING DOWNSPOUT. THE EXISTING DOWNSPOUT DISCHARGES ONTO THE ASPHALT IN THE DRIVE THRU LANE AND HAS CREATED AN UNSIGHTLY APPEARANCE(REFERENCE PHOTO). CONDENSATE IS NOT PERMITTED TO DISCHARGE ONTO PUBLIC WALKWAYS OR DRIVEWAYS PER THE FBC. THE EXISTING CONDENSATE SHALL BE REMOVED AND DISPOSED OF AT THE POINT OF DEMO. REFERENCE THE MECHANICAL FLOOR PLAN FOR NEW CONDENSATE PIPE ROUTING.
11	PROVIDE ROOFTOP PIPE COWLING. REFERENCE DETAIL.
12	PROVIDE ROOFTOP CONDENSATE PIPING SUPPORT EVERY 5 FEET. TYPICAL FOR ALL ROOFTOP CONDENSATE PIPING. REFERENCE DETAIL.
13	PROVIDE PITCH POCKET / CHEM CURB OR EQUAL FOR CONDENSATE PIPE ROOF PENETRATION.
14	ROUTE CONDENSATE DOWN WALL AND TERMINATE INTO JANITOR'S SINK.

1 Mechanical Isometric



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Revision Schedule			
Rev	Date	By	Description

SHEET TITLE:
MECHANICAL ISOMETRIC
 SCALE: AS SHOWN

SHEET NUMBER:
M301

VRF HEAT PUMP SYSTEM CONDENSING UNIT SCHEDULE																	
C/U TAG	MANU.	MODEL	NOMINAL TONNAGE	COP	EER	REFRIG.	Ref. Piping Conn Sizes		OUTDOOR TEMP OPERATING RANGE	FAN QTY	FAN KW (EACH)	COMP. KW (ea)	VOLTAGE / PH.	MCA / MOCP	WEIGHT (lbs)	H X W X D (in)	
CU-3	mitsubishi	PUHY-P72TNUA-BS	6	4.04	11.9	R410A	7/8	3/8	COOLING - 23° - 126° / HEATING -13° - 60°	1	0.92	3.8	208 / 3 / 60	24 / 30	470	71-5/8" X 36-1/4" X 29-3/16"	

VRF SYSTEM AHU SCHEDULE																	
AHU TAG	MANU.	MODEL	DESIGN		UNIT RATING NOMINAL			E.S.P. (in wg.)	ENT. DB/WB	LEAVING DB/WB	COND. UNIT	HEAT MBH	VOLTAGE / PH.	MCA / MOCP	WEIGHT (lbs)	TYPE	H X W X D (in)
			MBH Total	MBH Sens.	MBH Total	MBH Sens.	UNIT CFM										
AHU-3A	mitsubishi	PLFY-P18NFMU-E	16.6	13.3	18.0	14.4	230-265-280	N/A	75.0 / 63.0	54.0 / 52	CU-3	20.0	208 / 1	.5 / 15	31.3	4 WAY CASSETTE	22-7/16 x 22/7-16 x 8-3/16
AHU-3B	mitsubishi	PLFY-P18NFMU-E	16.6	13.3	18.0	14.4	230-265-280	N/A	75.0 / 63.0	54.0 / 52	CU-3	20.0	208 / 1	.5 / 15	31.3	4 WAY CASSETTE	22-7/16 x 22/7-16 x 8-3/16
AHU-3C	mitsubishi	PLFY-P08NFMU-E	7.1	5.7	8.0	6.4	265-315-390	N/A	75.0 / 63.0	54.0 / 52	CU-3	9.0	208 / 1	.3 / 15	28.9	4 WAY CASSETTE	22-7/16 x 22/7-16 x 8-3/16
AHU-3D	mitsubishi	PLFY-P08NFMU-E	7.1	5.7	8.0	6.4	265-315-390	N/A	75.0 / 63.0	54.0 / 52	CU-3	9.0	208 / 1	.3 / 15	28.9	4 WAY CASSETTE	22-7/16 x 22/7-16 x 8-3/16
AHU-3E	mitsubishi	PLFY-P08NFMU-E	7.1	5.7	8.0	6.4	265-315-390	N/A	75.0 / 63.0	54.0 / 52	CU-3	9.0	208 / 1	.3 / 15	28.9	4 WAY CASSETTE	22-7/16 x 22/7-16 x 8-3/16

ACCEPTED ALTERNATES: DAIKIN, JCI, LENNOX

NOTES:

- REFRIGERATION NETWORK SHALL BE SIZED PER MANUFACTURER'S RECOMMENDATIONS. CONTACT VRF MANUFACTURER REPRESENTATIVE TO SIZE AND ROUTE REFRIGERANT LINES.
- EACH AIR HANDLER / CONDENSING UNIT REQUIRES ITS OWN SEPARATE POWER SUPPLY.
- CONTRACTOR TO PROVIDE WIRELESS ZONE CONTROLLER.
- PROVIDE REFRIGERANT SHUT OFF VALVES LOCATED AT EACH AHU & CU.
- PROVIDE AE-200 CENTRAL CONTROLLER.
- PROVIDE SEACOAT PROTECTION FOR CU-3.

FAN SCHEDULE		
MARK		EF-1
LOCATION EXHAUSTED		COMBI-OVEN HEAT
ROOFING		ROOFTOP
MANUFACTURER		GREENHECK
MODEL NUMBER		CUE-080-VG
EXTERNAL STATIC PRESSURE	IN. WG.	0.5
AIRFLOW	CFM	200
FAN	RPM	1501
	HP	1/10
MOTOR INFORMATION	CURRENT (A)	1.5
	V	115
	PH	1
	Hz	60
DIMENSIONS	Ø x H	22.25" Ø X 13.38"
WEIGHT	LBS	35
REMARKS:		1,2,3
ACCESSORIES:		A,B,C,D,E,F,G
GENERAL NOTES:		
1. LOCATE EXHAUST FAN AT LEAST 10' - 0" FROM ANY BUILDING OUTSIDE AIR INTAKE.		
2. PROVIDE WITH SINGLE POINT ELECTRICAL CONNECTION.		
3. PROVIDE MANUFACTURER'S RECOMMENDED CLEARANCE AROUND FAN.		
4. LOCATE EXHAUST OPENING A MINIMUM OF 10 FEET FROM ANY BUILDING OUTSIDE AIR INTAKE.		
ACCESSORIES:		
A. PROVIDE WITH DIRECT DRIVE EC MOTOR WITH POTENTIOMETER DIAL FOR BALANCING.		
B. NEMA 1 DISCONNECT SWITCH.		
C. BACKDRAFT DAMPER SIZED TO FULL DUCT CONNECTION DIMENSIONS (NO DAMPER TRAY)		
D. BACKWARD INCLINED FAN.		
E. RAIN TROUGH AND DRAIN.		
F. ROOF CURB - CONTRACTOR TO CONFIRM TOP OF CURB IS INSTALLED AT LEAST 8" ABOVE FINISHED ROOF.		
G. ALUMINUM BIRD SCREEN.		
REMARKS:		
1. PROVIDE FLEXIBLE DUCT CONNECTS TO FAN.		

GRILLE, REGISTER, & DIFFUSER SCHEDULE										
MARK	MANUF.	MODEL NO.	FACE SIZE / LENGTH	NECK SIZE	THROW / SLOTS	FRAME TYPE	FINISH	VOLUME DAMPER	NOTES	
SD-1	TITUS	TDC-AA	24" X 24"	PER PLANS	PER PLANS	LAY-IN	NOTE 1	NOTE 2	1,2,3,4,5	
RG-1	TITUS	350RL	48" X 24"	44" X 20"	PER PLANS	LAY-IN	NOTE 1	NOTE 6	1,6	
SPECIAL NOTES: ** ALL DIFFUSERS SELECTED WITH NC RATING < 20 **										
1. COORDINATE COLOR WITH ARCHITECT										
2. PROVIDE VOLUME DAMPER AT THE FLEX TAP. PROVIDE YOUNG REGULATOR FOR VOLUME DAMPERS IN INACCESSIBLE AREAS.										
3. PROVIDE TITUS RAPID MOUNT FRAME FOR STANDARD 24" x 24" LAY-IN STYLE DIFFUSERS MOUNTED IN HARD CEILINGS, & FOR ALL 12" X 12" SUPPLY DIFFUSERS - REGARDLESS OF THE MOUNTING LOCATION.										
4. PROVIDE OPTIONAL R-8 MOLDED INSULATION BLANKET FOR ALL LAY-IN STYLE DIFFUSERS.										
5. PROVIDE WITH 18" X 18" CORE.										
6. PROVIDE WITH OPPOSED BLADE DAMPER.										

DUCT CONSTRUCTION SCHEDULE						
DUCTWORK SYSTEM	DUCTWORK SYSTEM ABBREVIATION	DUCTWORK LOCATION	DUCTWORK SHAPE	DUCTWORK MATERIAL	DUCTWORK INSULATION	DUCT CONSTRUCTION STANDARD
SUPPLY AIR - LOW PRESSURE	SA	CONCEALED ABOVE THE CEILING (CONDITIONED PLENUM)	SQUARE / ROUND	GALVANIZED SHEET STEEL; LOCK- FORMING QUALITY; ASTM A653/A 653M, G90 COATING DESIGNATION; MIL-PHOSPHATIZED FINISH FOR SURFACES OF DUCT EXPOSED TO VIEW	R6 EXTERNAL	HVAC DUCT CONSTRUCTION STANDARDS - METAL AND FLEXIBLE - ± 2" WG
RETURN AIR	RA	CONCEALED ABOVE THE CEILING (CONDITIONED PLENUM)	SQUARE / ROUND	GALVANIZED SHEET STEEL; LOCK- FORMING QUALITY; ASTM A653/A 653M, G90 COATING DESIGNATION; MIL-PHOSPHATIZED FINISH FOR SURFACES OF DUCT EXPOSED TO VIEW	R6 EXTERNAL	HVAC DUCT CONSTRUCTION STANDARDS - METAL AND FLEXIBLE - ± 2" WG
EXHAUST AIR	EA	CONCEALED ABOVE THE CEILING (CONDITIONED PLENUM)	SQUARE / ROUND	GALVANIZED SHEET STEEL; LOCK- FORMING QUALITY; ASTM A653/A 653M, G90 COATING DESIGNATION; MIL-PHOSPHATIZED FINISH FOR SURFACES OF DUCT EXPOSED TO VIEW	NOT REQUIRED	HVAC DUCT CONSTRUCTION STANDARDS - METAL AND FLEXIBLE - ± 2" WG
SUPPLY/ RETURN AIR - FLEX DUCTS	SA	CONCEALED ABOVE THE CEILING (UNCONDITIONED SPACE)	ROUND	COMPLY UL 181 CLASS 1, FACTORY FABRICATED, INSULATED, ROUND DUCT, WITH A POLYETHYLENE FILM OUTER JACKET ENCLOSING GLASS FIBER INSULATION (R-6) AROUND A CONTINUOUS POLYETHYLENE INNER LINER. THE INNER LINER SHALL HAVE AN ENCAPSULATED STEEL WIRE HELIX.	R6	HVAC DUCT CONSTRUCTION STANDARDS - METAL AND FLEXIBLE - ± 2" WG
NOTES:						
1. ALL INSULATION WILL HAVE FIRE/SMOKE RATING LESS THAN 25/50.						
2. ALL DUCT DIMENSIONS SHOWN ARE CLEAR INSIDE DIMENSIONS.						
3. ALL BRANCH TAKE-OFFS TO BE PROVIDED W/ MANUAL VOLUME DAMPERS. ALL ELBOWS AND TEE'S MUST BE FURNISHED WITH TURNING VANES. PROVIDE MANUAL VOLUME DAMPERS WITH EXTRACTOR AT ALL FLEX TAKE-OFFS.						

AIR BALANCE SCHEDULE			
UNIT	EXHAUST / RELIEF	OUTSIDE AIR / MAKEUP AIR	TOTAL
RTU-1		325	
RTU-2		700	
EF-1	200		
EF-2 (QTY 2)	160		
BUILDING TOTALS:	360	1025	675

VENTILATION CALCULATIONS - RTU-1									
(BASED ON FBCM 8TH EDITION TABLE 403.3.1.1)									
OCCUPANCY CATEGORY	SQ FT	SF/P	P	CFM/P	CFM/SF	CFM (P)	CFM (AREA)	TOTAL CFM	NOTES
Food and Beverage Service									
Kitchens (Cooking)	1016	50	20	7.5	0.12	152	122	274	
Offices									
Office Spaces	104	200	1	5	0.06	3	6	9	
Public Spaces									
Corridors	133	0	0	0	0.06	0	8	8	
Retail Stores, Sales Floors, and Showroom Floors									
Storage Rooms	59	0	0	0	0.12	0	7	7	
								TOTAL CFM REQUIRED:	298
								TOTAL CFM PROVIDED:	325
NOTES:									
FOR ALL CATEGORIES: OCCUPANCY CATEGORY AND DENSITY FROM TABLE 403.3.1.1 FBCM 8TH EDITION.									

VENTILATION CALCULATIONS - RTU-2									
(BASED ON FBCM 8TH EDITION TABLE 403.3.1.1)									
OCCUPANCY CATEGORY	SQ FT	SF/P	P	CFM/P	CFM/SF	CFM (P)	CFM (AREA)	TOTAL CFM	NOTES
Food and Beverage Service									
Dining Rooms	945	14	66	7.5	0.18	496	170	666	
Public Spaces									
Corridors	41	0	0	0	0.06	0	2	2	
Toilet Rooms (Public)	120	0	0	0	0	0	0	0	
								TOTAL CFM REQUIRED:	669
								TOTAL CFM PROVIDED:	700
NOTES:									
FOR ALL CATEGORIES: OCCUPANCY CATEGORY AND DENSITY FROM TABLE 403.3.1.1 FBCM 8TH EDITION.									



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Revision Schedule			
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SHEET TITLE:
MECHANICAL SCHEDULES
 SCALE: AS SHOWN

SHEET NUMBER:
M401

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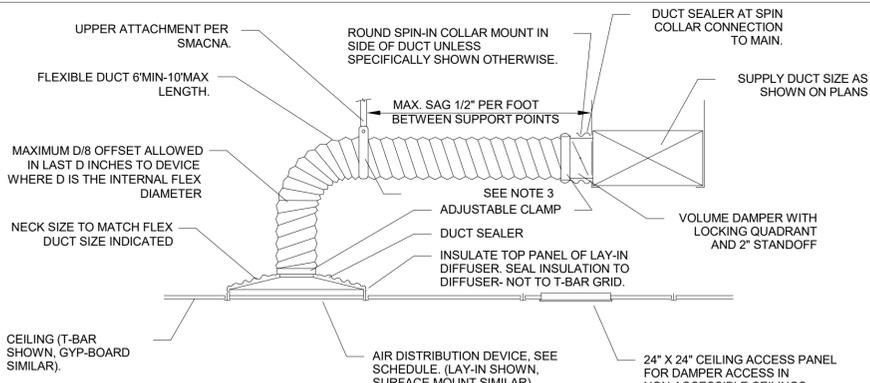
SHEET TITLE:
MECHANICAL DETAILS

SCALE: AS SHOWN

SHEET NUMBER:
M501

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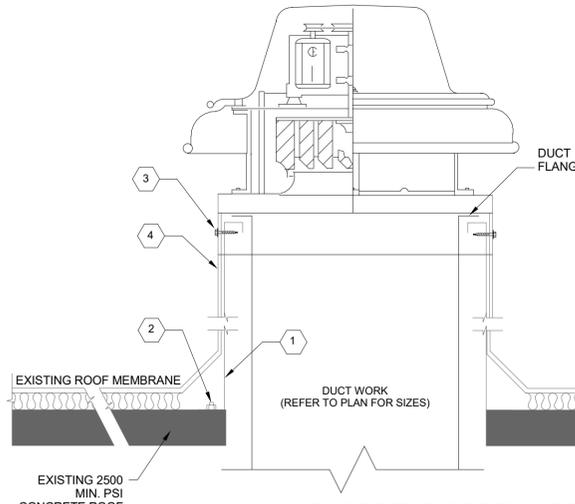
NOA # 23-1120.06



FLEXIBLE DUCT NOTES

1. FLEXIBLE DUCTS SHALL BE ONE-PIECE AND SHALL NOT BE SPLICED TOGETHER.
2. EXTEND FLEXIBLE DUCT INSULATION TO DUCT/DIFFUSER PANEL INSULATION AND SEAL WITH MASTIC.
3. MINIMUM 1" WIDE 22 GALVANIZED STRAP HANGER WITH HEMMED EDGES PER SMACNA, FIGURE 3-10
4. FLEXIBLE AIR DUCT SHALL BE FULLY EXTENDED AND NOT COMPRESSED WITH ELBOW RADIUS NO LESS THAN R/D = 1.0.

1 FLEXIBLE DUCT DETAIL N.T.S.




2 G MODEL ROOF FAN PENETRATION DETAIL N.T.S.

KEYNOTES:

1. EXISTING N.O.A.-RATED ROOF CURB SHALL BE PROVIDED BY GREENHECK, 18 GA MINIMUM, 42" TALL MAX. WELDED CONSTRUCTION AND MATCHED TO THE FAN.
2. ENSURE THAT THE EXISTING ANCHORS THE CURB TO THE ROOF STRUCTURE ARE 12 (3 PER SIDE) 3/8" S.S. HILTI KWIK BOLT 3 EXPANSION ANCHORS, MIN 2.50" ENGAGEMENT, 5" MIN EDGE DISTANCE. INSTALL IN STRICT ACCORDANCE WITH MANUFACTURER INSTALLATION INSTRUCTIONS.
3. SECURE THE FAN TO CURB USING 12 (3 PER SIDE) 5/16 SELF DRILLING SHEET METAL SCREWS. MOUNT IN STRICT ACCORDANCE WITH MANUFACTURER INSTALLATION INSTRUCTIONS.
4. EXTEND ROOF MEMBRANE UP AND SECURE TO WOOD NAIL STRIP AT TOP OF CURB. MATCH EXISTING ROOF MEMBRANE IF EXISTING.

DETECTOR MOUNTING INSTRUCTIONS

1. REMOVE BACKING FROM TEMPLATE AND SECURE TO DUCT IN DESIRED LOCATION.
2. CENTER PUNCH AT (2) "A" TARGET CENTERS FOR SAMPLING TUBES.
3. FOR RECTANGULAR SIDE-BY-SIDE MOUNTING CONFIGURATION CENTER PUNCH AT (2) "B" TARGET CENTERS FOR MOUNTING TABS. -OR- FOR SQUARE TOP-OVER-BOTTOM MOUNTING CONFIGURATION CENTER PUNCH AT (2) "C" TARGET CENTERS FOR MOUNTING TABS.
4. AT TARGET "A" CENTERS DRILL PILOT HOLES AND CUT TWO 1.375" DIAMETER HOLES USING A 1 3/8" HOLES SAW OR PUNCH. AT TARGET "B" OR "C" CENTERS DRILL .156" DIAMETER HOLES USING A 5/32" DRILL.
5. FOR SQUARE MOUNTING CONFIGURATION DRILL AN ADDITIONAL .156" DIAMETER HOLE AT THE LOCATION OF ONE OF THE MOUNTING TABS ON THE LOWER HOUSING.
6. SEE MANUAL FOR FURTHER INSTRUCTIONS.

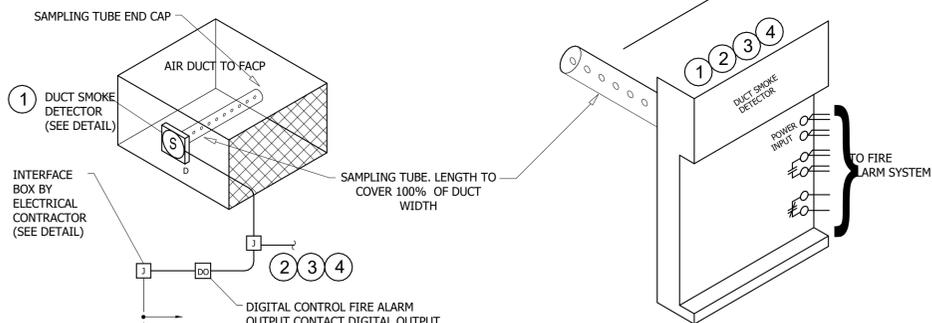

INTERFACE CIRCUIT LAYOUT NO SCALE

DUCT SMOKE DETECTOR INSTALLATION DETAIL NO SCALE

REFERENCE NOTES

1. DETECTOR SHALL BE SUPPLIED AND WIRED BY THE FIRE ALARM SYSTEM CONTRACTOR.
2. DETECTOR SHALL ASSIGNED IT'S OWN ADDRESS IN THE ADDRESSABLE FIRE ALARM SYSTEM
3. DETECTOR SHALL BE RESETTABLE FROM THE FIRE ALARM CONTROL PANEL.
4. UPDATE FIRE ALARM SYSTEM ADDRESS LIST FOR EACH DUCT SMOKE DETECTOR AND DIGITAL CONTROL DEVICE.


GENERAL NOTES

- A. EXACT NUMBER OF CONDUCTORS DEPENDENT OF FIRE ALARM SYSTEM BEING USED, CONFIRM NUMBER AND TYPE REQUIRED AT EACH LOCATION WITH FIRE ALARM SYSTEM SUPPLIER.
- B. PLACE AND INSTALL DUCT SMOKE DETECTOR IN AN ACCESSIBLE LOCATIONS, AND IN FULL COMPLIANCE WITH SMOKE DETECTOR MANUFACTURER'S PLACEMENT AND INSTRUCTIONS. PROVIDE DUCT ACCESS DOOR FOR TUBE INSPECTION/CLEANING.
- C. ENSURE THAT THE SAMPLING TUBE END CAP IS INSTALLED AS THIS IS CRITICAL TO CREATE THE PROPER AIRFLOW TO THE SENSOR OF THE DUCT DETECTOR


3 DUCT SMOKE DETECTOR DETAIL

FLEXIBLE DUCT NOTES

1. FLEXIBLE DUCTS SHALL BE ONE-PIECE AND SHALL NOT BE SPLICED TOGETHER, 8'-0" MAX LENGTH.
2. EXTEND FLEXIBLE DUCT INSULATION TO DUCT/DIFFUSER PANEL INSULATION AND SEAL WITH MASTIC.
3. MINIMUM 1" WIDE 22 GALVANIZED STRAP HANGER WITH HEMMED EDGES PER SMACNA, FIGURE 3-10
4. FLEXIBLE AIR DUCT SHALL BE FULLY EXTENDED AND NOT COMPRESSED WITH ELBOW RADIUS NO LESS THAN R/D = 1.0.






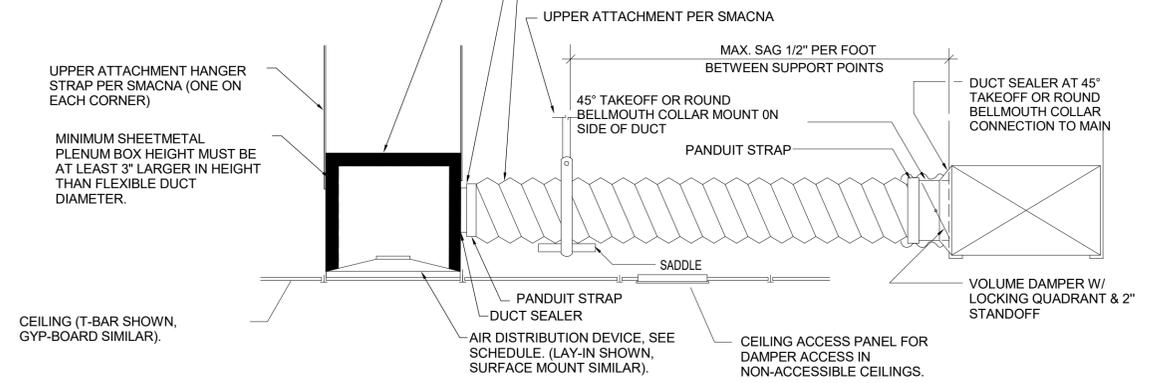


4 FLEX DUCT TAKEOFF - LIMITED INTERSTITIAL SPACE N.T.S.

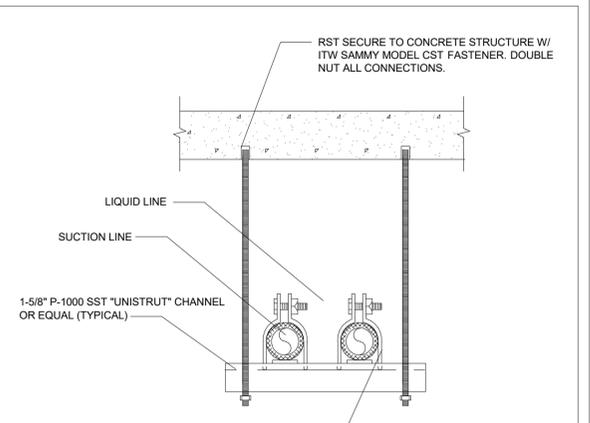

5 PIPE HANGER CEILING SUPPORT DETAIL N.T.S.

PROVIDE COPPER B-LINE IPH SERIES ARMAFIX CLAMP W INSERT FOR 3/4" WALL INSULATION THICKNESS.

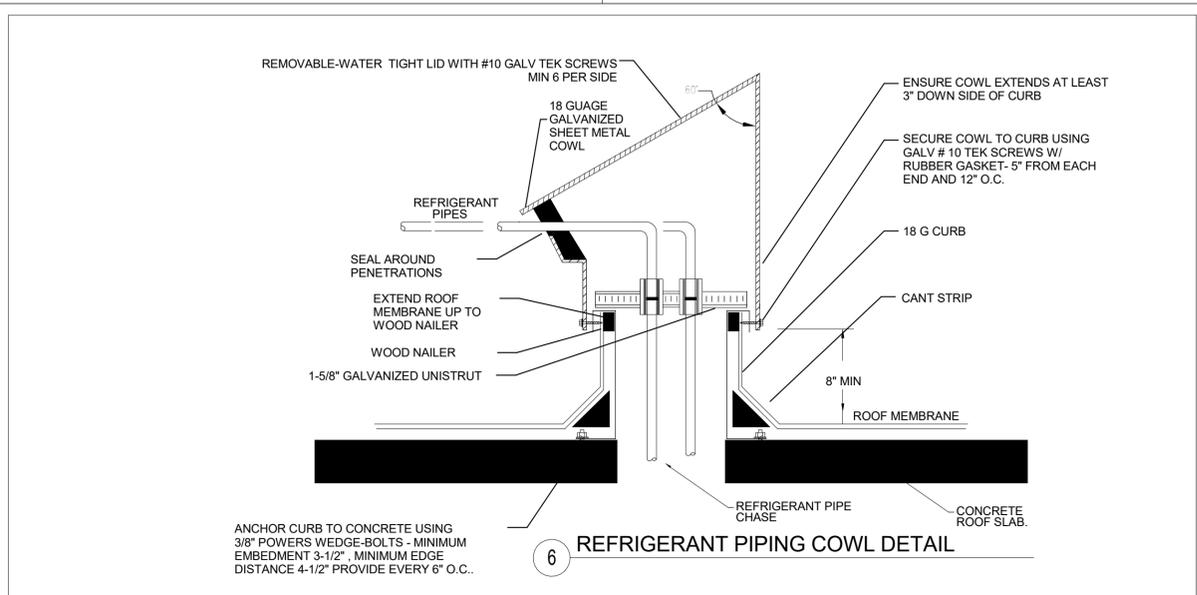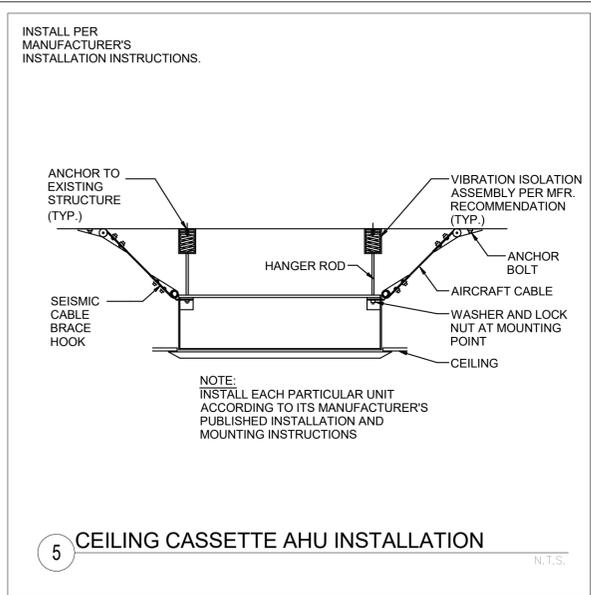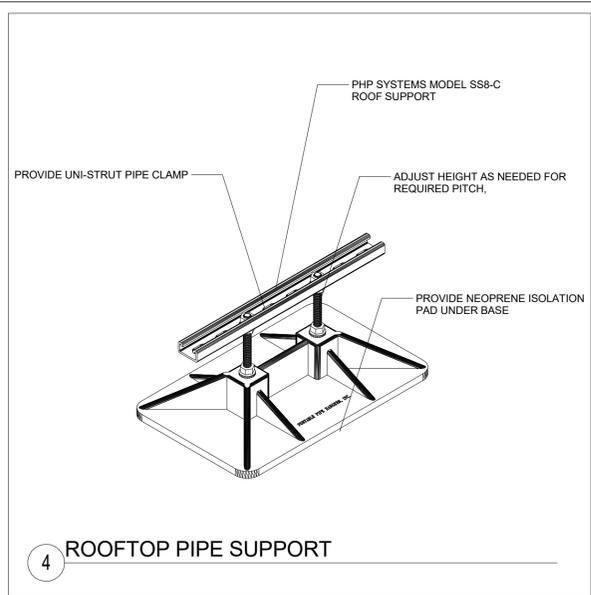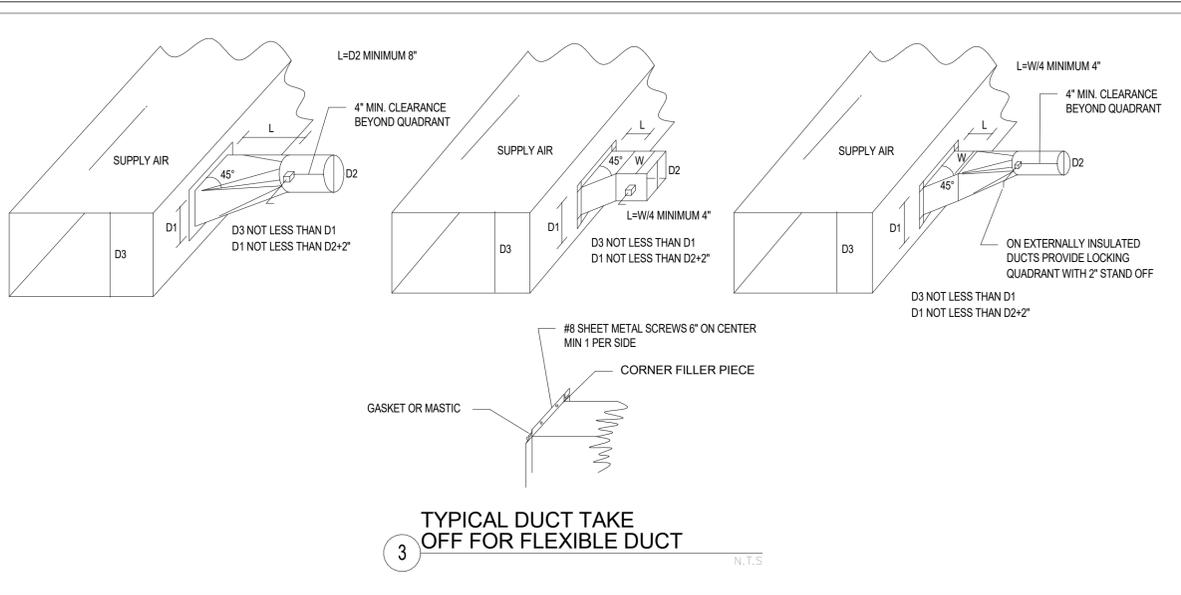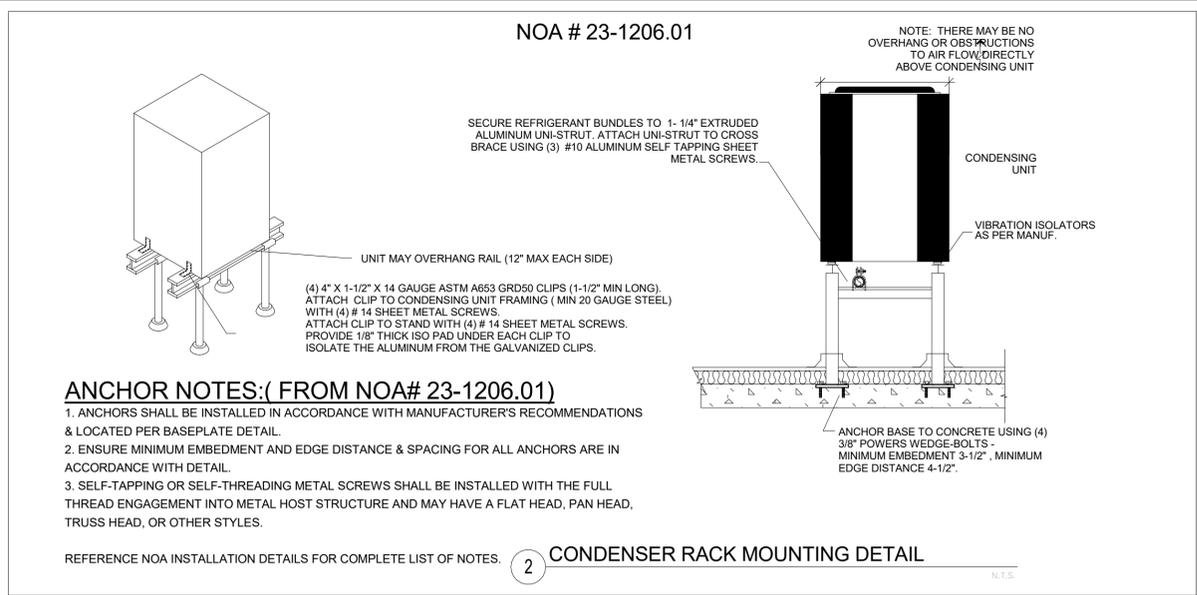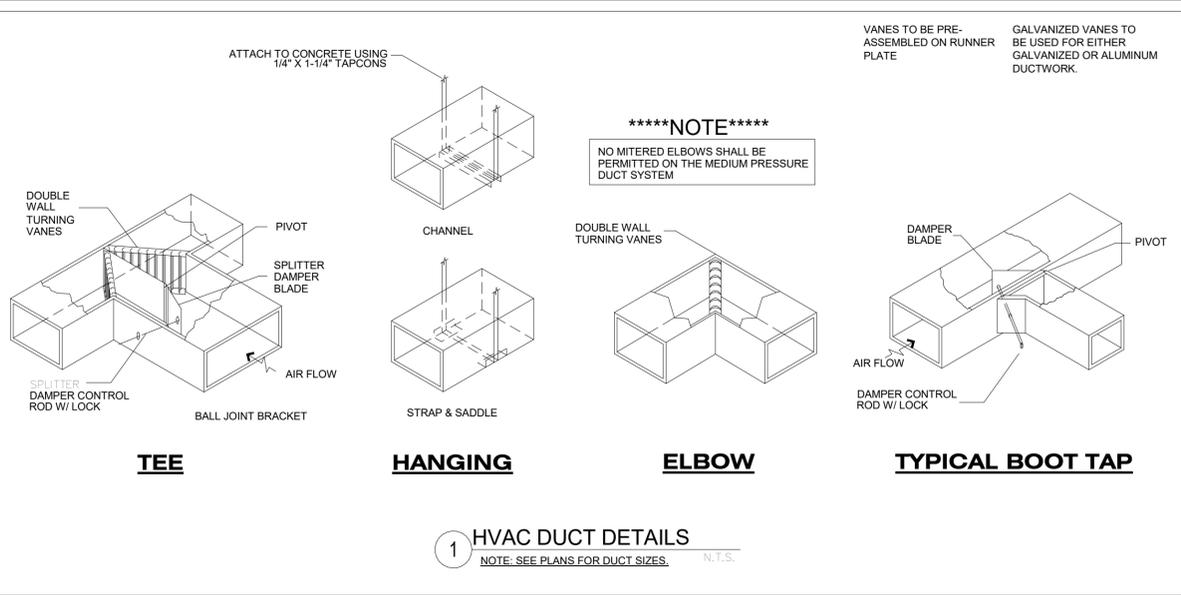

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STARBUCKS TEMPLATE VERSION: i2024.01.01

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PROJECT NAME:
A1A & 10TH

PROJECT ADDRESS:
**975 3RD STREET SOUTH
JACKSONVILLE BEACH, FL 32250**

STORE #: 8565
PROJECT #: 18756-108
ISSUE DATE: 03-27-2024
DESIGN MANAGER: ROMINA VIGNOLO
PRODUCTION DESIGNER: GENSLER
CHECKED BY: GENSLER

Revision Schedule			
Rev	Date	By	Description

SHEET TITLE:
MECHANICAL DETAILS

SCALE: AS SHOWN


SHEET NUMBER:
M502

DIAGRAM SYMBOL LEGEND		CONT.No	PAGE
---	DESCRIPTION		
---	POWER WIRE		
---	CONTROL WIRE		
---	REF. PIPE		

CITY MULTI SYSTEM SCHEMATIC DWG.

This drawing is schematic in nature. Final routing of piping & wiring shall be determined by the installing contractor and/or designer of record. Additional refrigerant charge is needed depending on the size and length of extended piping. Please refer the amount of pre-charge and the formula of calculation which is mentioned on the data book.
 1.25mm²(16 AWG) : 1.25mm²(16 AWG) or more. 0.75mm²(20 AWG) : between 0.5mm²(24 AWG) and 0.75mm²(20 AWG).

PIPING AND CONTROLS	
SYMBOL	BRANCH PIPE MODEL NAME
J1	CMY-Y102LS-G2
J2	CMY-Y102SS-G2
SYMBOL	LIQUID PIPE/GAS PIPE SIZE
P1	3/8 / 7/8
P2	3/8 / 5/8
P3	1/4 / 1/2
SYMBOL	MODEL NUMBER
WAWR	PAR-FL32MA-E

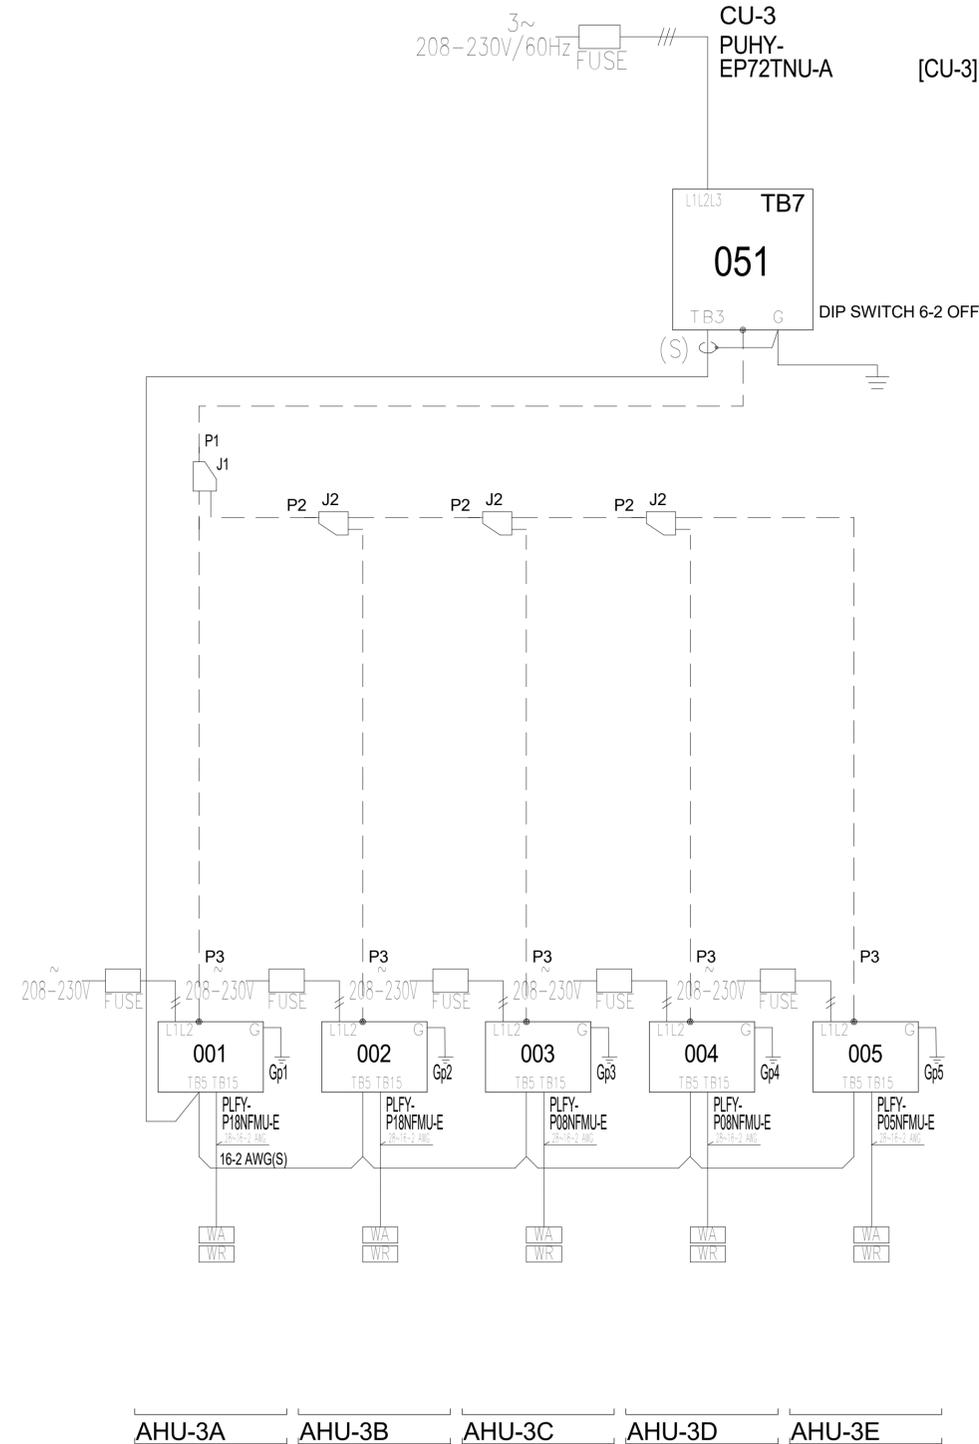

Diamond System Builder
 sw: 5.2.3.3
 db: 5.2.3.6
 3/14/2024
 1:54 PM

REMARKS
 Comments:

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STARBUCKS TEMPLATE VERSION: i2024.01.01



PROJECT NAME:
A1A & 10TH

PROJECT ADDRESS:
 975 3RD STREET SOUTH
 JACKSONVILLE BEACH, FL 32250

STORE #: 8565
 PROJECT #: 18756-108
 ISSUE DATE: 03-27-2024
 DESIGN MANAGER: ROMINA VIGNOLO
 PRODUCTION DESIGNER: GENSLER
 CHECKED BY: GENSLER

Revision Schedule			
Rev	Date	By	Description

SHEET TITLE:
MECHANICAL VRF SCHEMATIC
 SCALE: AS SHOWN

SHEET NUMBER:
M503

24-1030

Location 975 3RD STREET SOUTH, JACKSONVILLE BEACH
Building owner Starbucks
Program user RGD & Associates Inc
Company RGD & Associates Inc
Comments

By RGD Consulting Engineers
Dataset name X:_Active_Projects\24-1030 SBUX 8565 A1A & 10TH_SMEP_Project\Mechanical\Cooling Loads\24-1030 SBUX 8565 A1A & 10th.trc

Calculation time 10:33 AM on 03/06/2024
TRACE@ 700 version

Location Jacksonville, Florida
Latitude 30.0 deg
Longitude 81.0 deg
Time Zone 5
Elevation 24 ft
Barometric pressure 29.9 in. Hg

Air density 0.0760 lb/cu ft
Air specific heat 0.2444 Btu/lb-F
Density-specific heat product 1.1144 Btu/h-cfm-F
Latent heat factor 4.905.3 Btu-min/h-cu ft
Enthalpy factor 4.5588 lb-min/h-cu ft

Summer design dry bulb 97.3 F
Summer design wet bulb 76.5 F
Winter design dry bulb 32.0 F
Summer clearness number 0.95
Winter clearness number 0.95
Summer ground reflectance 0.20
Winter ground reflectance 0.20
Carbon Dioxide Level 400 ppm

Design simulation period January - December
Cooling load methodology TETD-TA1
Heating load methodology UAUT



Zone Checksums
By RGD Engineers

ZONE 2

Table with 4 main sections: COOLING COIL PEAK, CLG SPACE PEAK, HEATING COIL PEAK, and TEMPERATURES. Includes sub-sections for AIRFLOWS and ENGINEERING CKS. Data includes capacity, airflow, and temperature values for various components.

Project Name: 24-1030
Dataset Name: 24-1030 SBUX 8565 A1A & 10TH.TR

TRACE@ 700 v6.3.5 calculated at 01:51 PM on 03/14/2024
Alternative - 1 System Checksums Report Page 2 of 3

Zone Checksums
By RGD Engineers

ZONE 1

Table with 4 main sections: COOLING COIL PEAK, CLG SPACE PEAK, HEATING COIL PEAK, and TEMPERATURES. Includes sub-sections for AIRFLOWS and ENGINEERING CKS. Data includes capacity, airflow, and temperature values for various components.

Project Name: 24-1030
Dataset Name: 24-1030 SBUX 8565 A1A & 10TH.TR

TRACE@ 700 v6.3.5 calculated at 01:51 PM on 03/14/2024
Alternative - 1 System Checksums Report Page 1 of 3

Zone Checksums
By RGD Engineers

ZONE 3

Table with 4 main sections: COOLING COIL PEAK, CLG SPACE PEAK, HEATING COIL PEAK, and TEMPERATURES. Includes sub-sections for AIRFLOWS and ENGINEERING CKS. Data includes capacity, airflow, and temperature values for various components.

Project Name: 24-1030
Dataset Name: 24-1030 SBUX 8565 A1A & 10TH.TR

TRACE@ 700 v6.3.5 calculated at 01:51 PM on 03/14/2024
Alternative - 1 System Checksums Report Page 3 of 3



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STARBUCKS TEMPLATE VERSION: i2024.01.01

PERMIT SET - FOR CONSTRUCTION USE



PROJECT NAME: A1A & 10TH

PROJECT ADDRESS: 975 3RD STREET SOUTH JACKSONVILLE BEACH, FL 32250

STORE #: 8565
PROJECT #: 18756-108
ISSUE DATE: 03-27-2024
DESIGN MANAGER: ROMINA VIGNOLO
PRODUCTION DESIGNER: GENSLER
CHECKED BY: GENSLER

Revision Schedule table with columns: Rev, Date, By, Description

SHEET TITLE: MECHANICAL CALCULATIONS
SCALE: AS SHOWN

SHEET NUMBER: M601




ABBREVIATIONS

AFF	ABOVE FINISHED FLOOR
AHJ	AUTHORITIES HAVING JURISDICTION
APPROX	APPROXIMATE
BLDG	BUILDING
CLG	CEILING
CONST	CONSTRUCTION
CW	DOMESTIC COLD WATER
CXA	COMMISSIONING AGENT
DEG	DEGREES
DN	DOWN
DTL	DETAIL
DWG(S)	DRAWING(S)
EA	EACH
EC	ELECTRICAL CONTRACTOR
ELEC	ELECTRICAL
EMER	EMERGENCY
EXIST	EXISTING
EXT	EXTERIOR
FD	FLOOR DRAIN
FS	FLOOR SINK
F&I	FURNISH & INSTALL
FOIC	FURNISHED BY OWNER,
FOIO	INSTALLED BY CONTRACTOR
	FURNISHED BY OWNER,
	INSTALLED BY OWNER
FLR	FLOOR
FT	FOOT/FEET
FCO	FLOOR CLEANOUT
GC	GENERAL CONTRACTOR
GFCI	GROUND FAULT CIRCUIT INTERRUPTER
GW	GREASE WASTE
HR	HOUR
HVAC	HEATING, VENTILATION, AND AIR
	CONDITIONING
HW	HOT WATER
HS	HANDSINK
HWS	HOT WATER SUPPLY
HWR	HOT WATER RETURN
LL	LANDLORD
LV	LOW VOLTAGE
MAX	MAXIMUM
MC	MECHANICAL CONTRACTOR
MDP	MAIN DISTRIBUTION PANEL
MECH	MECHANICAL
MEP	MECHANICAL, ELECTRICAL, AND PLUMBING
MFG	MANUFACTURER
MIN	MINIMUM
MS	MOP SINK
NL	NIGHTLIGHT
NTS	NOT TO SCALE
PC	PLUMBING CONTRACTOR
PS	PREP SINK
POC	POINT OF CONNECTION
REF	REFERENCE
REQ'D	REQUIRED
REV	REVISION
SHT	SHEET
SF	SQUARE FEET
SPECS	SPECIFICATION(S)
SSL	STAINLESS STEEL
TST	TELEPHONE
TEMP	TEMPORARY
TMV	TEMPERATURE MIXING VALVE
TW	TEMPERED HOT WATER
TYP	TYPICAL
UC	UNDER COUNTER
UNO	UNLESS NOTED OTHERWISE
V	VENT
SW	SANITARY WASTE
WCO	WALL CLEANOUT
WH	WATER HEATER
WP	WEATHER PROOF

LANDLORD REQUIREMENTS

PRIOR TO BID: THE CONTRACTOR SHALL COORDINATE WITH LANDLORD / BUILDING OWNER FOR ANY CONSTRUCTION REQUIREMENTS. CONTRACTOR SHALL BECOME COMPLETELY FAMILIAR WITH REQUIREMENTS AND ADHERE TO THEM. WHERE LANDLORD / BUILDING OWNER REQUIREMENTS ARE MORE STRINGENT THAN SHOWN IN THESE PLANS, LANDLORD / BUILDING OWNER REQUIREMENTS SHALL GOVERN.

PLUMBING SYMBOL LEGEND

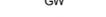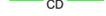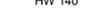	PIPE UP
	PIPE DOWN
	SW SANITARY OR WASTE PIPING ABOVE SLAB
	SW SANITARY OR WASTE PIPING BELOW SLAB
	V VENT PIPING
	GW GREASE WASTE
	CD CONDENSATE DRAIN
	CW COLD WATER PIPING
	HW TEMPERED (HOT) WATER
	HWR HOT WATER RECIRCULATION
	CWF COLD WATER FILTERED
	CWN COLD WATER NANO FILTERED
	CWS COLD WATER SOFTENED
	HW 140 HOT WATER 140F
	RO REVERSE OSMOSIS WATER
	G GAS PIPING
	RD REFRIGERANT DISCHARGE PIPING
	RS REFRIGERANT SUCTION PIPING
	BV BALL VALVE
	GV GATE VALVE
	CH. V CHECK VALVE
	RV RELIEF VALVE
	HB HOSE BIBB
	SHOCK ABSORBER
	STRAINER
	WCO WALL CLEANOUT
	FCO FLOOR CLEANOUT
	FS FLOOR SINK
	WM WATER METER
	POC CONNECT TO EXISTING

GENERAL NOTES

SCOPE
THE INTENT OF THE PROJECT MANUAL AND THE DRAWINGS IS TO PROVIDE A COMPLETE AND FULLY OPERATIONAL PLUMBING SYSTEM. THE CONTRACTOR SHALL FURNISH ALL LABOR, MATERIAL, AND EQUIPMENT RELATED TO THE INSTALLATION OF THE PLUMBING WORK.

SITE EXAMINATION
THE CONTRACTOR SHALL THOROUGHLY EXAMINE ALL AREAS WHERE FIXTURES, EQUIPMENT, AND PIPING WILL BE INSTALLED AND WILL REPORT ANY CONDITION THAT PREVENTS THE PROPER INSTALLATION OF THE PLUMBING WORK.

STANDARDS
EQUIPMENT AND MATERIALS SHALL CONFORM WITH THE APPROPRIATE PROVISIONS OF LISTING STANDARD IN EFFECT AS APPLICABLE TO EACH INDIVIDUAL UNIT OR ASSEMBLY.

CODES
ALL WORK SHALL BE PERFORMED IN STRICT ACCORDANCE WITH ALL APPLICABLE PROVINCIAL AND LOCAL CODES AND ORDINANCES. IN CASE OF CONFLICT BETWEEN THE DRAWINGS AND SPECIFICATIONS AND THE CODES AND ORDINANCES, THE HIGHEST STANDARD SHALL APPLY. THE CONTRACTOR SHALL SATISFY CODE REQUIREMENTS AS A MINIMUM STANDARD WITHOUT ANY EXTRA COST TO STARBUCKS.

APPLICABLE BUILDING CODES:
FLORIDA BUILDING CODE, 8TH EDITION (2023)
FLORIDA BUILDING CODE PLUMBING, 8TH EDITION (2023)
FLORIDA FIRE PREVENTION CODE, 8TH EDITION (2023)

PERMITS AND FEES
THE CONTRACTOR SHALL PROCURE AND PAY FOR ALL PERMITS, FEES, AND INSPECTIONS NECESSARY TO COMPLETE THE PLUMBING WORK.

WARRANTY
THE CONTRACTOR SHALL UNCONDITIONALLY WARRANT ALL WORK TO BE FREE OF DEFECTS IN MATERIAL AND WORKMANSHIP FOR A PERIOD OF ONE (1) YEAR FROM THE DATE OF FINAL ACCEPTANCE BY STARBUCKS AND WILL REPAIR OR REPLACE ANY DEFECTIVE WORK PROMPTLY AND WITHOUT CHARGE AND RESTORE ANY OTHER EXISTING WORK DAMAGED IN THE COURSE OF REPAIRING DEFECTIVE MATERIALS AND WORKMANSHIP.

PLUMBING SCOPE OF WORK

THE PLUMBING CONTRACTOR SHALL FIELD VERIFY ALL EXISTING SANITARY, VENTING, AND DOMESTIC WATER LINES PRIOR TO COMMENCING WORK. NOTIFY ENGINEER OF RECORD IF EXISTING CONDITIONS DO NOT SUPPORT THE DESIGN INTENT.

THE PLUMBING SCOPE OF WORK INCLUDES BUT NOT LIMITED TO:

- REMOVAL & DISPOSAL OF EXISTING KITCHEN EQUIPMENT AND ASSOCIATED DOMESTIC, GREASE & VENT PIPING.
- INSTALLATION OF NEW KITCHEN EQUIPMENT & ASSOCIATED VENT, GREASE & DOMESTIC PIPING.
- WATER HEATER & GREASE INTERCEPTOR ARE EXISTING TO REMAIN

SYSTEM COMMISSIONING

CONTRACTOR RESPONSIBILITIES FOR BUILDING COMMISSIONING

CONTRACTOR SHALL PROVIDE SUPPORT AND WORK AS SPECIFIED, NEEDED AND REQUIRED TO CONDUCT AND FACILITATE STARBUCKS STAFF BUILDING COMMISSIONING EFFORTS. THIS WORK WILL BE COMPRISED OF THREE DISTINCT EFFORTS:

- SUPPORT STARBUCKS COMMISSIONING AGENT (CXA) DURING INSTALLATION VERIFICATION AND CORRECT DISCLOSED DEFICIENCIES.
- PERFORM TESTING, ADJUSTING, BALANCING AND SYSTEM STARTUP AND SUPPORT FUNCTIONAL PERFORMANCE TESTING BY STARBUCKS CXA.
- CORRECT DEFICIENCIES DISCLOSED BY FUNCTIONAL PERFORMANCE TESTING AND SUBMIT REPORTS. CONTRACTOR SHALL PERFORM AND PROVIDE THE FOLLOWING:

- SYSTEMS SUBJECT TO COMMISSIONING MAY INCLUDE, BUT ARE NOT LIMITED TO, DOMESTIC HOT WATER GENERATION.
- CONTRACTOR SHALL INCLUDE COMMISSIONING ACTIVITIES IN PROJECT SCHEDULE AND SHOW INTERVALS FOR PERFORMANCE OF WORK FOR WHICH CONTRACTOR IS RESPONSIBLE AND INTERVALS FOR WORK PERFORMED BY STARBUCKS CXA. CONTRACTOR SHALL SHOW RESOURCES FOR PERFORMING ALL WORK RELATED TO COMMISSIONING ACTIVITIES ON A LINE ITEM IN THE SCHEDULE OF VALUES.
- CONTRACTOR SHALL INSTALL EQUIPMENT IN ACCORDANCE WITH THE MANUFACTURER'S REQUIREMENTS AND ALL CONTRACT DOCUMENTS. ENSURE THAT ALL EQUIPMENT IS INSTALLED TOTALLY COMPLETE, AND ACCESSIBLE TO STARBUCKS CXA FOR INSTALLATION VERIFICATION AND FUNCTIONAL PERFORMANCE TESTING PRIOR TO THE SCHEDULED START OF INSTALLATION VERIFICATION.
- INSTALLATION VERIFICATION SHALL BE PERFORMED BY STARBUCKS CXA. CONTRACTOR SHALL SUPPORT STARBUCKS CXA INSTALLATION VERIFICATION EFFORTS AS NECESSARY. PROVIDE ALL ACCESS AND EQUIPMENT NECESSARY FOR STARBUCKS STAFF TO VERIFY THAT THE EQUIPMENT IS INSTALLED CORRECTLY.
- CONTRACTOR SHALL BE READILY AVAILABLE DURING INSTALLATION VERIFICATION TO CORRECT ANY DEFICIENCIES OR DEFECTS DISCLOSED BY THE INSTALLATION VERIFICATION PROCESS. CORRECTIONS SHALL BE MADE IN A TIMELY MANNER WITHOUT DISRUPTION OF THE CONSTRUCTION SCHEDULE.
- ALL DOMESTIC WATER HEATING, RECIRCULATING, FILTER AND SOFTENING EQUIPMENT SHALL BE TESTED AND/OR ADJUSTED AND BALANCED BY THE CONTRACTOR'S TESTING, ADJUSTING AND BALANCE AGENT. TESTING ADJUSTING AND BALANCING) OR THE MANUFACTURER'S CERTIFIED STARTUP REPRESENTATIVE AFTER THE SYSTEM IS VERIFIED TO BE COMPLETE AND CORRECT BY STARBUCKS CXA IN ACCORDANCE WITH THE REQUIREMENTS OF THESE DOCUMENTS. SEQUENCES OF OPERATION SHALL BE TESTED TO ENSURE THAT THEY OPERATE IN ACCORDANCE WITH THE CONTRACT REQUIREMENTS. DELIVERABLES: PRELIMINARY, WRITTEN FUNCTIONAL PERFORMANCE REPORT CONFORMING TO THE REQUIREMENTS SPECIFIED HEREIN, DOCUMENTING THE INFORMATION SPECIFIED, ETC. TO THE STARBUCKS CXA IMMEDIATELY UPON COMPLETION OF THE WORK.

- CONTRACTOR SHALL INFORM STARBUCKS CXA WHEN EQUIPMENT IS READY FOR FUNCTIONAL PERFORMANCE TESTING. ALL EQUIPMENT SHALL BE READY FOR FUNCTIONAL PERFORMANCE TESTING PRIOR TO STARTING TESTING. CONTRACTOR SHALL OPERATE EQUIPMENT FOR STARBUCKS CXA AND VERIFY BY DEMONSTRATION THE CORRECT OPERATION OF EQUIPMENT, RESPONSE OF SENSORS, AND PROPER EXECUTION OF HVAC CONTROL AND LIGHTING SEQUENCES, INCLUDING BUT NOT LIMITED TO: AIR MOVEMENT, TEMPERATURE, SOUND, AND CONTROL. PROVIDE ANY SECURITY ACCESS, HARDWARE, SOFTWARE, OR OTHER SUPPORT AS NEEDED FOR THE STARBUCKS CXA TO EFFICIENTLY WITNESS AND DOCUMENT ALL EQUIPMENT TESTING. STARBUCKS CXA WILL RECORD THE EQUIPMENT OPERATION AND RESPONSE TO TESTING SEQUENCES AND PREPARE A LIST OF ANY DEFICIENCIES DISCLOSED BY THE FUNCTIONAL PERFORMANCE TESTS FOR CORRECTION BY THE CONTRACTOR. EQUIPMENT INCLUDES, BUT IS NOT LIMITED TO: AIR HANDLING UNITS, ROOFTOP AND SPLIT TYPE, CONDENSING UNITS, EXHAUST FANS, LIGHTING CONTROLS, ETC. DELIVERABLES: PROVIDE COMPLETED COPIES OF ALL START UP REPORTS, FILLED OUT BY THE MANUFACTURER'S FORMS, TO THE STARBUCKS CXA.
- CONTRACTOR IS RESPONSIBLE FOR CORRECTING ANY ISSUES OR DEFICIENCIES DISCLOSED DURING THE FUNCTIONAL PERFORMANCE TESTING PROCESS. CORRECTIONS SHOULD BE MADE IN A TIMELY MANNER WITHOUT DISRUPTION TO THE SYSTEM AND CONSTRUCTION SCHEDULE.

- CONTRACTOR SHALL BE READILY AVAILABLE FOR ANY RE-TESTING OF EQUIPMENT DEEMED NECESSARY BY STARBUCKS CXA DURING INSTALLATION VERIFICATION AND FUNCTIONAL PERFORMANCE TESTING. CONTRACTOR IS RESPONSIBLE FOR CORRECTING ANY ISSUES OR DEFICIENCIES FOUND IN THE SYSTEM DURING ANY AND ALL RE-TESTING. CORRECTIONS SHOULD BE MADE IN A TIMELY MANNER WITHOUT DISRUPTION TO THE SYSTEM AND CONSTRUCTION SCHEDULE. DELIVERABLES: FINAL BALANCE REPORT, DEFICIENCIES LIST NOTING CORRECTIVE ACTIONS PERFORMED BY CONTRACTOR IN RESPONSE TO INSTALLATION VERIFICATION AND FUNCTIONAL PERFORMANCE TEST RESULTS.

- CONSTRUCTION AND POST CONSTRUCTION TESTING: ADDITIONAL TESTING MAY BE REQUIRED BY LEED AND OTHER PROCESSES THAT MAY OCCUR OUT OF SEQUENCE WITH COMMISSIONING SERVICE. CONTRACTOR SHALL CONDUCT, DOCUMENT, SUPPORT AND SCHEDULE THIS TESTING AS DIRECTED BY STARBUCKS CXA.

VALVES

GENERAL

INSTALL VALVES FOR EACH FIXTURE AND ITEM OF EQUIPMENT. PROVIDE BRAIDED STAINLESS STEEL HOSE (UNLESS OTHERWISE NOTED) BETWEEN VALVE AND EQUIPMENT IN ACCORDANCE WITH MANUFACTURER'S SPECIFICATIONS. LOCATE SHUT-OFF VALVES ADJACENT TO EQUIPMENT FOR EASY ACCESS SUCH THAT VALVES CAN BE REACHED WITHOUT MOVING EQUIPMENT. SHUT OFF VALVES TO BE BALL TYPE. VALVES SHALL BE LISTED/ APPROVED FOR USE PER AUTHORITIES HAVING JURISDICTION (AHJ) AND CODE REQUIREMENTS. PROVIDE VALVE IDENTIFICATION PER THE PROJECT MANUAL FOR MAIN WATER SERVICE SHUT-OFF AND ANY OTHER VALVES WHICH ARE NOT CLEARLY EVIDENT WHAT THEY SERVE.

PLUMBING FIXTURES

WATER HEATER

SIZE WATER HEATER PER STARBUCKS STANDARD AND PER AUTHORITIES HAVING JURISDICTION (AHJ), WHICHEVER IS MORE STRINGENT. PROVIDE INSTALLATION COMPLETE WITH FITTINGS AS SHOWN IN THE DRAWINGS. SET HOT WATER TEMPERATURE AT 140° F OR ADJUST AS REQUIRED BY AHJ. PROVIDE THERMOMETER ON HOT WATER PIPE LEAVING WATER HEATER.

WATER FILTRATION

STARBUCKS WATER FILTRATION VENDOR WILL PROVIDE FILTRATION SYSTEM. CONTRACTOR SHALL CONFIRM WITH STARBUCKS CONSTRUCTION MANAGER WHETHER VENDOR OR PLUMBING CONTRACTOR IS TO INSTALL FILTRATION SYSTEM, PROVIDE AND COORDINATE INSTALLATION COMPLETE WITH ALL PIPING, FITTINGS, AND EQUIPMENT AS INDICATED ON THE DRAWINGS.

CONNECTIONS

THE PLUMBING CONTRACTOR SHALL MAKE ALL FINAL CONNECTIONS TO EQUIPMENT INCLUDING REQUIRED MATERIAL SUCH AS PIPING, VALVES, FILTERS, TRAPS, CHECKS VALVES, VACUUM BREAKERS, AND FLEXIBLE AND RIGID TUBING.

SCHEDULES

REFER TO SCHEDULES ON DRAWINGS FOR A DESCRIPTION OF LISTED ITEMS AND FURNISH ANY AND ALL PLUMBING FIXTURES LISTED AS "GC". ANY DISCREPANCIES ABOUT WHO IS TO PROVIDE PLUMBING FIXTURES IN THE SCHEDULE SHALL BE BROUGHT TO STARBUCKS ATTENTION FOR CLARIFICATION. INSTALL ALL FIXTURES LISTED REGARDLESS OF WHO SUPPLIES.

DISHWASHER

G.C. TO FURNISH AND INSTALL POWER CORD FOR DISHWASHER PER JURISDICTIONAL REQUIREMENTS. IF EQUIPMENT IS SPECIFIED AS HOBART ADVANSYS, THE UNIT IS TO BE PLUMBED WITH COLD, NON-FILTERED WATER. IF THE WATER FILTRATION SYSTEM IS A PENTAIR CONFIGURATION II OR III, THEN THE COLD, NON-FILTERED WATER MUST ALSO BE SOFTENED.

PIPING

CONDENSATE DRAINAGE PIPING

THE PLUMBING CONTRACTOR SHALL PROVIDE CONDENSATE DRAINS FOR AIR HANDLING UNITS AND STARBUCKS EQUIPMENT (REFER TO SCHEDULE). CONDENSATE DRAINAGE PIPING SHALL BE TYPE "M" COPPER TUBING WITH WROUGHT COPPER SWEAT FITTINGS JOINED WITH 50/50 SOLDER.

TESTING

ALL PIPES SHALL BE TESTED BY AN APPROVED METHOD BEFORE THEY ARE BACKFILLED OR CONCEALED. AFTER TESTING IS COMPLETE, THE PLUMBING BY LOCAL AUTHORITY. TEST WATER PURITY ACCORDING TO LOCAL CONTRACTOR SHALL DISINFECT THE POTABLE WATER SYSTEM AS REQUIRED REQUIREMENTS AND SUBMIT CERTIFIED TEST RESULTS TO LOCAL REQUIREMENTS AND SUBMIT CERTIFIED TEST RESULTS TO ENGINEER FOR REVIEW AND APPROVAL.

VENT, SANITARY & GREASE PIPING

UNLESS OTHERWISE INDICATED ON THE PLAN, THE SANITARY AND GREASE PIPING SHALL BE CAST IRON ABOVE SLAB AND PVC BELOW SLAB AND FOR VENT PIPE ABOVE A TRAP. PVC MAY NOT BE USED THROUGH RATED ASSEMBLIES OR IN RETURN AIR PLENUMS. WASTE PIPING FOR WATER DISCHARGED FROM DISHWASHER OR ANY APPLIANCE HANDLING WASTE WATER OVER 140° SHALL HAVE A DRAIN TEMPERING VALVE TO PRIOR TO ITS DISCHARGE ONTO THE MAIN BUILDING WASTE LINE.

DOMESTIC WATER PIPING

WATER DISTRIBUTION PIPING SHALL BE THE TYPE EITHER "L" COPPER OR SDR 11 RATED CPVC PIPING.

GENERAL PIPING

DIELECTRIC COUPLINGS ARE REQUIRED BETWEEN ALL DISSIMILAR METAL IN PIPING AND EQUIPMENT CONNECTIONS.

ISOLATE COPPER PIPE FROM HANGER OR SUPPORTS WITH ISOLATOR PAD.

ALL FIRE RATED FLOOR AND WALL PENETRATIONS SHALL BE PROPERLY PROTECTED FROM FIRE, SMOKE AND WATER PENETRATION BY FILLING VOIDS BETWEEN PIPE AND WALL/FLOOR SLEEVES WITH FIRE RATED FOAM, TO ACHIEVE THE SAME RATING AS WALLS OR FLOORS AS PART OF THE PLUMBER'S WORK.

PROVIDE ACCESS PANELS FOR ALL CONCEALED VALVES AND ALL WATER HAMMER ARRESTERS. ACCESS PANELS IN RATED WALLS MUST MAINTAIN THE SAME RATING AND MUST MATCH THE FINISH OF THE WALL IN WHICH IT IS INSTALLED. ALL VALVES AND WATER HAMMER ARRESTER TO BE LOCATED NO MORE THAN 24" ABOVE THE ACCESS PANEL.

ALL CONTROL VALVES SHALL BE TAGGED AND MARKED. A REPRODUCIBLE DIAGRAM LOCATING ALL VALVES SHALL BE PROVIDED FOR OWNER/OPERATOR.

ALL PVC PIPE SHALL BE SOLID CORE, NO CELLULAR CORE.

NITROGENATION

STARBUCKS NITROGENATION VENDOR WILL PROVIDE AND INSTALL EQUIPMENT AND FITTINGS IF APPLICABLE TO PROJECT SCOPE FOR NITRO STATION. GENERAL CONTRACTOR SHALL COORDINATE NITRO SYSTEM INSTALLATION WITH STARBUCKS VENDOR.

INSULATION

WATER PIPING

PROVIDE THERMAL INSULATION PER THE SPECIFICATIONS.

FOR PIPES SMALLER THAN 1-1/2"Ø, HOT WATER AND HOT WATER RECIRCULATION PIPING INSULATION SHALL BE 1" THICK ARMAFLEX. PIPES 1-1/2"Ø AND LARGER, USE 1-1/2" THICK ARMAFLEX INSULATION. INSULATION IS TO BE INSTALLED IN ACCORDANCE WITH MANUFACTURER'S INSTRUCTIONS. WHERE DOMESTIC WATER TEMPERATURES CAN CAUSE SWEATING ALL COLD WATER PIPING SHALL BE INSULATED WITH 1/2" THICK ARMAFLEX INSULATION.

SAFETY COVERS

FURNISH AND INSTALL SPECIFIED NO SCALD SAFETY COVERS WITH INSULATED FOAM LINER AND TAMPER PROOF STRAP AT ALL EXPOSED ADA SINK P-TRAPS AND WATER SUPPLIES AND AS REQUIRED BY JURISDICTION .

GENERAL PLUMBING NOTES

- PLUMBING CONTRACTOR SHALL COORDINATE WITH THE GENERAL CONTRACTOR TO PATCH AND REPAIR ALL EXISTING WALLS, FLOORS, CEILINGS OR OTHER SURFACES IDENTIFIED TO REMAIN THAT MAY BECOME DAMAGED DURING THE COURSE OF WORK.
- ALL WORKMANSHIP AND MATERIALS SHALL BE IN STRICT ACCORDANCE WITH APPLICABLE CODES AS SHOWN.
- UNLESS OTHERWISE SPECIFIED, ALL MATERIALS SHALL BE NOW. ALL WORK SHALL BE PERFORMED BY A LICENSED PLUMBING CONTRACTOR IN A FIRST CLASS WORKMANLIKE MANNER. THE COMPLETED SYSTEM SHALL BE FULLY OPERATIVE. ALL EXCAVATION AND BACK FILL AS REQUIRED FOR THIS PHASE OF CONSTRUCTION SHALL BE A PART OF THIS CONTRACT.
- REQUIRED INSURANCE SHALL BE PROVIDED BY THE PLUMBING CONTRACTOR FOR PROTECTION AGAINST PUBLIC LIABILITY AND PROPERTY DAMAGE FOR THE DURATION OF THE WORK.
- PLUMBING CONTRACTOR TO OBTAIN PERMIT AND APPROVED SUBMITTALS PRIOR TO BEGINNING WORK OR ORDERING EQUIPMENT. PLUMBING CONTRACTOR MUST BE PRESENT FOR ALL INSPECTIONS OF HIS WORK BY REGULATORY AUTHORITIES.
- CONTRACTOR SHALL SUBMIT FOR APPROVAL ELECTRONIC PDF COPIES OF MANUFACTURER DRAWINGS FOR ALL PLUMBING FIXTURES AND EQUIPMENT INCLUDED IN CONTRACT. ALL MATERIAL SHALL BE NEW FROM A U.S. MANUFACTURER OF GOOD QUALITY. ALL WORK SHALL BE PERFORMED IN A WORKMAN LIKE MANNER BY SKILLED TRADESMEN.
- ENGINEER OF RECORD RECOGNIZES THE GENERAL CONTRACTOR AND ALL OTHER CONTRACTORS TO BE LICENSED IN THE STATE OF FLORIDA. GENERAL CONTRACTOR SHALL CONSIDER THE PROJECT AS ONE SET OF DOCUMENTS. GENERAL CONTRACTOR SHALL PROVIDE AN ENTIRE SET OF DOCUMENTS SHOWING ALL TRADES TO EACH SUBCONTRACTOR PRIOR TO BIDDING AND CONSTRUCTION.
- EXPOSED/SURFACE MOUNTED PIPING IS ONLY ALLOWED IN THE BAR AREA UNDER COUNTERTOPS, WHERE IT DOES NOT OBSTRUCT CABINETS/DEVICES AND WHERE APPROVED BY STARBUCKS CONSTRUCTION MANAGER. IF ROUTED THROUGH CABINETS, IT SHALL BE ROUTED TO MAXIMIZE STORAGE SPACE AND BE PROTECTED FROM DAMAGE.
- DRAWINGS ARE DIAGRAMMATIC AND INDICATE GENERAL INTENT OR ARRANGEMENT OF SYSTEM(S). FURNISH AND INSTALL ALL COMPONENTS NEEDED WHETHER INDICATED OR NOT TO PROVIDE A COMPLETE AND OPERATING SYSTEM. OVERALL CASEWORK COMPONENT DIMENSIONING ON PLUMBING DETAILS ARE SHOWN FOR REFERENCE AND COORDINATION ONLY.
- CONTRACTOR TO VERIFY ALL DIMENSIONS, INCLUDING CLEARANCES REQUIRED BY OTHER TRADES, AND NOTIFY STARBUCKS CONSTRUCTION MANAGER OF ANY DISCREPANCIES PRIOR TO PROCEEDING WITH THE WORK. ALL DIMENSIONS ARE TO THE FACE OF THE FINISHED SURFACE UNLESS NOTED OTHERWISE. ALL DIMENSIONS TO BE TAKEN FROM ACTUAL BUILDING DIMENSIONS.
- THE PLUMBING CONTRACTOR SHALL COORDINATE PLUMBING WORK WITH OTHER TRADES. THE ARCHITECTURAL DRAWINGS AND SPECIFICATIONS SHALL TAKE PRECEDENCE OVER ALL OTHER DRAWINGS. SEE ARCHITECTURAL DRAWINGS FOR FIXTURES IN CASEWORK AND PLUMBING DETAILS. SEE THE PROJECT MANUAL FOR PLUMBING SPECIFICATION SECTIONS.
- ALL PIPING AND/OR PLUMBING DEVICES SHALL BE SUPPORTED FROM STRUCTURE (NOT FROM HVAC DUCTS OR OTHER PIPES/CONDUITS).
- WHEN BUNDLING SEVERAL INDIRECT WASTE LINES TO DRAIN INTO FLOOR SINK, A UNISTRUT IS REQUIRED FOR SECURING AND BRACING ALL LINES ABOVE THE DRAIN.
- FURNISH AND INSTALL ALL NEEDED DRAIN LINES PER CODE (NOT ALL SHOWN). INSTALL DRAINS AT 2% SLOPE WHERE POSSIBLE WITHOUT DIPS OR SAGS. ALL INDIRECT DRAINS SHALL RUN SEPARATELY FROM EACH OTHER TO INDIRECT DRAIN RECEPTOR AND SHALL TERMINATE WITH AN AIR GAP PER CODE.
- FURNISH AND INSTALL WALL CLEANOUTS AT ALL SINKS AND AS NEEDED PER CODE (NOT ALL SHOWN).
- INSULATE ICE BIN DRAINAGE PIPES PER THE REQUIREMENTS IN THE PROJECT MANUAL.
- STUDOR MINIMAXI AIR ADMITTANCE VALVES OR AN APPROVED EQUAL MAY BE USED AS AN ALTERNATE TO VENT PIPING THROUGH ROOF WHERE ACCEPTABLE BY THE PLUMBING OFFICIAL. THE INSTALLATION SHALL BE IN ACCORDANCE WITH SECTION 918 OF THE FLORIDA BUILDING CODE-PLUMBING AND THE MANUFACTURER'S WRITTEN INSTRUCTIONS.
- ALL FLOOR DRAINS NOT OTHERWISE PRIMED WITH INDIRECT WASTE SHALL BE PRIMED FROM THE NEAREST DOMESTIC WATER FIXTURE. REFERENCE FLOOR DRAIN PRIMING DETAIL.
- REVERSE OSMOSIS SYSTEMS (RO SYSTEMS) SHALL BE PIPED WITH CPVC. COPPER MAY BE USED IN LIEU OF CPVC ONLY AFTER CONTRACTOR PROVIDES DETAILED DOCUMENTATION OF MINERAL WATER TREATMENT TO DECREASE AGGRESSIVENESS OF THE WATER.
- PROCURE WATER HEATERS THROUGH STARBUCKS NATIONAL ACCOUNT WITH DISTRIBUTOR NATIONAL HOT WATER. SUBMIT ORDERS BY EMAIL TO: HOTWATERNIGHTCALLS@NATIONALWHOLESALE.BIZ NATIONAL HOT WATER CONTACT FOR ORDERING AND DISTRIBUTION SUPPORT: (888) 444-4435.
- PROCURE WATER CLOSETS, URINALS AND FLUSH VALVES THROUGH STARBUCKS NATIONAL ACCOUNT WITH DISTRIBUTOR FERGUSON. SUBMIT QUOTATION REQUESTS BY EMAIL TO: NA.PROJECTS@FERGUSON.COM FERGUSON CONTACT FOR ORDERING AND DISTRIBUTION SUPPORT: (757) 234-8342.

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PROJECT NAME:
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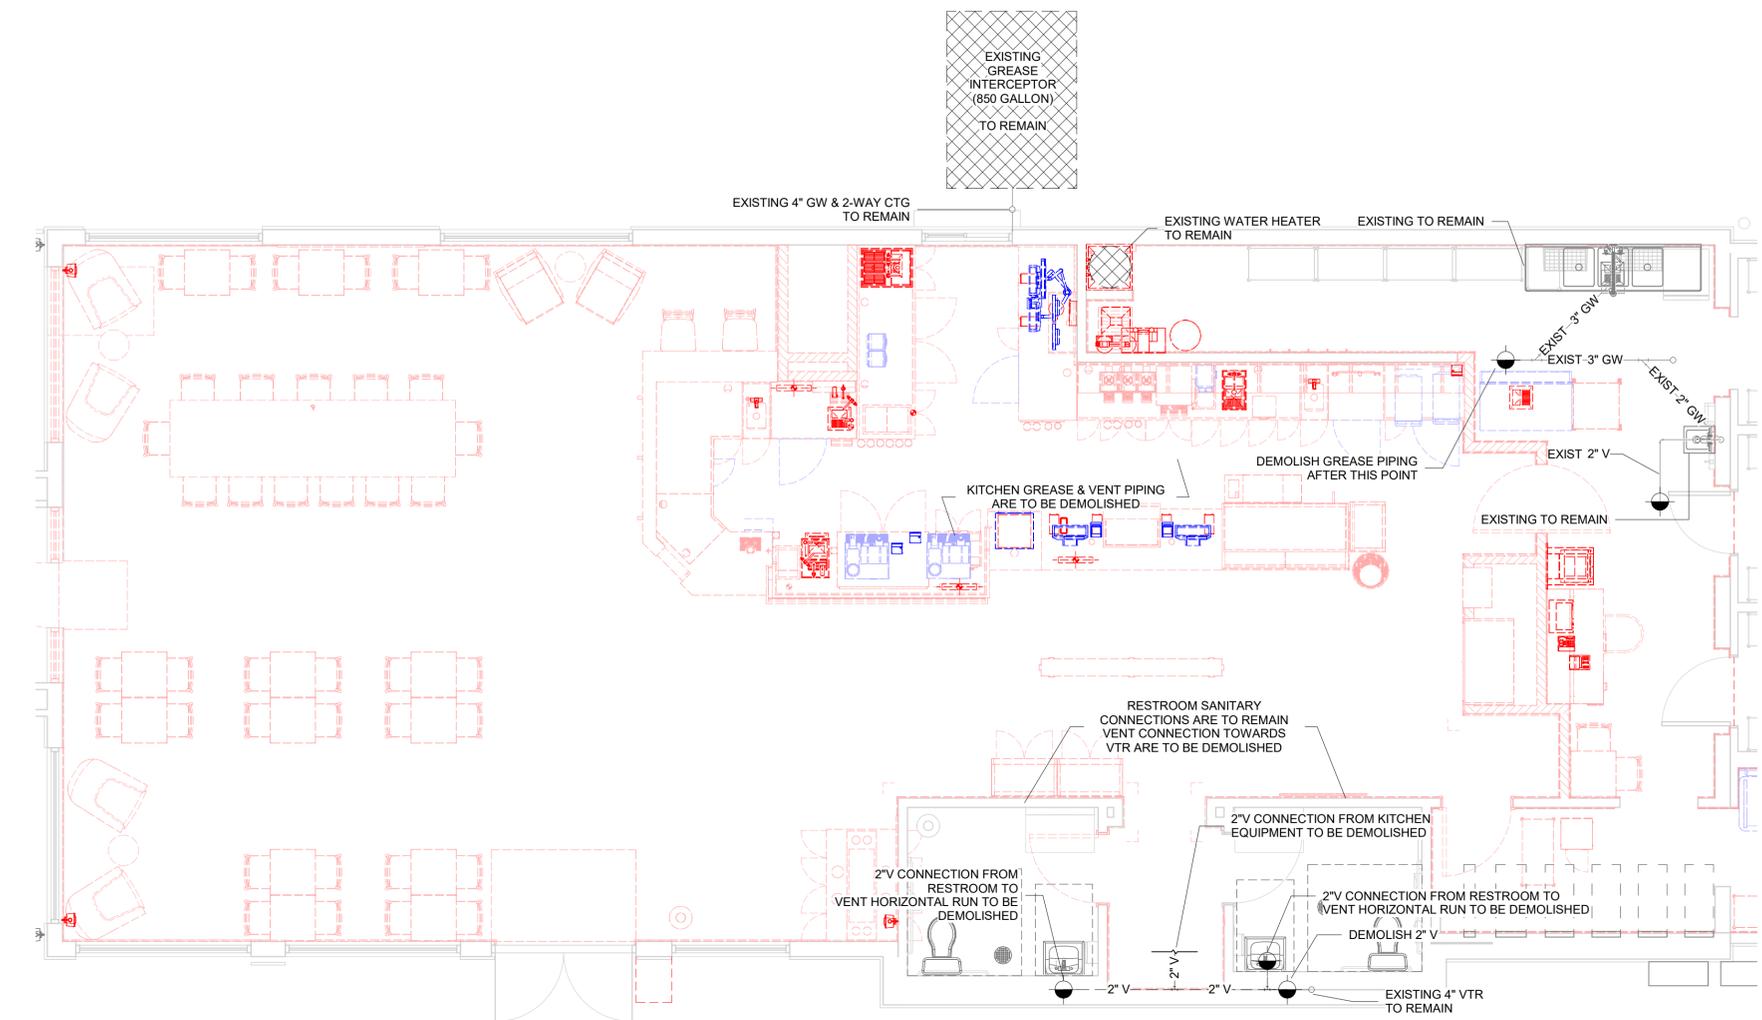
PROJECT ADDRESS:
**975 3RD STREET SOUTH
JACKSONVILLE BEACH, FL 32250**

STORE #: 8565
PROJECT #: 18756-108
ISSUE DATE: 03-27-2024
DESIGN MANAGER: ROMINA VIGNOLO
PRODUCTION DESIGNER: GENSLER
CHECKED BY: GENSLER


Revision Schedule			
Rev	Date	By	Description

SHEET TITLE:
PLUMBING COVER SHEET
SCALE: AS SHOWN

SHEET NUMBER:
P001



1 SANITARY/GREASE DEMOLITION PLAN
1/4" = 1'-0"

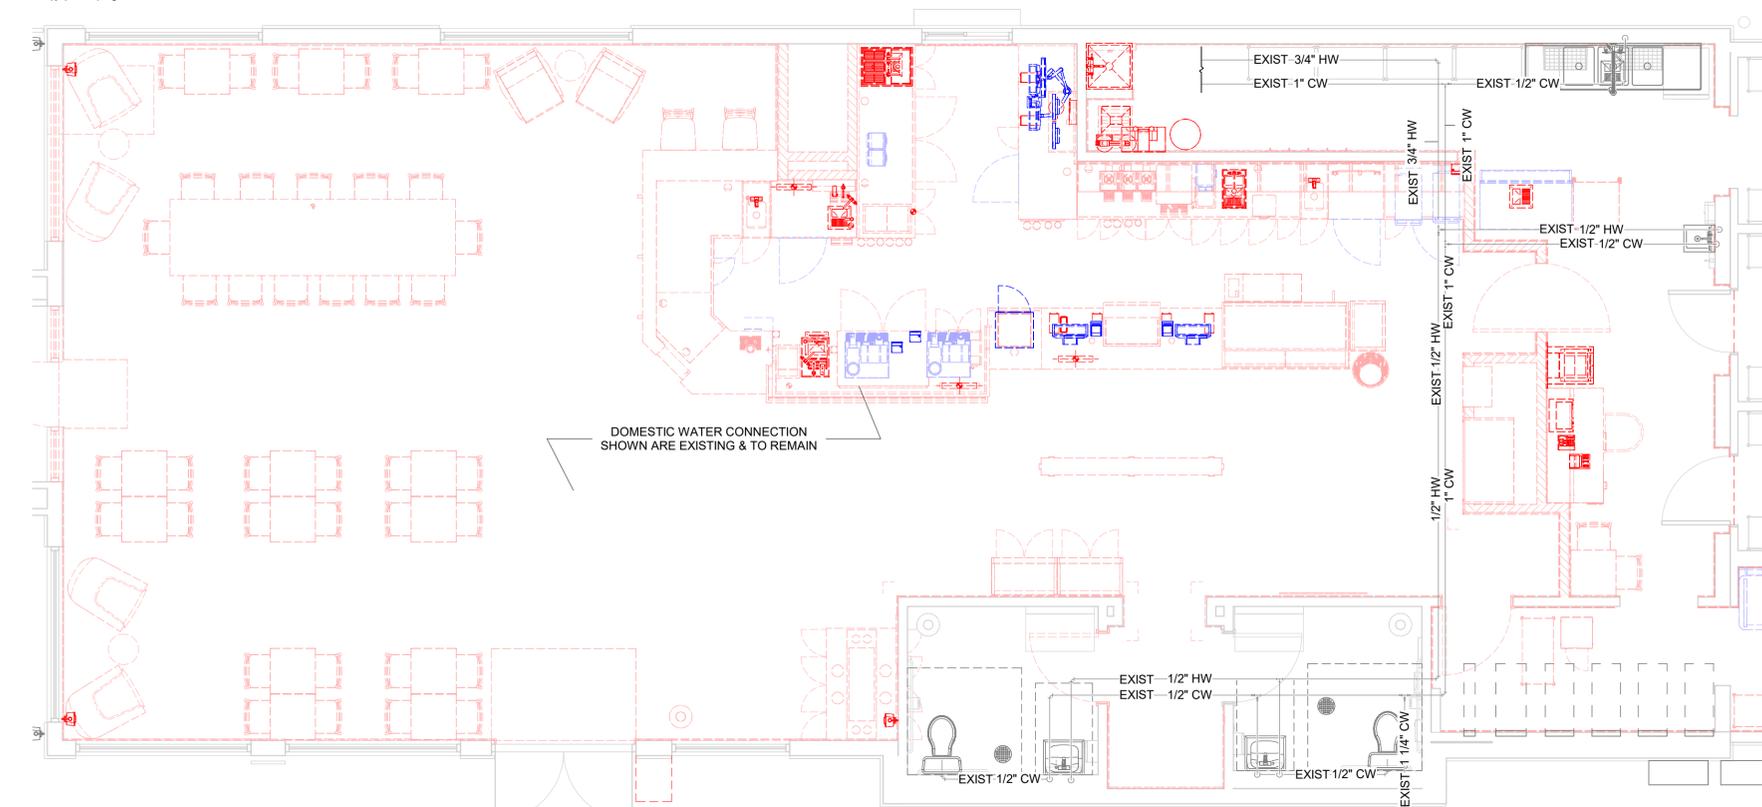

2 DOMESTIC WATER DEMOLITION PLAN
1/4" = 1'-0"

PLUMBING DEMOLITION NOTE

1. DEMOLISH AND DISPOSE OF EXISTING KITCHEN EQUIPMENT, WATER FILTRATION SYSTEM & ASSOCIATED GREASE, VENT, HOT & COLD WATER PIPING.
2. EXISTING WATER HEATER & GREASE INTERCEPTOR (850 GAL) ARE TO REMAIN.
3. EXISTING 3-COMP SINK & HAND SINK ARE TO REMAIN. SEE 1/P101 FOR MORE LOCATION.
4. EXISTING RESTROOM FIXTURES WITH ASSOCIATED SANITARY, VENT, HOT & COLD WATER PIPING ARE TO REMAIN.
5. RESTROOM VENT CONNECTION TO MAIN VENT TO BE DEMOLISHED. REFER TO P201 FOR NEW CONNECTION.
6. PIPING SHOWN TO REMAIN WILL REMAIN FOR NEW PLUMBING INSTALLATION



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Revision Schedule			
Rev	Date	By	Description

SHEET TITLE:
PLUMBING DEMOLITION PLAN
SCALE: AS SHOWN

SHEET NUMBER:
P101

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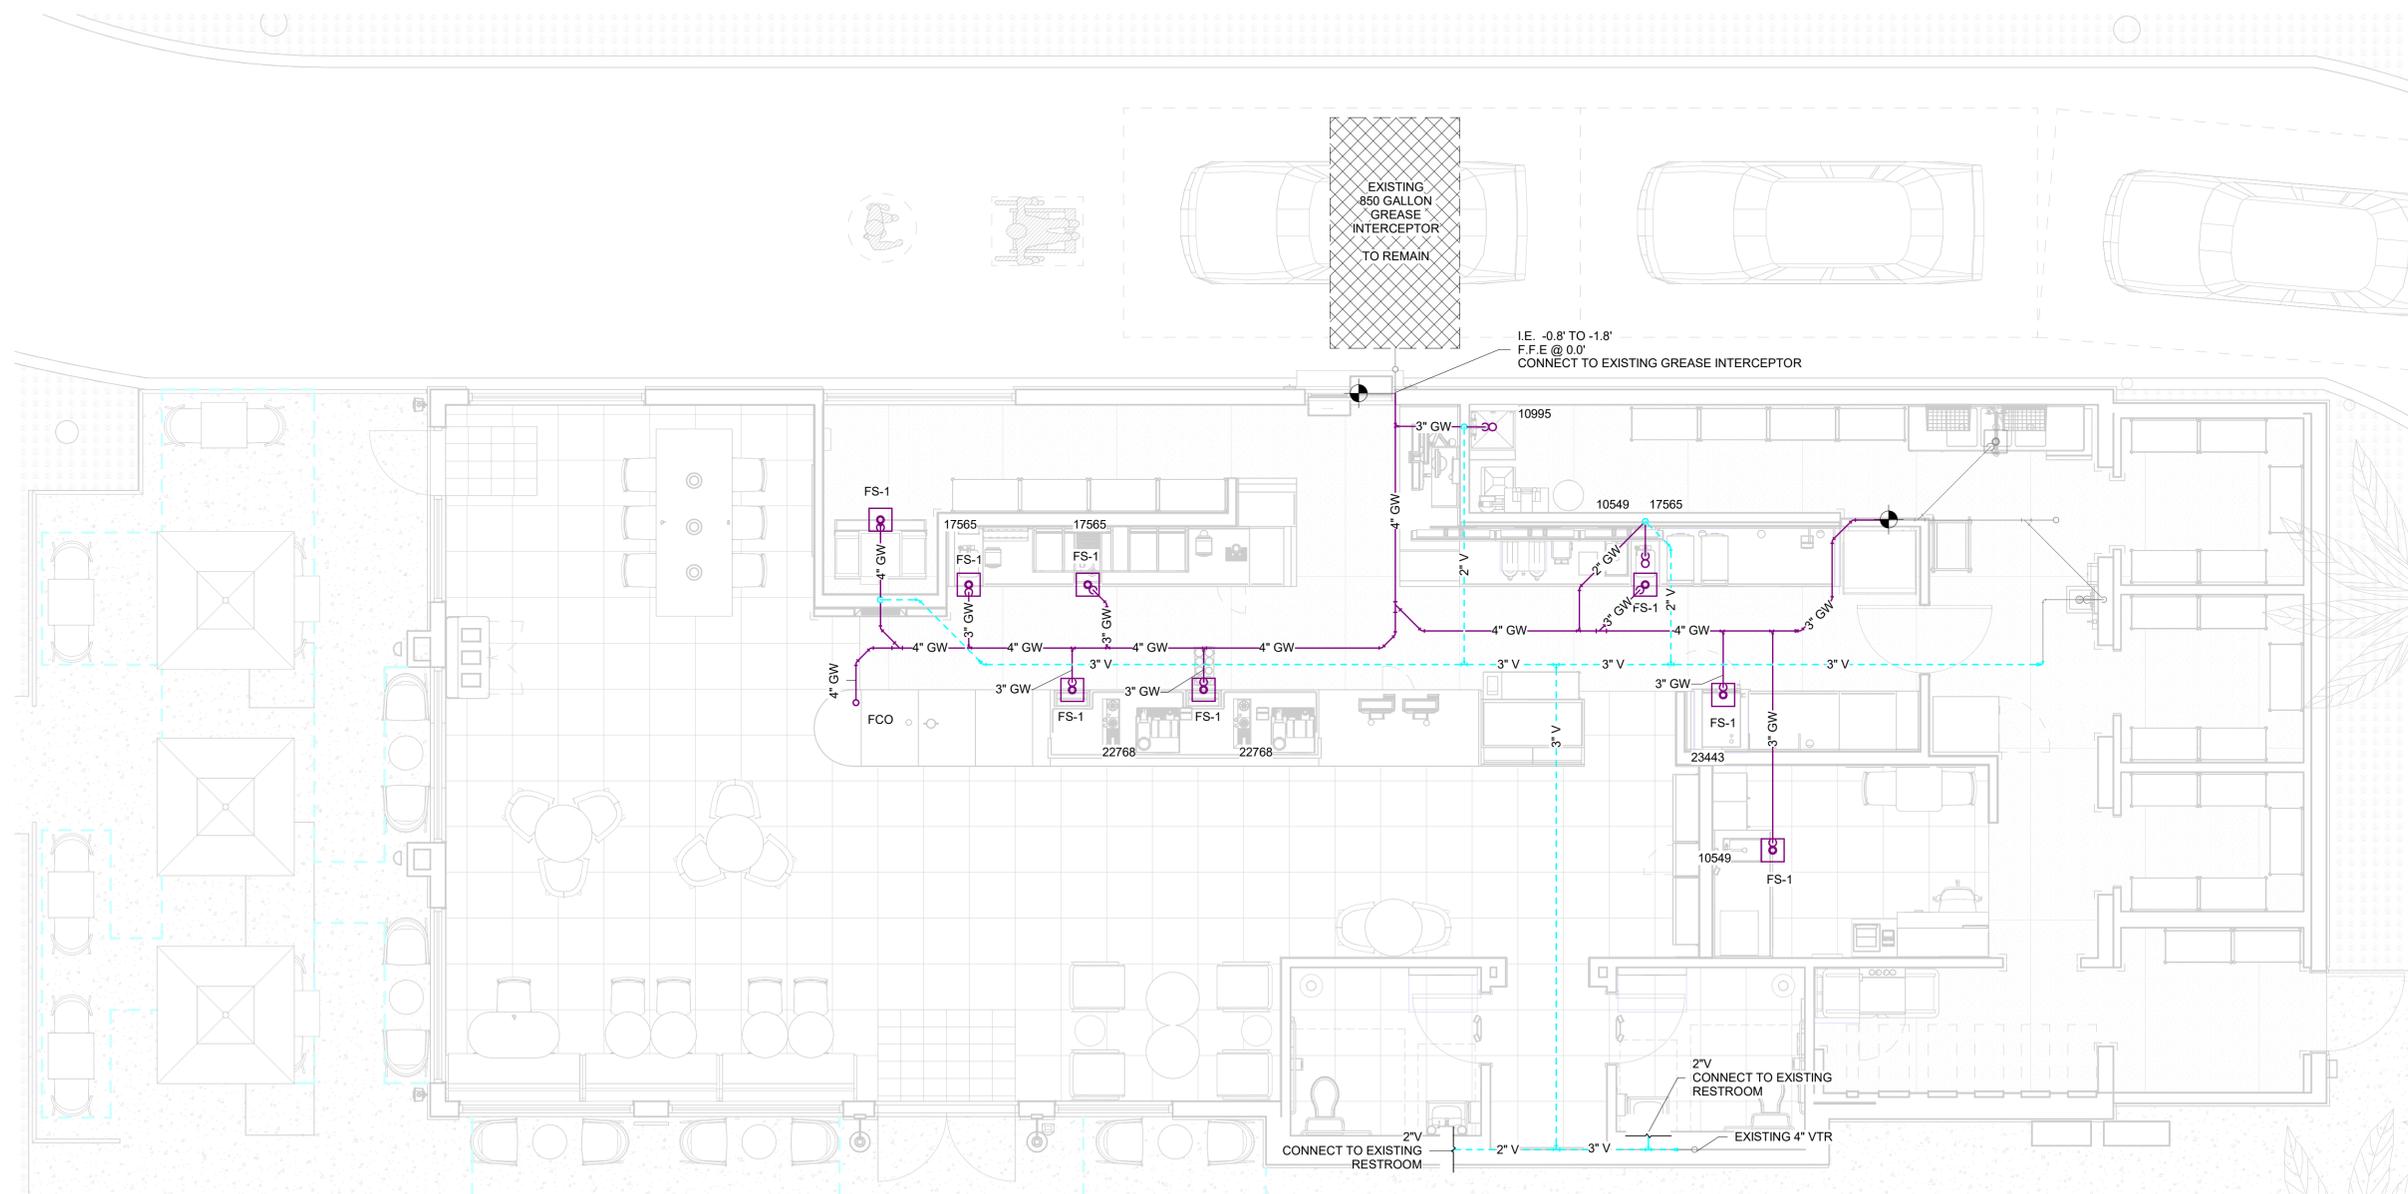
Revision Schedule

Rev	Date	By	Description

SHEET TITLE:
SANITARY AND GREASE FLOOR PLAN
SCALE: AS SHOWN

SHEET NUMBER:
P201

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① SANITARY & GREASE ENLARGED PLAN
1/4" = 1'-0"



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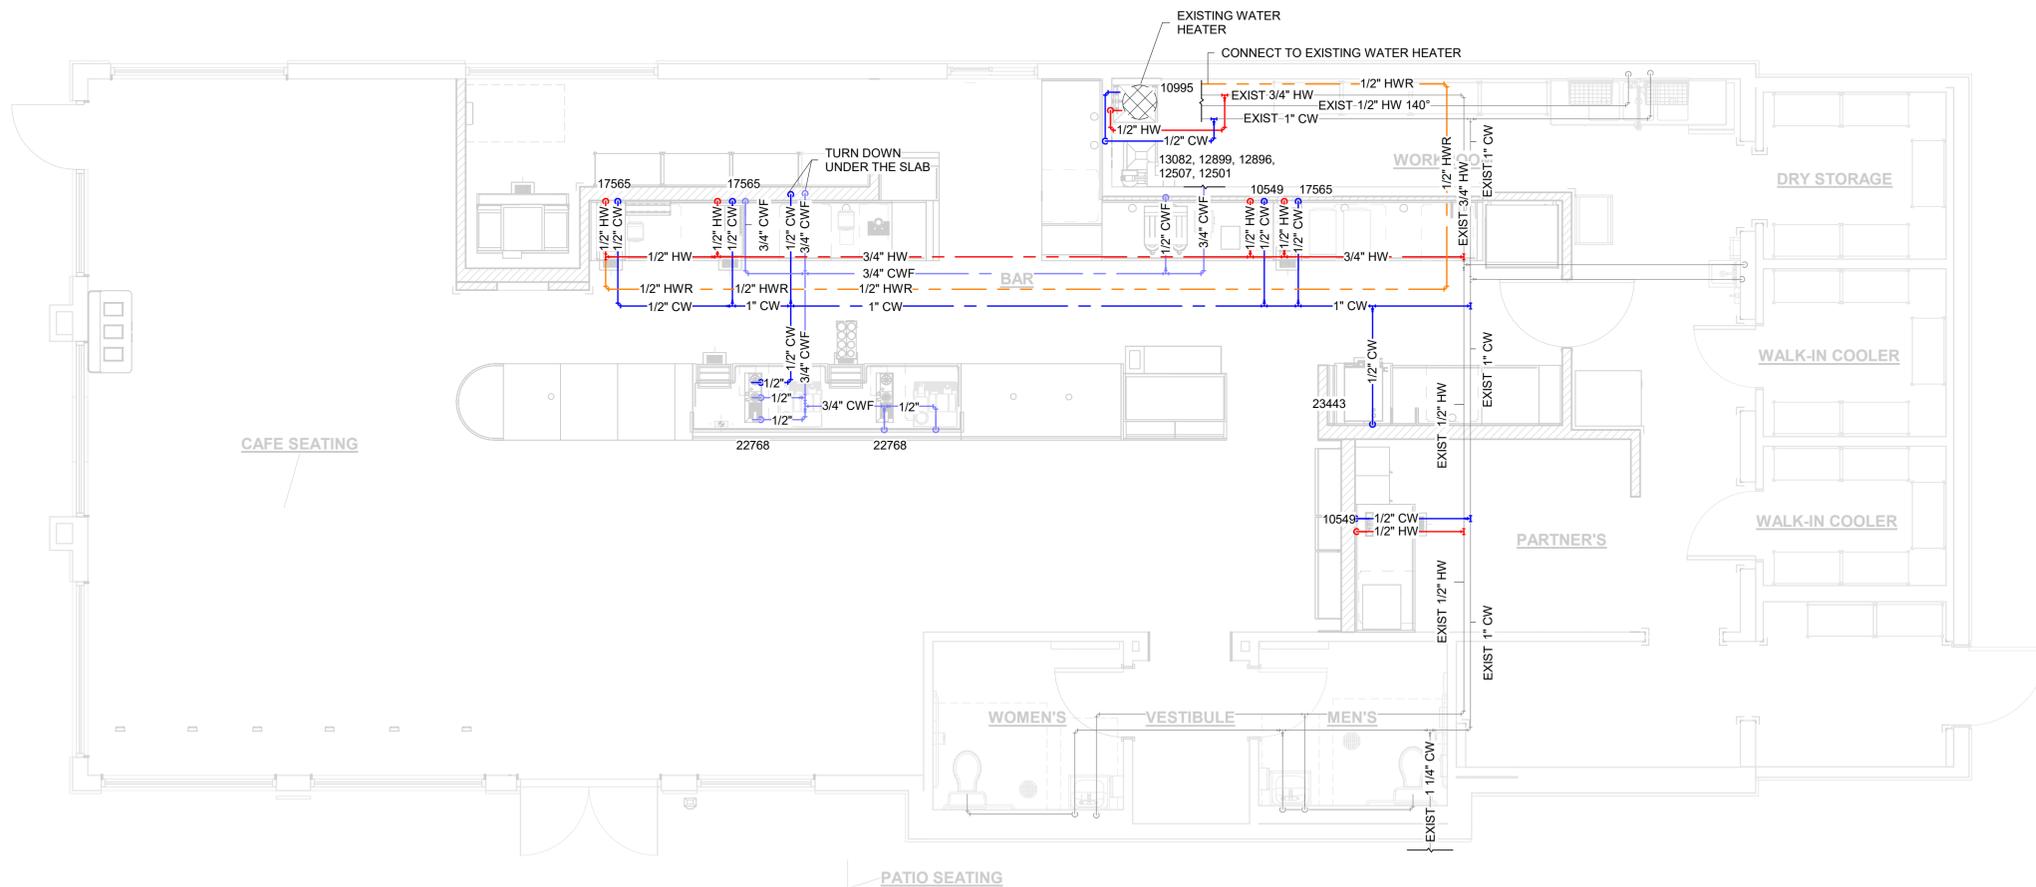
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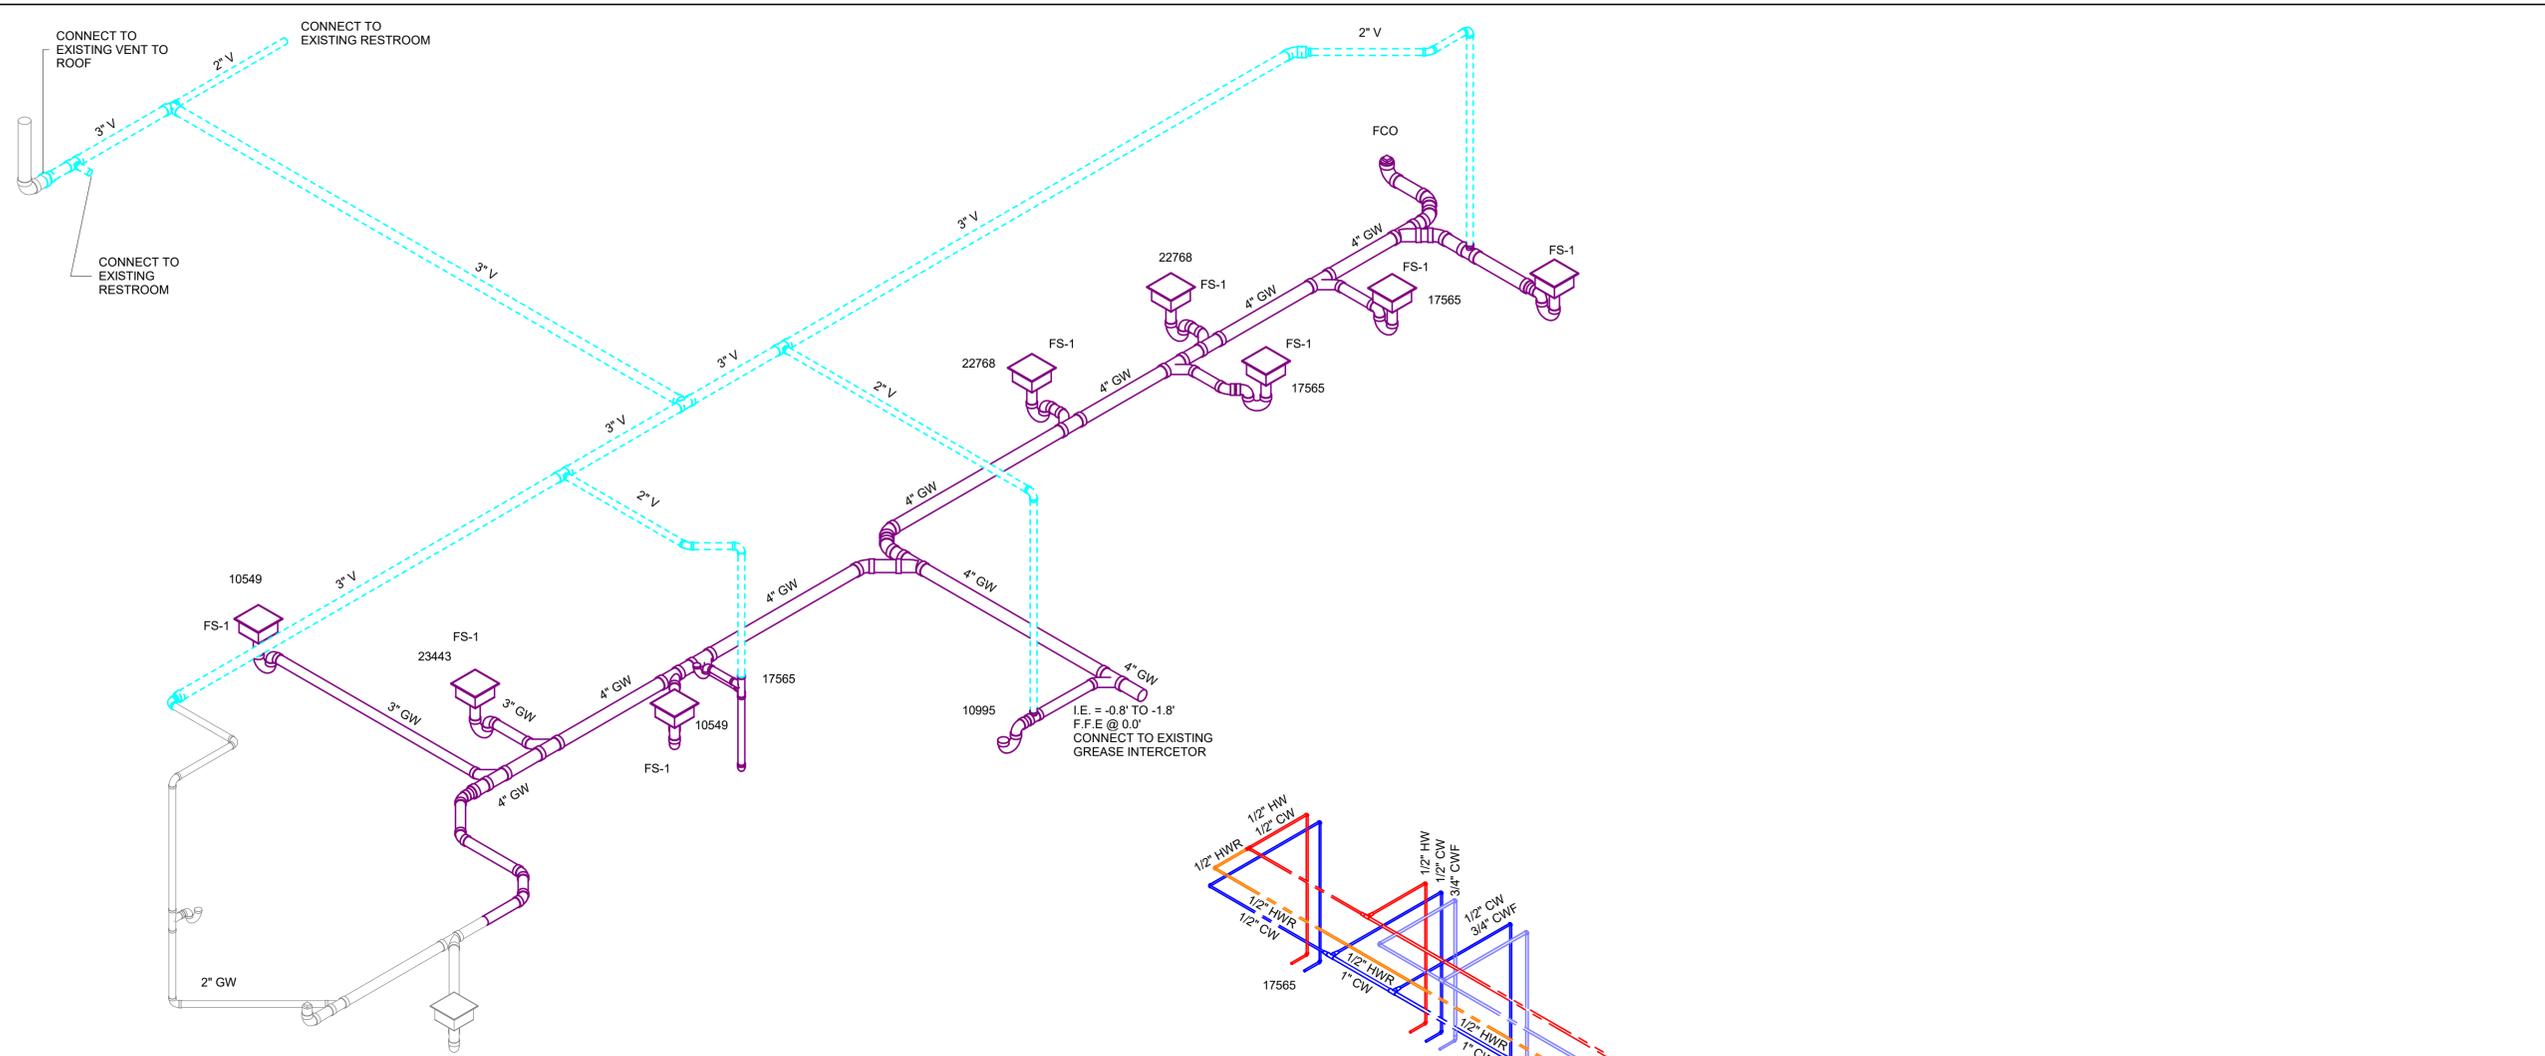
Rev	Date	By	Description

SHEET TITLE:
**DOMESTIC WATER
FLOOR PLAN**
SCALE: AS SHOWN


SHEET NUMBER:
P202



1 DOMESTIC WATER PLAN
1/4" = 1'-0"



1 SANITARY & GREASE ISOMETRIC PLAN

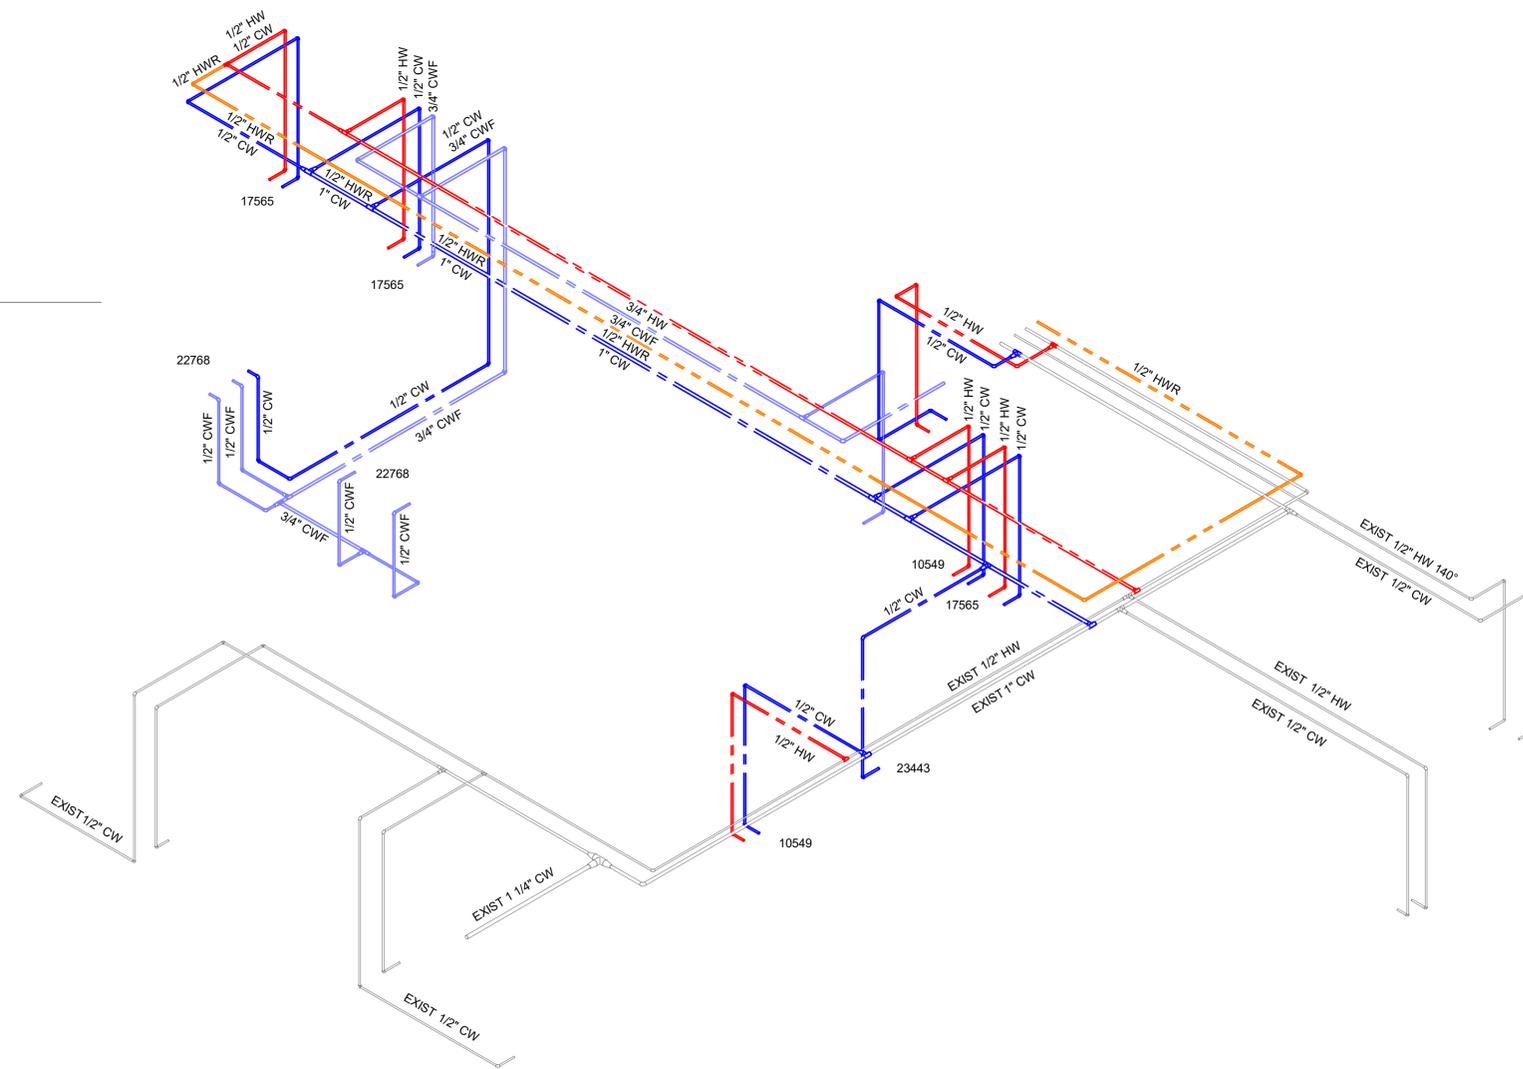


2 DOMESTIC WASTE ISOMETRIC PLAN



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Revision Schedule			
Rev	Date	By	Description

SHEET TITLE:
PLUMBING ISOMETRIC PLANS
 SCALE: AS SHOWN

SHEET NUMBER:
P203

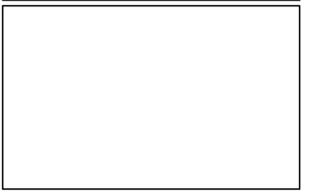GREASE INTERCEPTOR CALCULATIONS

Reference No. 64662 Project Name: A1A & 10th Starbucks

Step 1: Flow rate to grease interceptor

Fixture flow rate: (cu in / 231) = gal x 0.75 / 2 min = 2 min flow rate

NAME	TYPE	DIMENSIONS	QTY	CU IN	FLOW RATE
3 Compartment Sink	3 Compartment Sink	21" x 21" x 14" (3)	1	18,522	30.07 GPM
Dump Sink One Bowl	Dump Sink One Bowl	10" x 14" x 6"	2	1,680	2.72 GPM
Floor Sink	Floor Sink	N/A	1	N/A	0 GPM
Hand Sink	Hand Sink	10" x 14" x 5"	3	2,100	3.42 GPM
Ice Machine (with drain)	Ice Machine (with drain)	N/A	3	N/A	1.5 GPM
Mop Basin	Mop Basin	24" x 24" x 10"	1	5,760	9.35 GPM
Prep Sink One Bowl	Prep Sink One Bowl	21" x 21" x 14"	1	6,174	10.02 GPM

Total 57.08 GPM

Step 2: Grease Production

Servings per day x Grease production value x Days between pump-outs = Grease output

Servings per day: 1000

Grease production value: 0.0065 lbs per serving (Coffee Shop: Low / Flatware)

Days between pump-outs: 90 days

1000 x 0.0065 x 90 = 585 lbs of FOG

SCHIER MODEL	Description:
GB-75	GREASE INTERCEPTOR 75 GPM, 4" PLAIN/FPT CONNECTIONS, H-20 RATED PICKABLE CAST IRON COVER Dimensions: Length: 47", Width: 33", Height: 39.75" Flow Rate/Grease Capacity: 75 GPM / 861 lbs Liquid Capacity: 125 gal

Specification Note: This Great Basin model has been sized to the flow rate and grease production requirements of the application and may not be substituted by liquid capacity alone. Any substitution requests must be approved by the specifying engineer and the authority having jurisdiction.

Please contact support@schierproducts.com for technical and procurement support for the specified Great Basin model.

DOMESTIC WATER DEMAND							
PER TABLE E103.3(2), FBC 8TH EDITION (2023) - PLUMBING							
DESCRIPTION	QTY	COLD		HOT		TOTAL WSFU	
		EACH	TOTAL	EACH	TOTAL	EACH	TOTAL
JANITOR SINK	1	2.25	2.25	2.25	2.25	3.0	3.00
KITCHEN FIXTURE (LOW FLOW)	1	0.25	0.25	-	-	0.25	0.25
KITCHEN FIXTURE (MEDIUM FLOW)	3	1.5	4.50	1.5	4.50	2.0	6.00
KITCHEN FIXTURE (HIGH FLOW)	1	2.25	2.25	2.25	2.25	3.0	3.00
KITCHEN HAND SINK	2	1.5	3.00	1.5	3.00	2.0	4.00
LAVATORY (PUBLIC)	2	1.5	3.00	1.5	3.00	2.0	4.00
SERVICE SINK	3	2.25	6.75	2.25	6.75	3.0	9.00
WATER CLOSET (FLUSH TANK, PUBLIC)	2	5.0	10.00	-	-	5.0	10.00
TOTAL	-	-	32.00	-	21.75	-	39.25

VELOCITY 6FT / SEC MAX DEMAND FLOW = 26 GPM
DEMAND FLOW PER TABLE E103.3(3), FBC 8TH EDITION (2023) - PLUMBING SERVICE LINE SIZE = 1-1/4"Ø

WATER SERVICE CALCULATION	
TOTAL FIXTURE UNITS	39.25 TFU
TOTAL DEMAND FLOW	26 GPM
SERVICE SIZE	1-1/4"Ø
WATER VELOCITY	5.58 FT/SEC
PP PIPE LOSS	4.47 PSIG/100
LEQ	110 FT
HEIGHT OF BUILDING	10 FT

(PF) + (PV) + [(LEQ/100) X PP] + (H/2.3) + (PV) = PS @ FLOW

(25) + (5) + [(110/100) X 4.47] + (10/2.3) + (5) = 44.26 @ 26 GPM

PS = REQUIRED SERVICE PRESSURE (AT BLDG ENTRANCE, AT FLOW AFTER METER)
PF = PRESSURE REQUIRED AT THE FIXTURE OR FLUSH VALVE. MOST FIXTURES 10 -15 PSIG FLUSH VALVES 20-25 PSIG.
PV = PRESSURE LOSS ACROSS THE MAIN ISOLATION VALVE AND THE LOCAL ISOLATION VALVE (PSIG)
PP = PRESSURE LOSS IN PIPE AT FLOW PSIG/100 FT OF PIPE REF FBC-P FIGURES E103.3(3) TYPE L COPPER PIPE

LEQ = TOTAL EQUIVALENT PIPE LENGTH INCLUDING FITTINGS. THIS IS APPROXIMATELY EQUAL TO 1.5 TIMES THE DEVELOPED PIPE LENGTH FROM THE MAIN ISOLATION VALVE TO THE FARTHEST FIXTURE. (FEET)
H = HEIGHT OF THE HIGHEST FIXTURE ABOVE GROUND LEVEL. (FEET)

PLUMBING FIXTURE SCHEDULE - "P"						
DESIGN ID	COUNT	DESCRIPTION	FURN. BY	INST. BY	COMMENTS	
DRAIN						
10294	8	DRAIN - FLOOR SINK SQUARE - SIN 125MM				
10726	8	DRAIN - GRATE HALF SQUARE - 12IN 305MM				
FAUCET						
10152	2	FAUCET - DOUBLE LABORATORY WITH BENT RISER SPOUT	SB	GC		
10153	3	FAUCET - WATER TOWER - 12IN 305MM				
10215	1	FAUCET - DOUBLE LABORATORY WITH SWING SPOUT				
10597	2	FAUCET - SINGLE HANDLE	SB	GC		
10922	1	FAUCET - MOP SINK WALL MOUNTED				
11003	2	FAUCET - METERED				
22642	2	FAUCET - INSTANTHOT SYSTEM 2 BUTTON WITH BOILER AND BRACKET				KIT INCLUDES FONT, UNDERCOUNTER BOILER AND BOILER BRACKET FOR SIDE PANEL MOUNTING. BRACKET CAN BE FLOOR MOUNTED USING SET OF (4) STAINLESS STEEL LEGS. ORDERED SEPARATELY THROUGH VENDOR.
FILTER						
12501	1	FILTER - RO SYSTEM 600GPD				
12507	1	FILTER - RO SYSTEM 40GAL STORAGE TANK				
12896	1	FILTER - BRINE TANK				
12899	2	FILTER - POLY GLASS VESSEL				
13082	1	FILTER - WATER SOFTENER TWIN				
OTHER						
22226	1	WATER HEATER TANK ELECTRIC - 18KW				
SINK						
10549	2	SINK - RINSE DROP IN SST - 12X20IN 305X510MM	SB	GC		
10995	1	SINK - MOP - 24X24IN 610X610MM				
17565	1	SINK - RINSE WITH DRAINBOARD - 15X27IN 380X685MM				
22768	2	SINK - COUNTERTOP RINSER WITH WATER TOWER - 26X9IN 660X235MM				

SANITARY DEMAND			
(BASED ON FBC 8TH EDITION (2023) PLUMBING, TABLE 709.1)			
DESCRIPTION	#	DFU EA.	TOTAL DFU
INDIRECT WASTE RECEPTOR (2"Ø TRAP)	1	3	3.0
INDIRECT WASTE RECEPTOR (3"Ø TRAP)	8	5	40.0
JANITOR SINK	1	2	2.0
KITCHEN SINK, DOMESTIC	3	2	6.0
TOTAL =			51.0

MAXIMUM ALLOWABLE BUILDING DRAIN SIZE @ 1/8" / FT:
FLORIDA BUILDING CODE 8TH EDITION (2023) - PLUMBING, TABLE 710.1(1))
3" = 36 FU
4" = 180 FU
6" = 700 FU
8" = 1600 FU
10" = 2900 FU

PLUMBING DRAIN SCHEDULE					
MARK	ITEM	MANUFACTURER	MODEL	STRAINER HEAD (IN)	NOTES
FS-1	FLOOR SINK	ZURN	Z1900	12" X 12"	1, 2, 3

NOTES:
1. COORDINATE FINISH WITH THE ARCHITECT AND/OR OWNER.
2. PROVIDE A TRAP PRIMER CONNECTION FROM THE FACTORY.
3. COORDINATE SPECIFIC DRAIN OUTLET SIZE & CONNECTION TYPE WITH CONNECTED PIPE. REFERENCE PLANS FOR DRAIN PIPE DIMENSIONS. PROVIDE TRANSITIONS AS REQUIRED.



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PROJECT NAME:
A1A & 10TH

PROJECT ADDRESS:
**975 3RD STREET SOUTH
JACKSONVILLE BEACH, FL 32250**

STORE #: 8565
PROJECT #: 18756-108
ISSUE DATE: 03-27-2024
DESIGN MANAGER: ROMINA VIGNOLO
PRODUCTION DESIGNER: GENSLER
CHECKED BY: GENSLER

Revision Schedule			
Rev	Date	By	Description


SHEET TITLE:
PLUMBING SCHEDULES

SCALE: AS SHOWN


SHEET NUMBER:
P301

PERMIT SET - FOR CONSTRUCTION USE


EQUIPMENT DRAIN LINE TO BE PIPED TO FLOOR SINK AS SHOWN BY P.C. BEFORE EQUIPMENT IS SET IN PLACE BY K.E.C. FINAL CONNECTION SHALL BE BY P.C.
NOTE: END OF DRAIN LINE MUST BE MINIMUM 1-1/2" ABOVE GRATE.

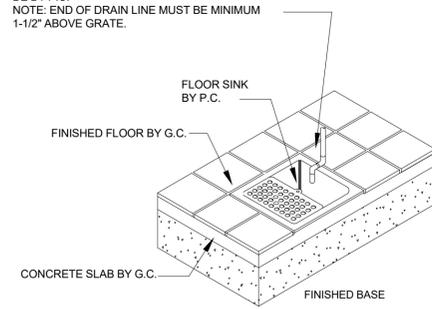


1 FLOOR SINK INSTALLATION N.T.S.

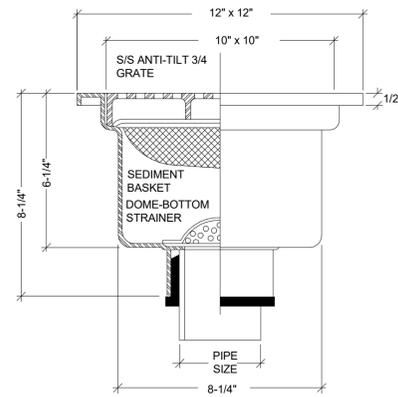


2 FLOOR SINK SECTION N.T.S.

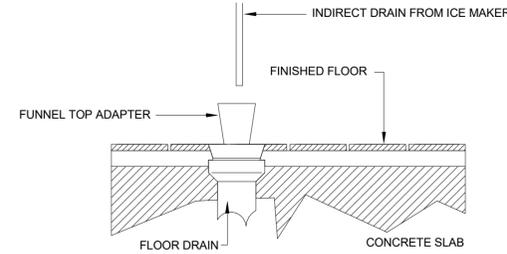


3 FUNNEL DRAIN N.T.S.

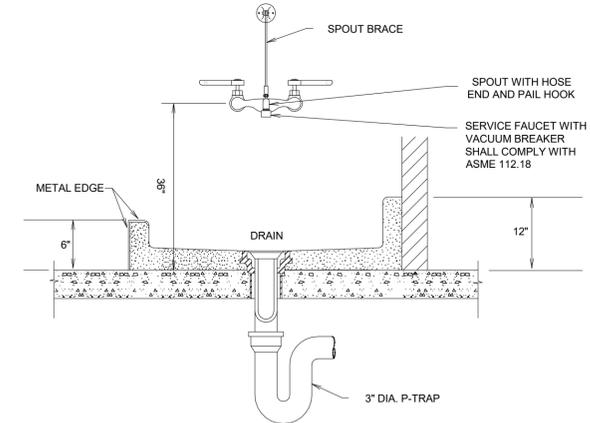


4 MOP SINK INSTALLATION N.T.S.

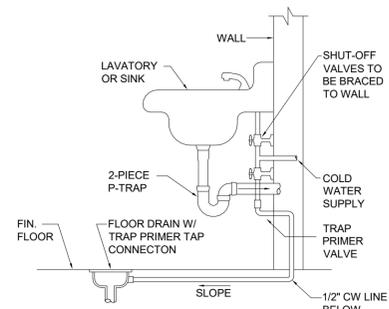


5 TRAP PRIMER INSTALLATION N.T.S.

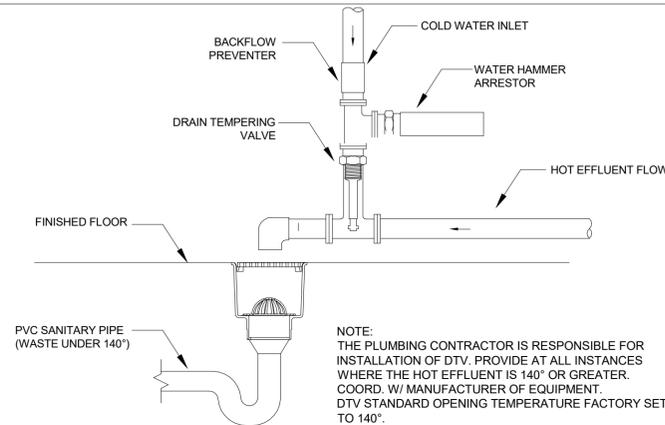


6 DRAIN TEMPERING VALVE FOR DISHWASHER N.T.S.

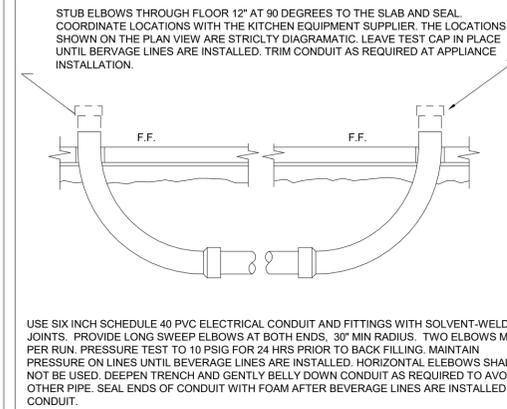


7 BEVERAGE CONDUIT DETAIL N.T.S.

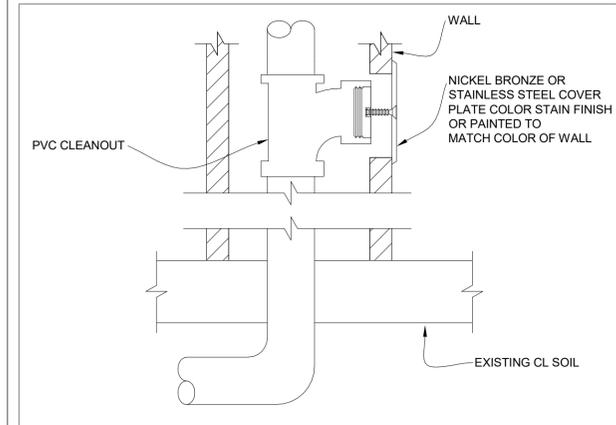


8 CLEAN OUT DETAIL N.T.S.

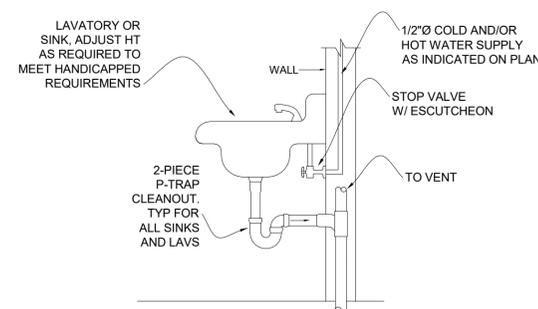


9 SINK/LAV INSTALLATION N.T.S.

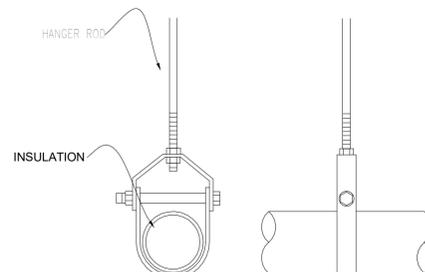

10 PIPE HANGER DETAIL N.T.S.

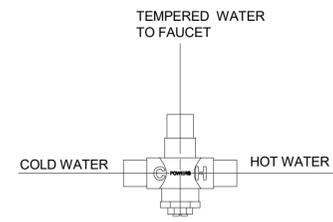

11 TEMPERING VALVE AT FIXTURES N.T.S.

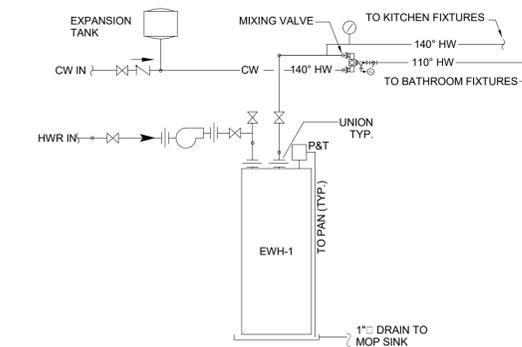

12 WATER HEATER DETAIL N.T.S.



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SHEET TITLE:
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SCALE: AS SHOWN

SHEET NUMBER:
P401